
LATINO COMMUNITY CREDIT UNION

9521 CHAPEL HILL RD. MORRISVILLE, NC 27560

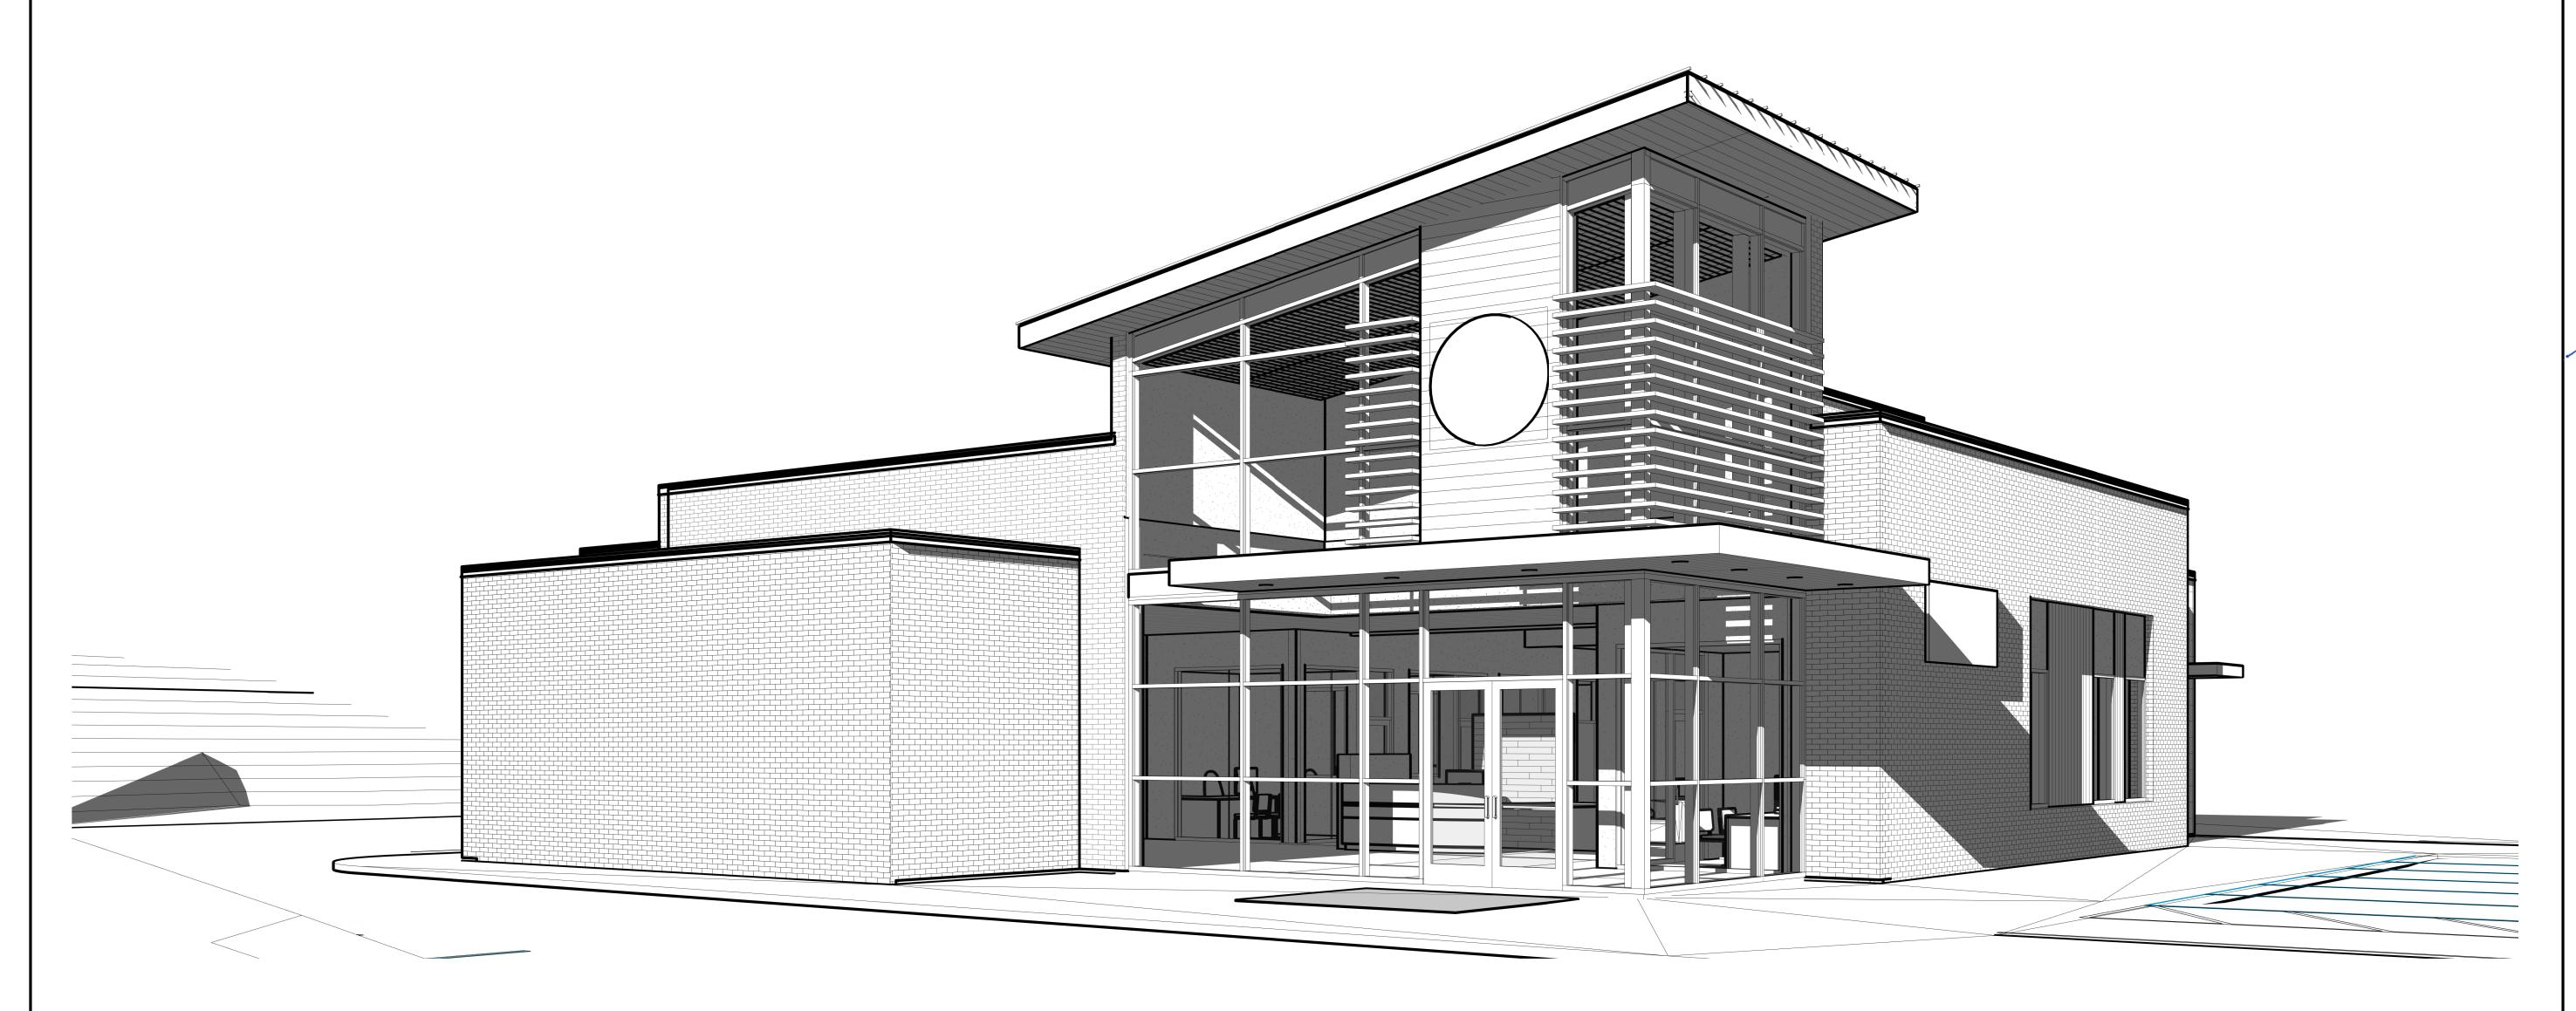

	INDEX TO DRAWINGS									
	GENERAL	CIVIL	STRUCTURAL	ARCHITECTURAL	PLUMBING	MECHANICAL	ELECTRICAL			
G001 G002 G003 G101	ARCHITECTURAL COVER SHEET NOTES, SYMBOLS & ABBREVIATIONS APPENDIX B LIFE SAFETY PLAN	C0.00 COVER SHEET V0.01 ALTA (BY OTHERS) V0.02 ALTA (BY OTHERS) V0.03 ALTA (BY OTHERS) V0.04 ALTA (BY OTHERS) C1.00 DEMOLITION AND TREE PROTECTION PLAN C2.00 SITE PLAN C2.01 PAVEMENT AND SIGNAGE PLAN C2.02 ADA PATH C2.03 FIRE TRUCK ACCESS PLAN C3.00 GRADING AND DRAINAGE PLAN C3.01 GRADING AND DRAINAGE PLAN C4.00 UTILITY PLAN C6.00 EROSION CONTROL PLAN - STAGE 1 C6.01 EROSION CONTROL PLAN - STAGE 1 C6.02 EROSION CONTROL PLAN - STAGE 2 C6.03 EROSION CONTROL PLAN - STAGE 2 C6.04 EROSION CONTROL PLAN - BTAGE 2 C6.05 EROSION CONTROL PLAN DETAILS C6.06 EROSION CONTROL PLAN DETAILS C6.06 EROSION CONTROL PLAN DETAILS C6.07 EROSION CONTROL PLAN DETAILS C6.08 EROSION CONTROL PLAN DETAILS C6.09 USITE DETAILS C8.00 SITE DETAILS C8.01 SITE DETAILS C8.01 SITE DETAILS C8.03 SEWER DETAILS C8.04 DRAINAGE DETAILS C8.05 DRAINAGE DETAILS C8.06 DETAILS C8.07 LANDSCAPE PLAN L5.01 LANDSCAPE PLAN L5.01 LANDSCAPE PLAN L5.01 LANDSCAPE DETAILS SL2.0 LIGHTING PLAN	S001 GENERAL NOTES S002 3D VIEWS S003 GENERAL SCHEDULES S004 SPECIAL INSPECTIONS S005 PEMB DESIGN CRITERIA & PERFORMANCE REQUIREMENTS (1 OF #) S100 FOUNDATION PLAN S200 MAIN ROOF FRAMING PLAN S201 HIGH ROOF FRAMING PLAN S301 TYPICAL SLAB-ON-GRADE & FOUNDATION DETAILS S401 TYPICAL STEEL DETAILS S501 FOUNDATION DETAILS S601 FRAMING DETAILS S602 FRAMING DETAILS	A001 ASSEMBLY TYPES A002 PARTITION TYPES A101 FIRST FLOOR PLAN A102 ROOF PLAN A111 FIRST FLOOR REFLECTED CEILING PLAN A201 EXTERIOR ELEVATIONS A202 EXTERIOR ELEVATIONS A301 BUILDING SECTIONS A302 BUILDING SECTIONS A310 WALL SECTIONS A311 WALL SECTIONS A311 WALL SECTIONS A312 WALL SECTIONS A401 ENLARGED TOILET PLANS, ELEVATIONS AND TYPICAL MOUNTING HEIGHTS A402 ENLARGED PLANS AND INTERIOR ELEVATIONS A410 MILLWORK DETAILS A501 PLAN DETAILS A501 PLAN DETAILS A502 SECTION AND CEILING DETAILS A503 PARAPET AND ROOF DETAILS A504 ROOF DETAILS A601 DOOR SCHEDULE AND DETAILS A602 STOREFRONT TYPES A603 STOREFRONT AND HM DETAILS	P001 PLUMBING LEGEND SHEET P101 FIRST FLOOR DOMESTIC WATER PLAN P102 ROOF GAS PIPING PLAN P201 FIRST FLOOR SANITARY/WASTE PLAN P202 ROOF SANITARY/WASTE PLAN P401 PLUMBING ENLARGED/ISOMETRIC PLANS P501 PLUMBING DETAILS P601 PLUMBING SCHEDULES	M001 MECHANICAL LEGEND SHEET M101 FIRST FLOOR MECHANICAL PLAN M201 ROOF MECHANICAL PLAN M501 MECHANICAL DETAILS M502 MECHANICAL DETAILS M601 MECHANICAL SCHEDULES	E001 ELECTRICAL COVER SHEET E051 ELECTRICAL SITE PLAN E101 ELECTRICAL FLOOR PLAN E102 ELECTRICAL ROOF PLAN E201 SECURITY FLOOR PLAN E301 LIGHTING CEILING PLAN E401 ELECTRICAL DETAILS AND RISER DIAGRAM			
	LaBELLA ASSOCIATES 400 S. TRYON STREET, SUITE 1300 CHARLOTTE, NC 28285 704.376.6423	THE JOHN R. MCADAMS COMPANY 621 HILLSBOROUGH STREET, SUITE 500 RALEIGH, NC 27603 919.361.5000	Labella Associates 400 S. Tryon Street, Suite 1300 Charlotte, NC 28285 704.376.6423	Labella Associates 400 S. Tryon Street, Suite 1300 CHARLOTTE, NC 28285 704.376.6423	LaBELLA ASSOCIATES 400 S. TRYON STREET, SUITE 1300 CHARLOTTE, NC 28285 704.376.6423	LaBELLA ASSOCIATES 400 S. TRYON STREET, SUITE 1300 CHARLOTTE, NC 28285 704.376.6423	Labella Associates 400 S. Tryon Street, Suite 1300 CHARLOTTE, NC 28285 704.376.6423			



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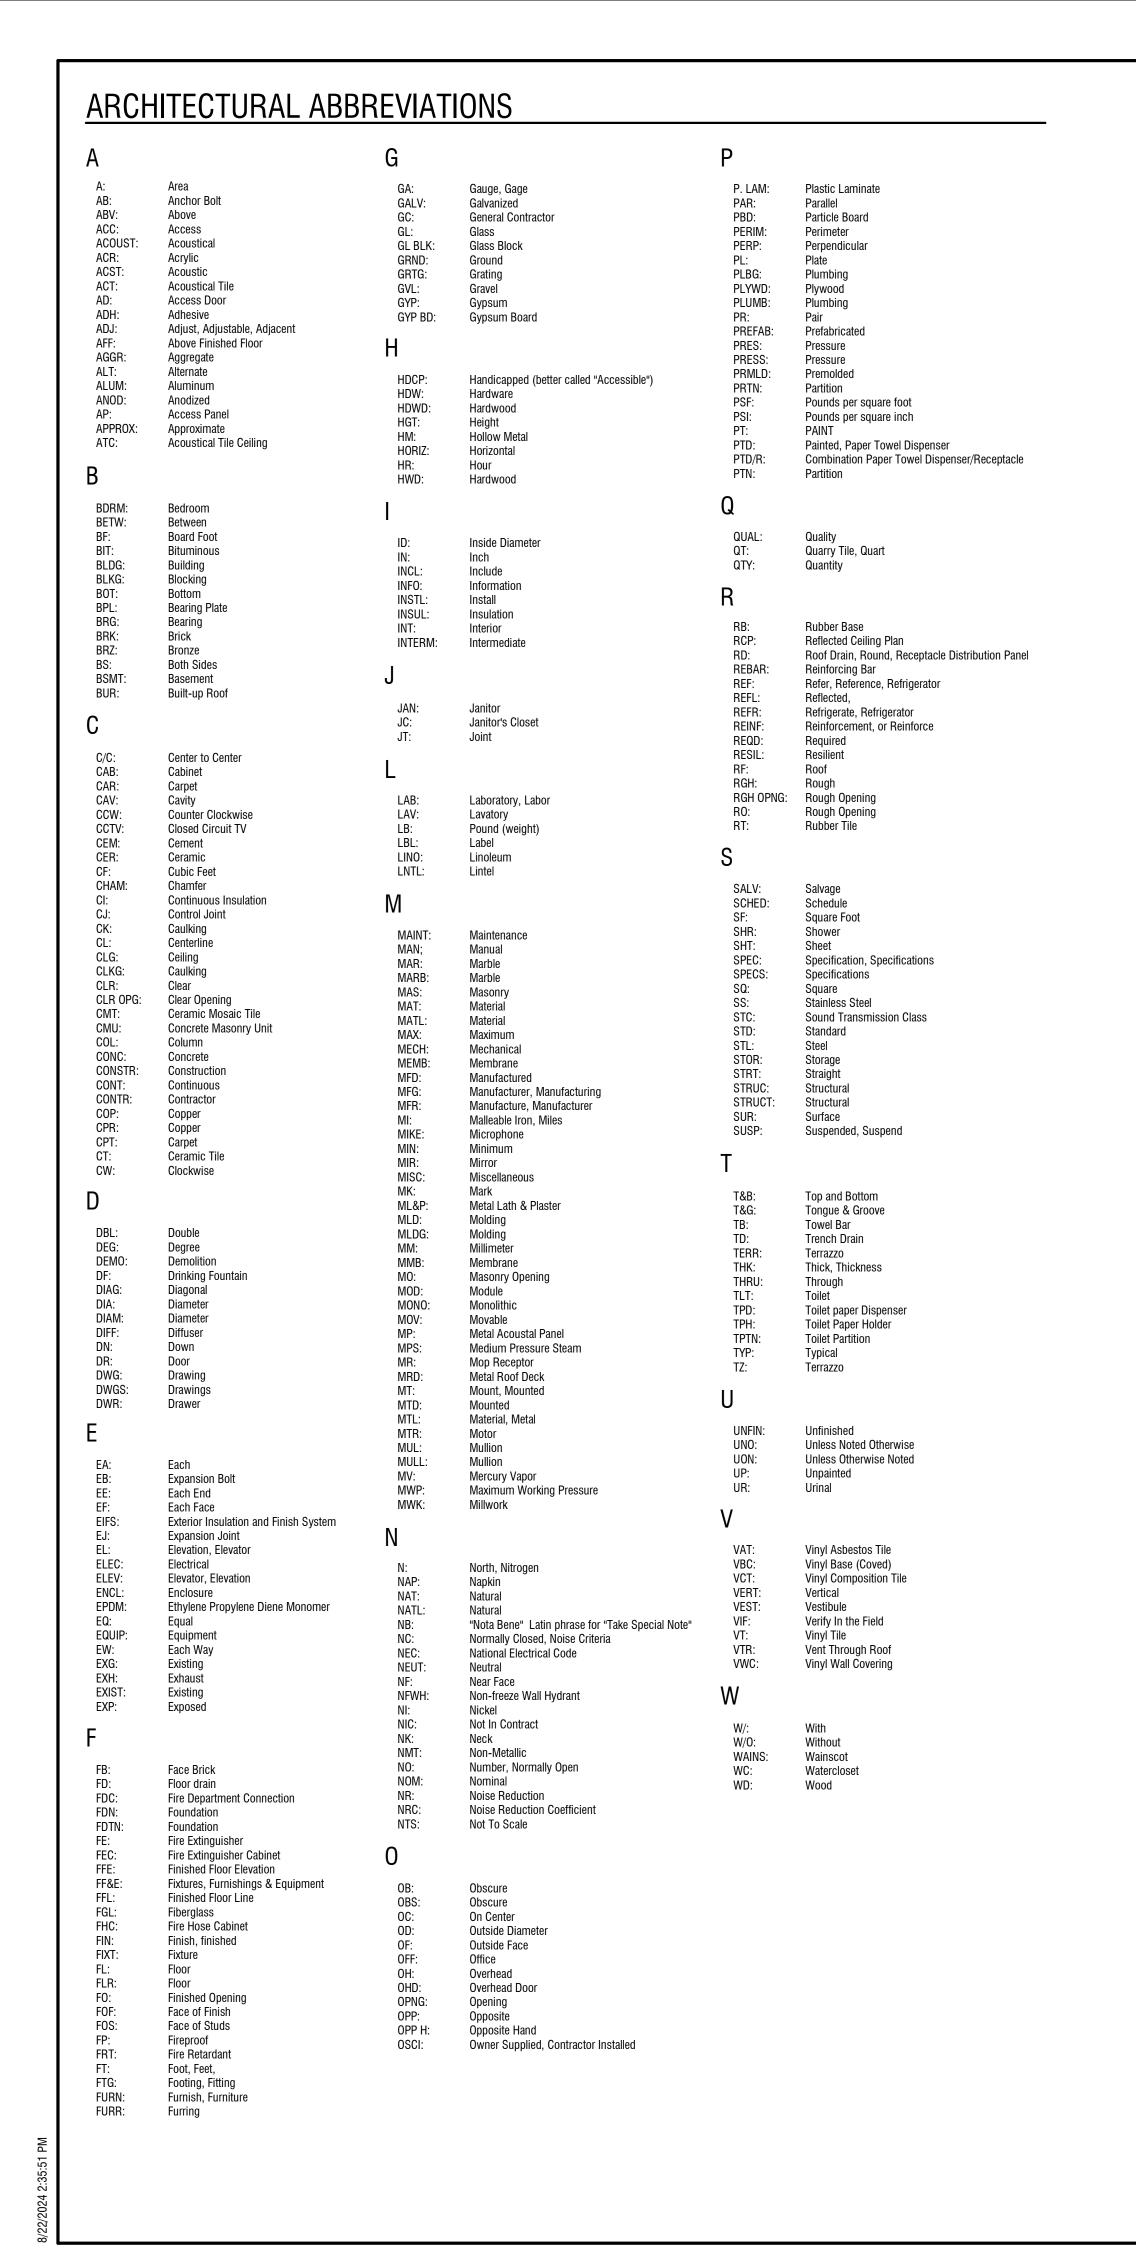
LCCU - Morrisville Site Adapt 9521 Chapel Hill RD. Morrisville, NC 27560

NO:	DATE:	DESCRIPTION:	
Revisions			
PROJECT	NUMBER:	2230150	
DRAWN B	Y:	BAW	
REVIEWED) BY:	GGA	
ISSUED FO	DR:	BID SET	
DATE:		08.23.2024	
DRAWING	NAME:		


ARCHITECTURAL COVER SHEET

DRAWING NUMBE


G001




MATERIAL SYMBOLS

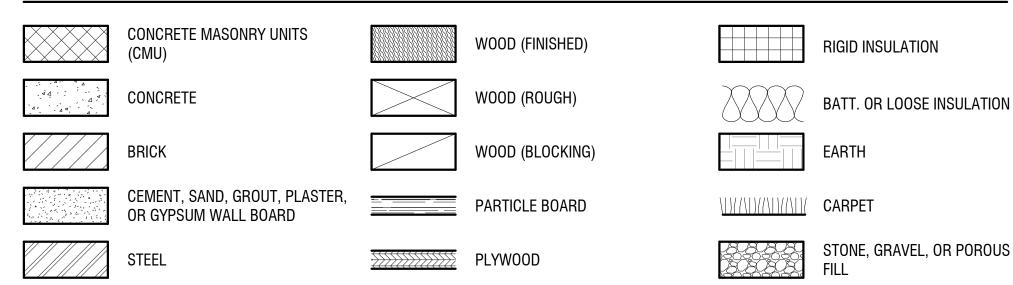

ARCHITECTURAL DRAWINGS SYMBOLS

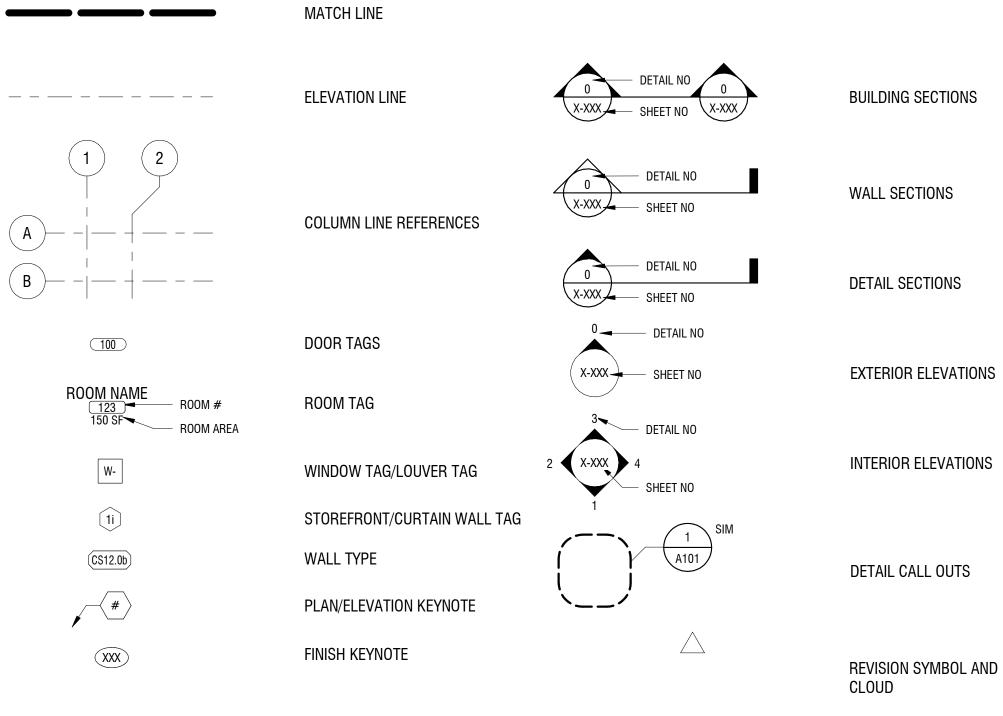

TYPICAL PLAN DIMENSIONING

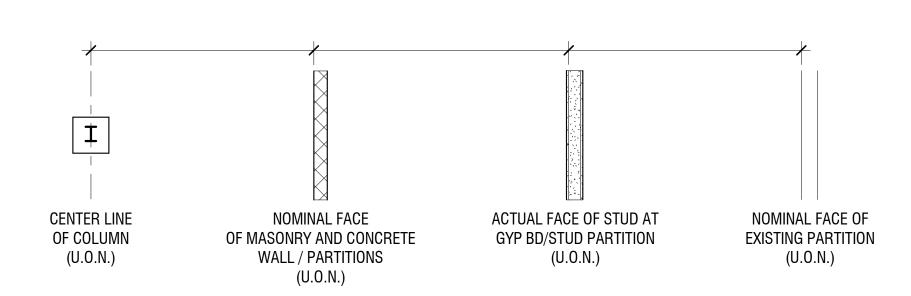

LINE TYPES

WALL/ PARTITION DESIGNATIONS

BRICK FACE
C.M.U. WALL / PARTITION - SEE PARTITION TYPES
 METAL STUD PARTITION - SEE PARTITION TYPES
EXISTING WALL CONSTRUCTION

GENERAL ARCHITECTURAL NOTES

- CONSTRUCTION SHALL CONFORM TO THE "NORTH CAROLINA STATE UNIFORM FIRE PROTECTION AND BUILDING CODE", LATEST REVISION, THE NORTH CAROLINA STATE ENERGY CODE AND ANY OTHER CODES GOVERNED BY THE JURISDICTION IN WHICH THE PROJECT IS BEING CONSTRUCTED.
- 2. ALL DRAWINGS ARE GRAPHIC REPRESENTATIONS OF APPROXIMATE LOCATIONS OF NEW MATERIALS. IT IS THE CONTRACTOR'S RESPONSIBILITY TO FIELD-VERIFY ALL CONDITIONS PRIOR TO COMMENCEMENT OF WORK. CONTRACTOR SHALL NOT SCALE THE DRAWINGS.
- 3. CONTRACTORS ARE RESPONSIBLE FOR ALL MATERIALS, CONSTRUCTION METHODS AND CRAFTSMANSHIP.
- 4. CONTRACTORS ARE TO VERIFY ALL EXISTING CONDITIONS, REQUIREMENTS, NOTES, CODES AND DIMENSIONS, PRIOR TO THE START OF CONSTRUCTION AND SHALL NOTIFY THE ARCHITECT, IN WRITING, IF CONDITIONS VARY FROM THOSE SHOWN ON THE DOCUMENTS.
- 5. CONTRACTORS ARE RESPONSIBLE FOR COORDINATING WORK WITH OTHER TRADES WHEREVER THEY OVERLAP. THOROUGHLY COORDINATE WORK AND DETERMINE EXACT ROUTE AND LOCATION OF UTILITIES, MATERIALS AND EQUIPMENT BEFORE FABRICATION AND INSTALLATION. NOTIFY THE ARCHITECT/ENGINEER IN WRITING IF FIELD CONDITIONS VARY FROM THOSE SHOWN ON THE DOCUMENTS.
- 6. PROVIDE ALL BLOCKING, FURRING AND SHIMMING FOR INSTALLATION AND COMPLETION OF WORK, INCLUDING BLOCKING FOR CASEWORK, EQUIPMENT, AND TOILET ACCESSORIES.
- 7. ALL WORK SHALL BE PLUMB, LEVEL AND SQUARE. SCRIBE AND MAKE FIT ALL NEW TO NEW.
- 8. PROVIDE CONCEALED BLOCKING IN ALL STUD PARTITIONS AND WALLS BEHIND SURFACE FOR SEMI-

RECESSED, FULLY RECESSED OR SURFACE MOUNTED ACCESSORIES AND MILLWORK.

- 9. CONTRACTOR SHALL FIELD VERIFY FINISHED DIMENSIONS AND CLEARANCES IN SPACES INDICATED TO RECEIVE BUILT-IN FURNISHINGS OR CASEWORK PRIOR TO FARRICATION
- RECEIVE BUILT-IN FURNISHINGS OR CASEWORK PRIOR TO FABRICATION.

 10. FINISHED DOOR OPENINGS SHALL BE NOMINAL 6" FROM FINISHED CORNER OF ROOM EXCEPT WHERE
- DIMENSIONED OTHERWISE.

 11. SEALANT SHALL BE PROVIDED AT THE INTERIOR AND EXTERIOR PERIMETER OF ALL WINDOWS, DOOR
- FRAMES, LOUVERS OR OTHER ITEMS INSERTED IN AN EXTERIOR WALL.

 12. SUSPENDED GRID CEILINGS SHALL BE ARRANGED SO THAT A GRID IS SPACED EQUALLY FROM EACH
- MOST REMOTE WALL, IN EACH DIRECTION, WITH NO TILES LESS THAN 6" UNLESS OTHERWISE INDICATED.
- 13. WOOD USED FOR BLOCKING OR OTHER PURPOSES ON OR ABOVE THE ROOF DECK, WITHIN 2'-0" OF GRADE AND IN OTHER LOCATIONS OUTSIDE THE BUILDING ENVELOPE WHERE EXPOSED TO THE WEATHER SHALL BE PRESSURE TREATED LUMBER OR PLYWOOD.
- 14. INSTALL ALL WORK AS INDICATED AND VERIFY EXACT LOCATION AND ELEVATIONS ON THE JOB.
- 15. DO NOT SCALE DRAWINGS. REFER TO DIMENSIONS AND SPECIFIED MATERIALS. CONTACT THE ARCHITECT IF ADDITIONAL DIMENSIONS ARE REQUIRED.
- 16. COORDINATE ALL DOOR HARDWARE, TRIM AND FINISHES TO MEET INTENT AND COMPLIANCE.
- 17. VERIFY ALL DIMENSIONS BEFORE ORDERING MATERIAL OR DOING WORK. NO EXTRA COMPENSATION OR CHARGES WILL BE ACCEPTED DUE TO DIFFERENCES BETWEEN THE ACTUAL MEASUREMENTS AND MEASUREMENTS INDICATED ON THE DRAWINGS.
- 18. ALL DETAILS ARE SUBJECT TO CHANGE DUE TO EXISTING FIELD CONDITIONS. CONTRACTOR MUST NOTIFY ARCHITECT IN WRITING OF ANY DISCREPANCIES.
- 19. CONTRACTORS ARE RESPONSIBLE FOR OBTAINING AND PAYING FOR ALL PERMITS ASSOCIATED WITH THE WORK OF THEIR CONTRACT.
- 20. SECURITY, WEATHERPROOFING, DUST CONTROL AND SAFETY SHALL BE THE FULL RESPONSIBILITY OF THE CONTRACTOR. CONTRACTOR SHALL PERFORM CLEAN UP OF ALL REFUSE, RUBBISH, SCRAP MATERIALS AND DEBRIS CAUSED BY THE WORK ON A DAILY BASIS.
- 21. G.C. TO ENSURE ALL TRADES RECEIVE A FULL SET OF DRAWINGS FOR PROPER COORDINATION BETWEEN ALL TRADES.

VICINITY MAP

22. ALL FURNITURE, EQUIPMENT, LOOSE SHELVING AND APPLIANCES TO BE FURNISHED AND INSTALLED BY OWNER. SHOWN FOR REFERENCE ONLY.

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LCCU - Morrisville Site Adapt

9521 Chapel Hill RD. Morrisville, NC 27560

NO:	DATE:	DESCRIPTION:	
Revisions	DAIL.	DESCRIPTION.	
PROJECT	NUMBER:	2230150	
DRAWN B	Y:	BAW	
REVIEWE	D BY:		
		GGA	
ISSUED FO	OR:	BID SET	
DATE:		08.23.2024	
DRAWING	NAME:		

NOTES, SYMBOLS & ABBREVIATIONS

DRAWING NUMBER:

G002

2018 APPENDIX B

Name of Project	ct: LCCU - Morrisville	avilla NC			
	Chapel Hill RD. Morris		10.505.4700		Zip Code <u>27560</u>
	zed Agent: Etna Claro			_	etna@latinocci
Owned By: -		City/County	Private		tate -
Code Enforcem	nent Jurisdiction:	City_Raleigh	_ County <u>W</u>	′ake	tate <u>North Caroli</u>
CONTACT:					
DESIGNER	FIRM	NAME	LICENSE #	TELEPHONE #	E-MAIL
Architectural	Labella Associates, P.C.	Gabe Antenucci	15476	704.887.7246	gantenucci@labellapc.co
Civil	Labella Associates, P.C.	James Henderson	16329	704.941.2107	jhenderson@labellapc.co
Electrical Fire Alarm	Labella Associates, F.G.	Janies nenuerson		- 104.941.2107	- Juenderson@iabeliapc.co
Plumbing	Labella Associates, P.C.	Michael Grose	047719	704.941.2122	mgrose@labellapc.com
Mechanical	Labella Associates, P.C.	Michael Grose	047719	704.941.2122	mgrose@labellapc.com
Sprinkler-Stand	dpipe	-			-
Structural	Labella Associates, P.C.	Dan Hill	040156	704.941.2130	dhill@labellapc.com
	s >5' High				-
Other	. -	 	_ 		
("Other" should	include firms and indi	ividuals such as tru	ıss, precast, pre-	-engineered, inte	erior designers, et
2018 NC BUIL	DING CODE: Ne	ew Building] Shell/Core	☐ 1st Time I	nterior Completio
		_	- ີ∣Phased Constr		•
2040 NC EVIC	TING BUILDING COD			_	
				_	Historic Prope
(check all that a	apply)	☐ Repair	Alteration	_	☐ Change of Use
		☐ Chapter 14	☐ Alteration	on Level III	
CONSTRU	ICTED: (date)	CURRE	NT OCCUPANO	CY(S) (Ch 3)	
	0 : ==: (/			, (O) (O.I. O)	
RENOVAT				·	
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This separation is not exempt as a Non-Separated Use (see exceptions).

Actual Area of Occupancy A (3,428) + Actual Area of Occupancy B (5,338)

a. Perimeter which fronts a public way or open space having 20 feet minimum width = _____ (F)

4 The maximum area of open parking garages must comply with Table 406.5.4. The maximum area of air traffic

3 Maximum Building Area = total number of stories in the building x D (maximum3 stories) (506.2).

BLDG AREA PER

1 Frontage area increases from Section 506.2 are computed thus:

5 Frontage increase is based on the unsprinklered area value in Table 506.2.

b. Total Building Perimeter = ____(P)

2 Unlimited area applicable under conditions of Section 507.

Special Uses (Chapter 4 – List Code Sections):

DESCRIPTION AND

c. Ratio (F/P) = _____ (F/P)

d. W = Minimum width of public way = ___

control towers must comply with Table 412.3.1.

Business

STORY

Special Provisions: (Chapter 5 – List Code Sections):

Mixed Occupancy: NO Separation: - Exception: _____

Assumed and real property line locations (if not on the site plan) shown on sheet C2.0

Exterior wall opening area with respect to distance to assumed property lines (705.8)

Occupant loads for each area

Common path of travel distances (Tables 1006.2.1 & 1006.3.2(1))

< 1.00

(D)

STORY OR UNLIMITED2,3

23,000

___ + = __-

(C)

INCREASE1,5

TABLE 506.24 AREA FOR FRONTAGE | ALLOWABLE AREA PER

NA Dead end lengths (1020.4)

Clear exit widths for each exit door

purposes of occupancy separation

Location of doors with electromagnetic egress locks (1010.1.9.9)

M Location of doors equipped with hold-open devices

MA The square footage of each fire area (202)

The square footage of each smoke compartment for Occupancy Classification I-2 (407.5)

Note any code exceptions or table notes that may have been utilized regarding the items above

ALLOWABLE HEIGHT

	ALLOWABLE	SHOWN ON PLANS	CODE REFERENCE
Building Height in Feet (Table 504.3)	55'-0"	29'-1"	504.3
Building Height in Stories (Table 504.4)	3	1	504.4
1 Provide code reference if the "Shown on Plans" quantity	y is not based on Table 504.	.3 or 504.4.	

FIRE PROTECTION REQUIREMENTS

BUILDING ELEMENT	FIRE		RATING	DETAIL#	DESIGN#	SHEET # FOR	SHEET#
	SEPARATION DISTANCE	REQ'D	PROVIDED *	AND SHEET#	FOR RATED	RATED PENETRATION	FOR RATED
	(FEET)		REDUCTION)	OHEET #	ASSEMBLY	- ENE HOUNDIN	JOINTS
Structural Frame,							
including columns,	_	0	_	_			_
girders, trusses	<u>-</u>	"	_		_		
Bearing Walls	-	0	-	-	-	-	ı
Exterior	-	0	-	-	-	-	-
North	-	N.R.	-	-	-	-	-
East	-	N.R.	-	-	-	-	-
West	-	N.R.	-	-	-	-	-
South	-	N.R.	-	-	-	-	-
Interior	-	0	-	-	-	-	-
Nonbearing Walls and Partitions	_	0	-	-	-	-	-
Exterior walls							
North	-	N.R.	-	-	-	-	-
East	-	N.R.	-	-	-	-	-
West	-	N.R.	-	-	-	-	-
South	-	N.R.	_	-	-	_	-
Interior walls and partitions	-	0	_	-	-	_	-
Floor Construction				!			
Including supporting beam	ıs .	-	-	-	_	-	-
and joists							
Floor Ceiling Assembly		-	_	-	-	_	-
Columns Supporting Floors		-	-	_	-	-	-
Roof Construction, including	1						
supporting beams and joists	; ;	-	-	-	-	-	-
Roof Ceiling Assembly		-	-	-	-	-	-
Columns Supporting Roof		-	-	-	-	-	-
Shaft Enclosures - Exit		-	-	-	-	-	-
Shaft Enclosures - Other							
		-	-	-	-	-	-
Corridor Separation		-	-	-	-	-	-
Occupancy/Fire Barrier Sep	aration	-	-	-	-	-	-
Party/Fire Wall Separation		-	-	-	-	-	-
Smoke Barrier Separation		-	-	-	-	-	-
Smoke Partition		-	-	-	-	-	-
Tenant/Dwelling Unit/ Sleeping Unit Separation		_	-	-	-	_	-
Incidental Use Separation		-	_	-	_	-	-

Indicate section number permitting reduction PERCENTAGE OF WALL OPENING CALCULATIONS

FIRE SEPARATION DISTANCE (FEET) FROM PROPERTY LINES	DEGREE OF OPENINGS PROTECTION (TABLE 705.8)	ALLOWABLE AREA (%)	ACTUAL SHOWN ON PLANS (%)
North	Unprotected, Nonsprinklered	No Limit	-
South	Unprotected, Nonsprinklered	No Limit	-
East	Unprotected, Nonsprinklered	No Limit	-
West	Unprotected, Nonsprinklered	No Limit	-

LIFE SAFETY SYSTEM REQUIREMENTS

Emergency Lighting:	Yes No
Exit Signs:	Yes No
Fire Alarm:	☐ Yes ■ No
Smoke Detection Systems:	☐ Yes ■ No ☐ Partial: Duct Detectors
Carbon Monoxide Detection:	☐ Yes ■ No
Emergency Generator:	☐ Yes ■ No

REQUIREMENTS

	LIFE SAFETY PLAN RE
ife Safety Plan Sheet #	G101

NA Fire and/or smoke rated wall locations (Chapter 7)

Occupancy Use for each area as it relates to occupant load calculation (Table 1004.1.2)

Exit access travel distances (1017)

Maximum calculated occupant load capacity each exit door can accommodate based on egress width (1005.3) Actual occupant load for each exit door

A separate schematic plan indicating where fire rated floor/ceiling and/or roof structure is provided for

NA Location of doors with panic hardware (1010.1.10)

Location of doors with delayed egress locks and the amount of delay (1010.1.9.7)

NA Location of emergency escape windows (1030)

ACCESSIBLE DWELLING UNITS

			(SE	CTION	7)		
TOTAL UNITS	ACCESSIBLE UNITS	ACCESSIBLE UNITS	TYPE A UNITS	DYPE A UNITS	TYPE B UNITS	TYPE B UNITS	TOTAL ACCESSIBLE UNITS
_	REQUIRED -	PROVIDED -	REQUIRED -	PROVIDED -	REQUIRED -	PROVIDED -	PROVIDED -

ACCESSIBLE PARKING (SECTION 1106)

LOT OR PARKING AREA	TOTAL # OF PA	ARKING SPACES PROVIDED	# OF ACC		ESSIBLE SPACES PROVIDED VAN SPACES WITH		
			5' ACCESS AISLE	132" ACCESS	8' ACCESS	PROVIDED	
				AISLE	AISLE		
LOT 1	13	29	2	-	-	2	
-	-	-	-	-	-	-	
TOTAL -	-	-	-	-	-	-	

PLUMBING FIXTURE REQUIREMENTS (TARLE 2902 1)

					(IAE)LE 29(12.1)				
L	JSE	W	/ATERCLOS	ETS	URINALS	0	AVATORIE	S	SHOWERS	DRINKING	FOUNTAINS
		MALE	FEMALE	UNISEX		MALE	FEMALE	UNISEX	/ TUBS	REGULAR	ACCESSIBL
SPACE	EXIST'G	-	-	-	- ,	(3)	-	-	-	-	-
	NEW	-	-	-	- 💉	/ -	-	-	-	-	-
	REQ'D	-	-	-	5	-	-	-	-	-	-

SPECIAL APPROVALS

Special approval: (Local Jurisdiction, Department of Insurance, OSC, DPI, DHHS, etc., describe below)

ENERGY SUMMARY

ENERGY REQUIREMENTS: The following data shall be considered minimum and any special attribute required to meet the energy code shall also be provided. Each Designer shall furnish the required portions of the project information for the plan data sheet. If performance method, state the annual energy cost for the standard reference design vs annual energy cost for the proposed design.

Existing building envelope complies with code: Select one

Exempt Building: Select one Provide code or statutory reference:

Skylights in each assembly: _-

Climate Zone: 4

Method of Compliance: Energy Code - Perscriptive (If "Other" specify source here)

THERMAL ENVELOPE (Prescriptive method only)

Roof/ceiling Assembly (each assembly) TPO roofing o/protection board o/ R30 rigid o/ metal deck Description of assembly: R-Value of insulation:

R1.3

U-Value of skylight: _ total square footage of skylights in each assembly: -

Exterior Walls (each assembly) Fiber cement siding (& Brick w/ air space), R7.5 rigid, air and moisture barrier, 5/8" glassmat faced ext. sheathing Mtl. stud with R15 batt insulation, 5/8" GWB Description of assembly: U-Value of total assembly: R15 + 7.5ci R-Value of insulation: Openings (windows or doors with glazing) U-Value of assembly: Solar heat gain coefficient: .30

Door R-Values:

Walls below grade (each assembly) Description of assembly: U-Value of total assembly: __-R-Value of insulation: _____

Floors over unconditioned space (each assembly)

projection factor:

Description of assembly: U-Value of total assembly: __-___ R-Value of insulation: __-

Floors slab on grade

slab heated:

4" Reinforced concrete with 15 mil vapor barrier over 4" crushed gravel Description of assembly: U-Value of total assembly: __-R-Value of insulation: R15
Horizontal/vertical requirement: 2'-0" horizontal of R-15 rigid insulation

2018 APPENDIX B

BUILDING CODE SUMMARY FOR ALL COMMERCIAL PROJECTS

STRUCTURAL DESIGN (PROVIDE ON SHEET 1 OR 2 OF THE STRUCTURAL SHEETS) **DESIGN LOADS:**

Importance Factors: Wind (IW) Snow (IS) Seismic (IE) Live Loads: Mezzanine

Basic Wind Speed Wind Load: **Exposure Category**

Ground Snow Load:

SEISMIC DESIGN CATEGORY: Provide the following Seismic Design Parameter Occupancy Category (Table 1604.5) Basic structural system (check one)

Bearing Wall ☐ Dual w/Special Moment Frame Building Frame ☐ Dual w/Intermediate R/C or Special Steel Inverted Pendulum Analysis Procedure: Simplified Equivalent Lateral Force Dynamic Architectural, Mechanical, Components anchored? Yes No

LATERAL DESIGN CONTROL: Earthquake☐ Wind ☐

SOIL BEARING CAPACITIES: Field Test (provide copy of test report) _ Presumptive Bearing capacity _ Pile size, type, and capacity

2018 APPENDIX B

BUILDING CODE SUMMARY FOR ALL COMMERCIAL PROJECTS MECHANICAL DESIGN

MECHANICAL SUMMARY

(PROVIDE ON THE MECHANICAL SHEETS IF APPLICABLE)

MECHANICAL SYSTEMS, SERVICE SYSTEMS AND EQUIPMENT

Thermal Zone winter dry bulb: summer dry bulb: Interior design conditions winter dry bulb: _ summer dry bulb: __. relative humidity: Building heating load: Building cooling load: ____

Mechanical Spacing Conditioning System

Unitary description of unit: ____ heating efficiency: _-___ size category of unit: _ -Size category. If oversized, state reason.: Size category. If oversized, state reason.:

List equipment efficiencies:

2018 APPENDIX B BUILDING CODE SUMMARY FOR ALL COMMERCIAL PROJECTS

ELECTRICAL DESIGN (PROVIDE ON THE ELECTRICAL SHEETS IF APPLICABLE)

ELECTRICAL SUMMARY

ELECTRICAL SYSTEM AND EQUIPMENT

Method of Compliance: Select one Lighting schedule (each fixture type)

lamp type required in fixture number of lamps in fixture ballast type used in the fixture number of ballasts in fixture

total wattage per fixture total interior wattage specified vs. allowed (whole building or space by space) total exterior wattage specified vs. allowed

Additional Prescriptive Compliance

☐ 506.2.1 More Efficient Mechanical Equipment 506.2.2 Reduced Lighting Power Density 506.2.3 Energy Recovery Ventilation Systems 506.2.4 Higher Efficiency Service Water Heating 506.2.5 On-Site Supply of Renewable Energy

☐ 506.2.6 Automatic Daylighting Control Systems

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LCCU - Morrisville Site Adapt

9521 Chapel Hill RD. Morrisville, NC 27560

NO: DATE: DESCRIPTION: Revisions PROJECT NUMBER: 2230150 DRAWN BY: BAW **REVIEWED BY:** GGA ISSUED FOR: **BID SET** DATE:

08.23.2024

APPENDIX B

DRAWING NUMBER:

DRAWING NAME:

LIFE SAFETY LEGEND

- ACCESSIBLE EMERGENCY EGRESS EXIT

EXIT LIGHTREMOTE POINT

E.W. - DOOR EGRESS WIDTH

FEC - FIRE EXTINGUISHER CABINET- FULLY RECESSED
M.O.L. - MAXIMUM DOOR OCCUPANT LOAD
A.O.L. - ACTUAL DOOR OCCUPANT LOAD
U.L.D. - DOOR UNLOCKED DURING BUSINESS HOURS

- PATH OF TRAVEL
- OCCUPANCY LOAD

INCLUDING 2018 NCFC 906.

- 1. MEANS OF EGRESS ILLUMINATION SHALL COMPLY WITH 1012 OF NCSBC.
- 2. MEANS OF EGRESS INCLUDING THE EXIT DISCHARGE SHALL BE ILLUMINATED AT ALL TIMES THE BUILDING IS OCCUPIED.
- 3. MEANS OF EGRESS ILLUMINATION LEVEL SHALL NOT BE LESS THAN 1-FOOT CANDLE (11 LUX) AT THE WALKING SURFACE. SEE ELECTRICAL
- 4. EMERGENCY POWER FOR EGRESS ILLUMINATION SHALL BE PROVIDED FOR A DURATION OF NOT LESS THAN 90 MINUTES.
- 5. SEE SHEETS G004, G005 AND A401 FOR ACCESSIBLE AND BARRIER FREE DETAILS AND MOUNTING HEIGHTS.
- 6. FIRE EXTINGUISHERS TO BE PROVIDED ACCORDING TO CODE REQUIREMENTS
- 7. TACTILE SIGNAGE TO BE PROVIDED AS REQUIRED BY CODE, INCLUDING 2018 NCSBC SECTION 1013.4


			STAIRS			D00RS	
	OCCUPANT LOAD	EGRESS COMPONENT FACTOR PER OCCUPANT	REQUIRED	PROVIDED	EGRESS COMPONENT FACTOR PER OCCUPANT	REQUIRED	PROVIDED
FIRST FLOOR	52 OCCUPANTS	.3"	N/A	N/A	.2"	9.8"	102"

SECTION 1005 MEANS OF EGRESS SIZING: OCCUPANT LOAD x EGRESS COMPONENT FACTOR = REQUIRED EGRESS WIDTH

EGRESS CALCULATIONS

TOTAL			1	1	≤	1	1	1	1	≤	1	1	1	1	1	1
BUSINESS (B)	26	26	1	1	1 per 25	1	1	1	1	1 per 40	1	1	'	I	'	
DUCINECO (D)	5	2	2		M/F	2	2	2	2	M/F	2)		4		4
	FEMALE	MALE	FEMALE	MALE	RATIO	FEMALE	MALE	FEMALE	MALE	RATIO	FEMALE	MALE	REQ'D	PROV	REQ'D	PROV
USE	OCCUF	PANIS	REQU	REQUIRED		PR0\	/IDED	REQUIRED		PROVIDED		IDED	2		Ę	2
				WA	ATER CLOSE	TS		LAVATORIES				SINK			ITAIN	
													SER	VICE	DRIN	IKING

PLUMBING CALCULATIONS

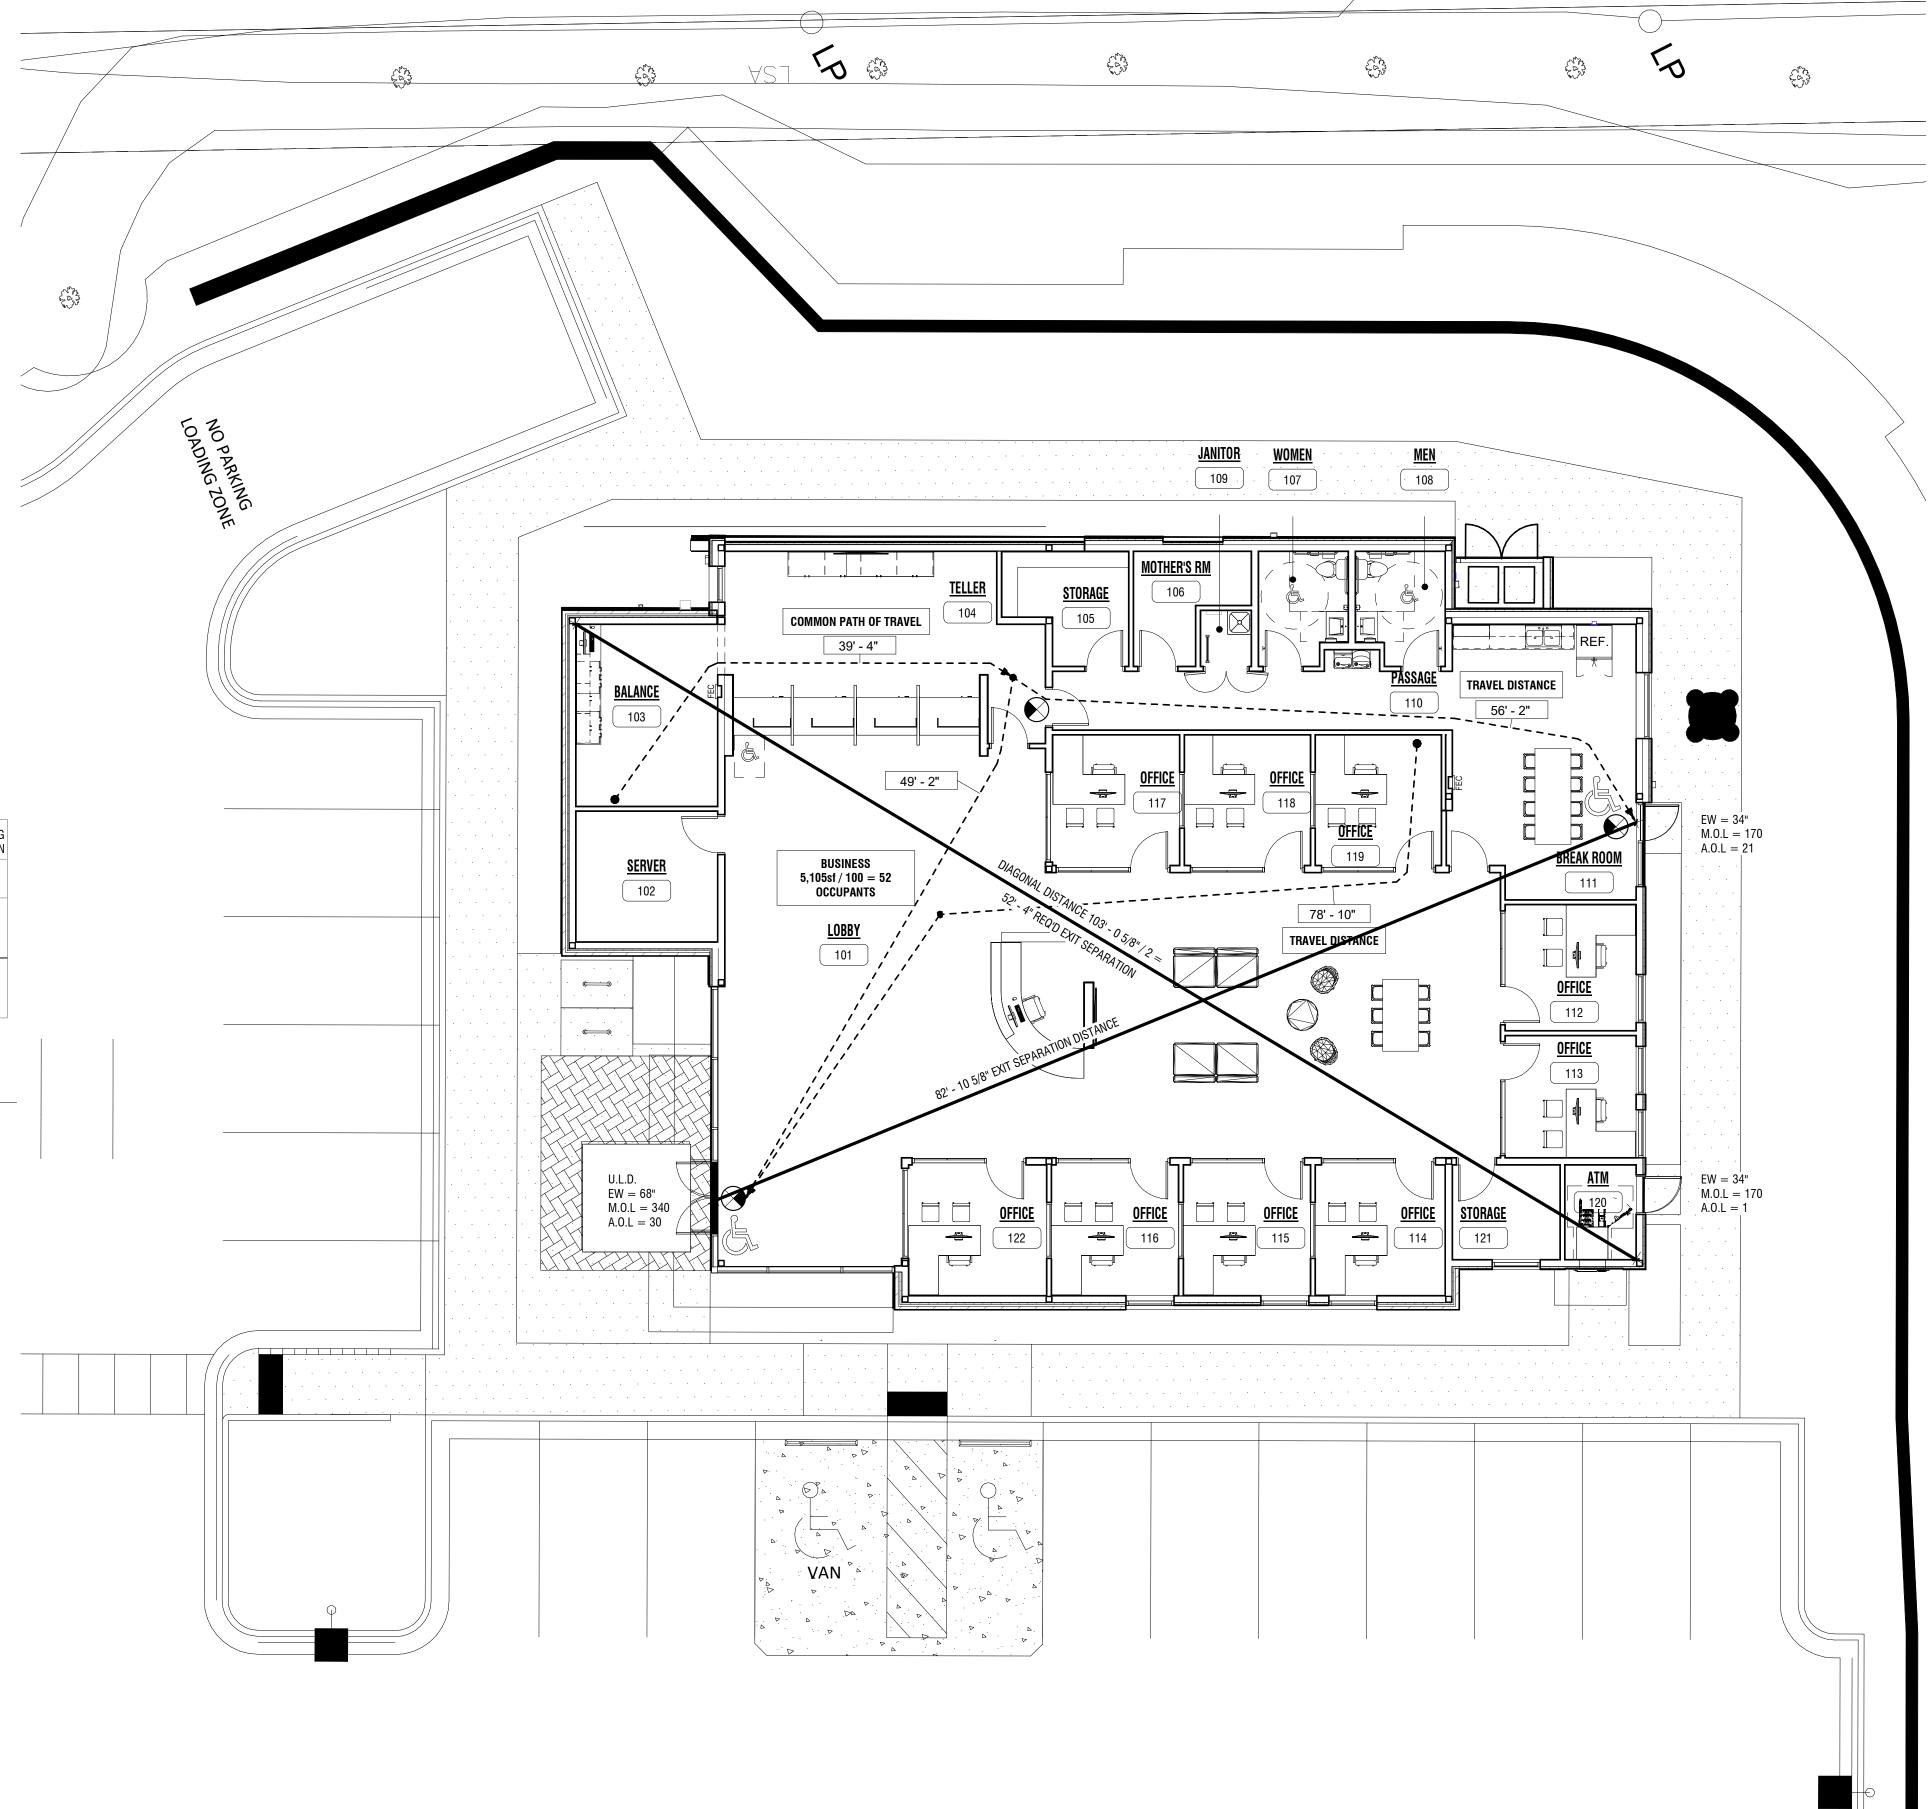



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NO:	DATE:	DES	CRIPTION:
evisions			
ROJECT	NUMBER:	2230150	
RAWN B	Y:	BAW	
EVIEWED	BY:	GGA	
SUED FO	DR:	BID SET	
ATE:		08.23.2024	

LIFE SAFETY PLAN

DRAWING NUMBER:

DRAWING NAME:

1 LIFE SAFETY PLAN G101 SCALE: 1/8" = 1'-0"

GENERAL STRUCTURAL NOTES:

- 1. BUILDING CODE: NORTH CAROLINA STATE BUILDING CODE, LATEST EDITION
- 2. CONSTRUCTION LOADING: DURING CONSTRUCTION, THE GENERAL CONTRACTOR SHALL LIMIT AND CONTROL CONSTRUCTION
- LOADING, INCLUDING BUT NOT LIMITED TO: a. MATERIAL STOCKPILING AND EQUIPMENT TO PRECLUDE OVERSTRESSING, CONSTRUCTION LIVE LOAD IN EXCESS OF 20 PSF, OR DAMAGE TO ANY STRUCTURAL ELEMENT.
- 3. COORDINATION WITH OTHER DISCIPLINES: THE CONTRACTOR SHALL COORDINATE ALL STRUCTURAL WORK WITH THE ARCHITECTURAL, ELECTRICAL, MECHANICAL, PLUMBING AND FIRE PROTECTION DRAWINGS AND SPECIFICATIONS.
- 4. EXISTING CONDITIONS: THE INFORMATION SHOWN ON THESE DOCUMENTS IS THE BEST REPRESENTATION OF EXISTING CONDITIONS AVAILABLE TO THE ENGINEER. IT IS THE CONTRACTOR'S RESPONSIBILITY TO FIELD VERIFY AND BRING TO THE ENGINEER'S AND CONSTRUCTION MANAGER'S ATTENTION ANY DISCREPANCIES PRIOR TO COMMENCING WORK.
- 5. EXISTING STRUCTURES: ALL EXISTING STRUCTURES ADJACENT TO NEW WORK ARE TO BE ADEQUATELY PROTECTED AND/OR SUPPORTED DURING CONSTRUCTION. THE CONTRACTOR SHALL BE RESPONSIBLE FOR REPAIRING ANY NEW OR EXISTING CONSTRUCTION DAMAGED WHILE WORK IS IN PROGRESS.
- 6. OPENINGS: THE CONTRACTOR SHALL BE RESPONSIBLE FOR COORDINATING SIZE AND LOCATION OF ALL OPENINGS IN NEW AND EXISTING CONSTRUCTION WITH THE DISCIPLINE REQUIRING THEM.

- 1b. (NO GEOTECHNICAL INFORMATION WAS AVAILABLE AT THE TIME OF DESIGN. ASSUMED ALLOWABLE BEARING PRESSURE = 1,500
- 2. TAKE ALL NECESSARY PRECAUTIONS WHEN EXCAVATING OR DRILLING ADJACENT TO EXISTING STRUCTURES TO AVOID DISTURBING EXISTING FOUNDATIONS. DO NOT EXCAVATE BELOW EXISTING FOUNDATIONS. CONTACT THE ENGINEER IF EXISTING CONDITIONS
- DIFFER FROM THOSE SHOWN ON THE DRAWING. 3. ALL EXCAVATIONS SHALL FULLY CONFORM TO LOCAL, STATE AND FEDERAL SAFETY REGULATIONS.
- 4. DO NOT BACKFILL AGAINST CONCRETE ELEMENTS UNTIL PLACED CONCRETE HAS REACHED 75% OF ITS SPECIFIED 28-DAY
- COMPRESSIVE STRENGTH. 5. BACKFILL BOTH SIDES OF FOUNDATION WALLS IN EQUAL, ALTERNATE LIFTS IN ORDER TO AVOID IMPOSING UNBALANCED LATERAL
- PRESSURE ON THE WALLS. 6. ALLOW TESTING AGENCY TO INSPECT AND APPROVE ALL COMPACTED SUBGRADE AND FILL LAYERS PRIOR TO FURTHER BACKFILL
- AND/OR PLACEMENT OF CONCRETE. TESTING AND INSPECTION RESULTS SHALL BE APPROVED BY THE GEOTECHNICAL ENGINEER. 7. THE SUITABILITY AND STABILITY OF EXISTING SOILS AND FILL, THE DEPTHS AND LATERAL LIMITS OF UNSUITABLE MATERIAL TO BE REMOVED, AND ADEQUACY OF FOUNDATION BEARING GRADES SHALL BE DETERMINED BY THE PROJECT GEOTECHNICAL ENGINEER.

8. BACKFILL AND FILL MATERIALS SHALL BE COMPACTED TO 95% OF MAXIMUM DRY DENSITY ACCORDING TO THE MODIFIED PROCTOR

- TEST (ASTM D-1557). ALL EXISTING BACKFILL SHALL BE RECOMPACTED AS SUCH.
- 9. EXCAVATION AND BACKFILL OPERATIONS SHALL BE MAINTAINED IN A DRY CONDITION. SURFACE AND INFILTRATING WATER SHALL BE REMOVED BY SITE GRADING AND/OR BY PUMPING FROM SUMPS AS REQUIRED.

- 1. PROVIDE THE FOLLOWING MINIMUM CONCRETE CLEAR COVER FOR REINFORCING STEEL, UNLESS OTHERWISE NOTED.:
- a. CONCRETE PLACED AGAINST EARTH: 3.0 IN.
- b. FORMED SURFACES IN CONTACT WITH EARTH OR EXPOSED TO WEATHER
- #6 THROUGH #18 BARS: 2.0 IN.
- #5 BARS AND SMALLER: 1.5 IN.
- c. FORMED SURFACES NOT IN CONTACT WITH EARTH OR EXPOSED TO WEATHER
- #14 AND #18 BARS: 1.5 IN.
- #11 BARS AND SMALLER:
- 2. ALL CONCRETE WORK, CONSTRUCTION, AND REINFORCING DETAILS SHALL CONFORM TO THE "NORTH CAROLINA STATE BUILDING CODE, LATEST EDITION".
- 3. ALL REINFORCING STEEL SHALL BE DETAILED, FABRICATED AND PLACED IN ACCORDANCE WITH ACI 318.
- 4. ALL REINFORCING BARS SHALL CONFORM TO ASTM A615 GRADE 60.
- 5. ALL REINFORCING SHALL BE LAPPED OR EMBEDDED IN ACCORDANCE WITH ACI 318, UNLESS OTHERWISE NOTED.
- 6. PROVIDE CORNER BARS TO MATCH ALL HORIZONTAL REINFORCING AT CORNERS OR INTERSECTIONS.
- 7. CHAMFER EXTERIOR CORNERS AND EDGES OF PERMANENTLY EXPOSED CONCRETE.
- 8. PRIOR TO PLACEMENT OF CONCRETE, A FIELD REPRESENTATIVE SHALL BE INFORMED A MINIMUM OF 24 HOURS IN ADVANCE OF PLACEMENT, TO ALLOW INSPECTION OF REINFORCING STEEL, AND PREPARATION FOR TAKING CONCRETE SAMPLES. INDEPENDENT TESTS ARE REQUIRED FOR ALL CONCRETE PLACEMENTS.
- 9. INSTALLATION OF REINFORCEMENT SHALL BE COMPLETED AT LEAST 24 HOURS PRIOR TO THE SCHEDULED CONCRETE PLACEMENT. 10. FURNISH AND INSTALL WATERSTOPS AT ALL HORIZONTAL AND VERTICAL JOINTS IN FOOTINGS AND FOUNDATION WALLS ADJACENT TO EXISTING FOUNDATION WALLS AND FOOTINGS
- 11. W.W.R. SHALL CONFORM TO ASTM A1064 AND SHALL BE FABRICATED INTO FLAT SHEETS.
- 12. VAPOR BARRIER: POLYETHYLENE SHEET, ASTM D 4397, NOT LESS THAN 15-MIL. LOCATED BELOW INTERIOR SLABS-ON-GRADE.
- 13. EPOXY ADHESIVE: HILTI HIT-HY 200 OR SIMPSON SET EPOXY.
- 14. GROUT: NON-METALLIC/NON-SHRINK STRUCTURAL GROUT. FIVE STAR GROUT OR APPROVED EQUAL. 15. SYNTHETIC MACRO-FIBER: FIBRILLATED POLYPROPYLENE MICRO-FIBERS ENGINEERED AND DESIGNED FOR USE IN CONCRETE,
- COMPLYING WITH ASTM C 1116/C 1116M, TYPE III. 16. PROTECT CONCRETE FROM PREMATURE DRYING IMMEDIATELY AFTER PLACEMENT. CURING OF CONCRETE SLABS MUST START
- WITHIN 2 HOURS AFTER FINISHING OPERATIONS ARE COMPLETE. SLABS-ON-GRADE SHALL BE WET CURED FOR 7 DAYS. CURING COMPOUNDS ARE PROHIBITED. SLABS-ON-GRADE SHALL HAVE CONTROL JOINTS AS SHOWN ON PLANS. SAW CUT JOINTS SHALL BE MADE WITHIN 12 HOURS OF PLACING SLAB. AFTER CONCRETE IS CURED AND READY FOR PLACEMENT OF FLOOR FINISH, ALL SLABS INSIDE THE BUILDING SHALL
- HAVE CONTROL JOINTS FILLED WITH APPROVED JOINT FILLER. 18. CONCRETE SHALL BE CONTROLLED, PROPORTIONED, MIXED AND PLACED IN THE PRESENCE OF A REPRESENTATIVE OF AN APPROVED
- TESTING AGENCY. 19. CONDUIT OR PIPES SHALL BE PLACED UNDER SLABS-ON-GRADE.
- 20. ALUMINUM CONDUITS OR PIPES SHALL NOT BE PLACED IN CONCRETE.

STRUCTURAL STEEL NOTES:

- 1. STRUCTURAL STEEL SHAPES SHALL CONFORM TO THE FOLLOWING:
- a. WIDE FLANGE SHAPES:... ...ASTM A992
- b. PLATES, BARS AND ANGLES:... ...ASTM A36
- c. HOLLOW STRUCTURAL SECTIONS (HSS) SQUARE OR RECTANGULAR:......ASTM A500, GRADE B, Fy = 46 KSIASTM A500, GRADE B, Fy = 42 KSId. HOLLOW STRUCTURAL SECTIONS (HSS) - ROUND:
- 2. BOLTED CONNECTIONS SHALL CONFORM TO THE FOLLOWING:
- ...ASTM A325, ASTM A490 HIGH-STRENGTH BOLTS (AS INDICATED ON PLANS)....
- 3. ANCHOR RODS SHALL CONFORM TO THE FOLLOWING: ANCHOR RODS (U.O.N.).....
- ...ASTM F1554, GRADE 36, WELDABLE (S1) 4. WELDING ELECTRODES SHALL CONFORM TO THE FOLLOWING:
- AWS SPECIFICATIONS FOR ELECTRODES BASED ON WELDING PROCESS AND THE TYPE AND GRADE OF STEEL. E70XX ELECTRODES
- (MIN.) FOR FILLET WELDS.
- 5. ALL STRUCTURAL STEEL SHALL BE DETAILED, FABRICATED AND ERECTED IN STRICT ACCORDANCE WITH THE LATEST AISC
- 6. SHOP FABRICATE TO THE GREATEST EXTENT POSSIBLE BY WELDING INCLUDING BEAM STIFFENERS, COLUMN CAPS AND BASES, HOLES AND CONNECTIONS.
- 7. FRAMING SHALL BE EQUALLY SPACED BETWEEN COLUMN LINES UNLESS OTHERWISE NOTED.
- 8a. PROVIDE MOMENT AND SHEAR CONNECTIONS AS SHOWN IN THE DRAWINGS. MISC. CONNECTIONS SHALL BE DESIGNED BY THE FABRICATOR FOR LOADS SHOWN ON THE PLANS AND SHALL MEET THE CRITERIA SHOWN IN THE TYPICAL DETAILS.
- 9. PROVIDE TEMPORARY BRACING FOR ALL ERECTED STEEL FRAMING UNTIL ALL CONNECTIONS HAVE BEEN FULLY TIGHTENED OR
- 10. CUTS, HOLES, COPES, ETC., REQUIRED FOR WORK OF THE OTHER TRADES SHALL BE SHOWN ON SHOP DRAWINGS AND MADE IN THE
- SHOP. FIELD CUTTING OR BURNING WILL NOT BE PERMITTED. 11. ALL WELDING BOTH SHOP AND FIELD SHALL BE PERFORMED BY CERTIFIED WELDERS IN ACCORDANCE WITH AWS SPECIFICATIONS. WELDING ELECTRODES SHALL CONFORM TO E70-XX. MINIMUM WELD SIZE SHALL BE 1/4 INCHES (FILLET) UNLESS OTHERWISE
- 12. BITUMINOUS COAT ALL STRUCTURAL STEEL LOCATED BELOW GRADE.
- 13. SEE SPECIFICATIONS FOR ALL EXTERIOR MEMBERS, LINTELS, ASSEMBLIES OR COMPONENTS. 14. FINISH:
- PAINTED: SEE SPECIFICATION.
- 15. AFTER ERECTION, ALL DAMAGED AREAS IN THE SHOP COAT AND AT ALL FIELD WELD LOCATIONS, SHALL BE TOUCHED UP WITH THE SAME PAINT USED FOR THE PRIMER AND SHOP COAT. PREPARE SURFACES IN ACCORDANCE WITH SSPC-SP3, FOR PAINTED FINISH, OR IN ACCORDANCE WITH ASTM A780 IF FINISH IS GALVANIZED.
- 16. FABRICATE AND ERECT ALL AESS PER THE REQUIREMENTS SHOWN IN THE SPECIFICATION.

STEEL JOIST AND JOIST GIRDER NOTES:

- 1. WELD JOIST BOTTOM CHORD CONNECTIONS AFTER ROOFING AND OTHER DEAD LOADS HAVE BEEN INSTALLED.
- 2. LOCATE CONCENTRATED LOADS AT PANEL POINTS. PROVIDE ANGLE WEB MEMBERS TO CREATE INTERMEDIATE PANEL POINTS AS SHOWN IN THE DRAWINGS AND TYPICAL DETAILS.
- 3. JOIST AND JOIST GIRDERS SHALL BE LOADED AT PANEL POINTS OR EXTRA WEB MEMBERS SHALL BE ADDED PER DETAILS SHOWN ON TYPICAL DETAILS SHEET FOR CONCENTRATED LOADS NOT APPLIED AT PANEL POINTS. WEB MEMBER SIZES SHALL BE AS
- INDICATED FOR JOISTS AND SHALL MATCH THE CHORD MEMBER SIZES FOR JOIST GIRDERS. 4. MANUFACTURER SHALL DESIGN JOISTS AND JOIST GIRDERS FOR SPECIAL LOADS INDICATED.
- 5. CONTRACTOR SHALL COORDINATE JOIST AND JOIST GIRDER SEAT DEPTHS PROVIDED BY MANUFACTURER WITH BEARING ELEVATIONS SHOWN, SEE TYPICAL BEARING DETAILS. TYPICAL BEARING DETAILS ARE PROVIDED FOR REFERENCE ONLY. THE CONTRACTOR IS RESPONSIBLE FOR COORDINATING THE FINAL DESIGN AND LAYOUT OF JOIST AND JOIST GIRDER BEARING DETAILS
- WITH THE MANUFACTURER AND SHALL SUBMIT SHOP DRAWINGS FOR REVIEW. 6. ALL JOIST GIRDER CONNECTIONS SHALL BE DESIGNED FOR THE LOADS SHOWN IN THE DRAWINGS.
- 7. JOIST AND JOIST GIRDER WEB TYPES MAY VARY DEPENDING ON MANUFACTURER, JOIST DETAILS HAVE BEEN DEVELOPED BASED ON ASSUMED WEB TYPES. THE CONTRACTOR SHALL SUBMIT SHOP DRAWINGS FOR REVIEW.

1. PROVIDE GALVANIZED STEEL DECK IN ACCORDANCE WITH ASTM A653. GALVANIZED WITH A MINIMUM YIELD STRENGTH OF 33 KSI.

- 2. PLACE STEEL DECK OVER A MINIMUM OF 3 SPANS IN THE DIRECTION INDICATED IN THE PLANS, UNLESS OTHERWISE NOTED.
- 3. PROVIDE BENT METAL CLOSURE PLATES (POURSTOPS) AT ALL DISCONTINUOUS SLAB EDGES IN ACCORDANCE WITH TYPICAL SLAB
- EDGE DETAILS.
- 4. WELD DECKING TO STRUCTURAL STEEL BY CERTIFIED WELDERS USING PREQUALIFIED PROCEDURES. THE ERECTOR SHALL ESTABLISH A WELDING PROCEDURE FOR THE PUDDLE WELDING OF STEEL DECKING TO THE STRUCTURAL STEEL FOR THE
- PARTICULAR GAGES USED. PRIOR TO THE START OF ERECTION OF THE STEEL DECK, QUALIFY EACH WELDER USING THIS PROCEDURE AS WITNESSED BY THE OWNER'S TESTING LABORATORY.
- 5. POWER-ACTUATED MECHANICAL FASTENERS APPROVED BY THE ENGINEER OF RECORD MAY BE USED IN LIEU OF WELDING THE
- DECKING TO THE STRUCTURAL STEEL. 6. DO NOT HANG LOADS EXCEEDING 50 LBS. FROM ANY METAL DECKING. HANG ALL DUCTWORK, PIPING, ETC. DIRECTLY FROM
- 7. MESH REINFORCING SHALL BE LOCATED 3/4" DOWN FROM THE TOP OF ALL SLABS. MESH SHALL BE SUPPORTED IN ACCORDANCE WITH THE REQUIREMENTS OF THE STEEL DECK INSTITUTE AND THE DECK MANUFACTURER UNLESS SPECIFICALLY DETAILED

COLD-FORMED METAL STUD FRAMING NOTES:

STRUCTURAL STEEL.

- 1. ALL STRUCTURAL MEMBERS SHALL BE DESIGN DELEGATED IN ACCORDANCE WITH AMERICAN IRON AND STEEL INSTITUTE (AISI) "SPECIFICATIONS FOR THE DESIGN OF COLD-FORMED STEEL STRUCTURAL MEMBERS", LATEST EDITION. PROVIDE SUBMITTALS FOR
- ALL COLD-FORMED STEEL FRAMING.

MEETING THE TOLERANCES NOTED IN ASTM C955. ALL 18 GAGE AND LIGHTER FRAMING SHALL BE FORMED FROM

2. ALL 16 GAGE AND HEAVIER FRAMING STRUCTURAL MEMBERS SHALL BE FORMED FROM CORROSION-RESISTANT STEEL, CORRESPONDING TO THE REQUIREMENTS OF ASTM A1003 WITH A MINIMUM YIELD STRENGTH OF 50 KSI, UNLESS OTHERWISE NOTED,

CORROSION-RESISTANT STEEL CORRESPONDING TO THE REQUIREMENTS OF ASTM A1003 WITH A MINIMUM YIELD STRENGTH OF 33

CLOSED CELL FOAM, HEAVY PLASTIC, OR PAINT TO ISOLATE THE TWO MATERIALS FROM CORROSION. CONTRACTOR SHALL USE THE

- 3. ALL STRUCTURAL MEMBERS SHALL BE ZINC COATED MEETING ASTM A653, G-90. 4. ALL VERTICAL STUDS SHALL BE BRACED AT 4 FEET ON CENTER VERTICALLY UTILIZING A HORIZONTAL STRAP AND BLOCKING OR

* 1 mil = 1/1000 inch

- 5. PERSONNEL EXPERIENCED IN COLD-FORMED METAL FRAMING INSTALLATION SHALL INSTALL ALL METAL FRAMING.
- 6. PROVIDE A DOUBLE STUD AT ALL CORNER CONDITIONS. 7. WHERE PRESSURE TREATED LUMBER IS USED IN DIRECT CONTACT WITH GALVANIZED COLD FORMED FRAMING, USE FELT PAPER,
- APPROPRIATE FASTENERS THAT DO NOT ACCELERATE CORROSION AS REQUIRED. 8. AT VARIOUS LOCATIONS IN THE CONSTRUCTION DOCUMENTS, GAGE NO. ARE USED. THESE NUMBERS ARE FOR REFERENCE ONLY.

MINIMUM ACCEPTABLE MATERIAL	THICKNESS DELIVERED	TO THE JOBSITE IS AS FOLLOWS:
REFERENCE ONLY	MINIMUM THICKNESS	
(GAGE NO.)	(mils*)	
20	33	
18	43	
16	54	
14	68	
12	97	



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LICENSE NO. C-0430

CERT. NO.

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LCCU - Morrisville Site Adapt

9521 Chapel Hill Rd. Morrisville, NC 27560

NO:	DATE:	DESCRIPTION:	
Revisions			
PROJECT	NUMBER:		
		2230150	
DRAWN B	Y:	JLW	
REVIEWE	D BY:	DRH	
ISSUED FO	DR:	BID SET	
DATE:		08.23.2024	

GENERAL NOTES

DRAWING NUMBER:

DRAWING NAME:

	BASE PLATE SCHEDULE									
	BASE	PLATE PROPER	RTIES	ANCHO	R BOLT PROPE	RTIES				
TYPE	LENGTH	WIDTH	THICKNESS	NO. OF BOLTS	BOLT DIAMETER	MIN. EMBEDMENT	COMMENTS			
BP1	1' - 2"	1' - 2"	1"	4	3/4"	9"				
BP2	1' - 4"	1' - 4"	1 1/4"	4	1"	1' - 0"				

	FOOTING SCHEDULE											
	FOC	TING DIMENSI	ONS	FO.	OTING REINFORCEMENT							
MARK	LENGTH	LENGTH WIDTH THICKNESS		BOTTOM REI	NFORCEMENT	TOP	COMMENTS					
	LENGTH	WIDIN	THIORNESS	LONGITUDINAL REINF.	TRANSVERSE REINF.	REINFORCEMENT						
F4	4' - 0"	4' - 0"	1' - 0"	(5) #5 BARS	(5) #5 BARS							
F5	5' - 0"	5' - 0"	1' - 4"	(6) #5 BARS	(6) #5 BARS							
F6	6' - 0"	6' - 0"	1' - 6"	(7#6 BARS	(7) #6 BARS	(7) #6 BARS E.W.						
F7	7' - 0"	7' - 0"	1' - 6"	(8) #6 BARS	(8) #6 BARS	(8) #6 BARS E.W.						

T.O.S. HIGH ROOF

T.O.S. SKYLIGHT

T.O.S. MAIN ROOF

T.O.S. LOW ROOF

FOUNDATION PLAN

Column Locations

-1' - 0"

BP2

A-4

BP2

A-5

B-2(4' - 2 47/64"), B-3(-5' -7 17/64")

BP2

A-3

BP1

B-6

BP2

C-4, C-5

BP2

D-2

16' - 5 1/2"

12' - 3 1/2"

22' - 1 1/2"

27' - 4"

	FOUNDATION WALL SCHEDULE										
MARK	TYPE	THICKNESS	WAL	COMMENTS							
IVIALUX	111 6	THORNESS	HORIZONTAL	VERTICAL	OOMINIENTO						
C6	CONCRETE WALL	6"	#4 BARS @ 12" O.C.	#4 BARS @ 12" O.C.	REINFORCEMENT CENTERED ON WALL						
C10	CONCRETE WALL	10"	#4 BARS @ 12" O.C. E.F.	#4 BARS @ 12" O.C. E.F.							
C12	CONCRETE WALL 1' - 0" #4 BARS @ 12" O.C. E.F. #4 BARS @ 12" O.C. E.F.										

	ROOF DECK SCHEDULE										
MARK	TYPE	MODEL	GAGE	WELDED FASTE SUPPORT PATTERN	ENER PATTERN SIDELAP PATTERN	COMMENTS					
RD-1	METAL ROOF DECK	VULCRAFT 1.5" TYPE B DECK	20	36/5 PATTERN	6" O.C.						

		SLAB-ON-GRADE SCHEDULE								
	MARK TYPE SLAB THICKNESS SLAB REINFORCEMENT COMMENTS									
	S.O.G. 1	SLAB-ON-GRADE	4"	FIBER REINFORCED - SEE GENERAL NOTES						
L										

COLUMN SCHEDULE

BP1

E-1

BP2

G-5

BP2

F-4

BP2

G-6, H-5, H-6

BP2

H-2

BP1


H-4

BP2

J-2, J-5

	WALL FOOTING SCHEDULE						
MARK	WIDTH	THICKNESS	FOO LONGITUDINAL	OTING REINFORCEMENT TRANSVERSE	COMMENTS		
WF1	2' - 0"	1' - 0"	(3) #4 CONT.	#4 BARS @ 12" O.C.			
WF2	2' - 6"	1' - 0"	(3) #4 CONT.	#4 BARS @ 12" O.C.			

		DESIGN TABLE - NCSBC 2018 E WITH APPLICABLE BUILDING CODE)	
JOOK VII)	OHMU	E WITH ALL ENABLE DOILDING CODE)	
BUILDING DATA:			
LOCATION		9521 Chapel Hill Rd. Morrisville, NC 27560	
BUILDING OCCUPANCY RISK CATEGORY		II	NCSBC 2018 TABLE 1604
APPLICABLE BUILDING CODE		NORTH CAROLINA STATE BUILDING CODE, LATEST	NOODO ZOTO TABLE 1004
APPLICABLE BUILDING CODE		EDITION	
DEAD LOAD:		LDITION	
ROOF	DL1	20 PSF	
	DLI	20 F5F	
FLOOR LIVE LOAD:		100 DOF	NOODO 0040 TADI E 4007
LOBBY		100 PSF	NCSBC 2018 TABLE 1607
CORRIDORS (FIRST FLOOR)	1	100 PSF	
OFFICES		50 PSF	
MECHANICAL	LL4	150 PSF	
ROOF LIVE LOAD:			
R00F	LLr	20 PSF	NCSBC 2018 TABLE 1607
SNOW LOAD:			
SNOW LOAD IMPORTANCE FACTOR	ls	1.0	ASCE 7-10 TABLE 1.5-2
GROUND SNOW LOAD	Pg	15 PSF	NCSBC 2018 FIGURE 160
SNOW EXPOSURE FACTOR	Ce	1.0	ASCE 7-10 TABLE 7-2
THERMAL FACTOR	Ct	1.0	ASCE 7-10 TABLE 7-3
FLAT ROOF SNOW	1	12 PSF	ASCE 7-10 SECTION 7.3
DRIFTING SNOW		AS REQ. PER ASCE 7-10	ASCE 7-10 SECTION 7.7
WIND LOAD (MAIN WIND-FORCE RESISTING SYSTEM):		NOTIES. LET AUGE 1-10	, LOOL / TO OLUTION /./
·		DIDECTIONAL DDOCEDUDE	ACCE 7 10 CHARTER 27
ANALYSIS PROCEDURE	1	DIRECTIONAL PROCEDURE	ASCE 7-10 CHAPTER 27
ULTIMATE DESIGN WIND SPEED (3-SECOND GUST)	1	115 mph	ASCE 7-10 SECTION 26.5
NOMINAL DESIGN WIND SPEED (3-SECOND GUST)	1	90 mph	NCSBC SECTION 1609.3.1
WIND DIRECTIONALITY FACTOR	1	0.85	ASCE 7-10 SECTION 26.6
EXPOSURE CATEGORY	1	C	ASCE 7-10 SECTION 26.7
TOPOGRAPHIC FACTOR	Kzt	1.00	ASCE 7-10 SECTION 26.8
GUST-EFFECT FACTOR	G	0.85	ASCE 7-10 SECTION 26.9
ENCLOSURE CLASSIFICATION		ENCLOSED	ASCE 7-10 SECTION 26.10
INTERNAL PRESSURE COEFFICIENT	GCpi	+0.18/-0.18	ASCE 7-10 SECTION 26.1
VELOCITY PRESSURE	q	19 PSF	ASCE 7-10 SECTION 27.3.
EXTERNAL PRESSURE COEFFICIENT	1 -	0.8	ASCE 7-10 SECTION 27.4
MINIMUM WALL WIND PRESSURE		16 PSF	ASCE 7-10 SECTION 27.4.
MINIMUM ROOF WIND PRESSURE		8 PSF	ASCE 7-10 SECTION 27.4.
NOTES		WIND LOADS ARE CALCULATED FROM THESE	
		PARAMETERS FOR EACH SURFACE OF THE MAIN WIND-FORCE RESISTING SYSTEM.	
WIND LOAD (COMPONENTS & CLADDING):		WIND TOTAL REGISTING STOTEM.	
BASIC WIND SPEED (3-SECOND GUST)	V	90 mph	ASCE 7-10 SECTION 26.5
EXPOSURE CATEGORY	1	So Hibii	
	1	_	ASCE 7-10 SECTION 26.7
TOPOGRAPHIC FACTOR	1	1.00	ASCE 7-10 SECTION 26.8
ENCLOSURE CLASSIFICATION		ENCLOSED	ASCE 7-10 SECTION 26.10
EFFECTIVE WIND AREA		10 SQFT	ASCE 7-10 FIGURE 30.5-1
MINIMUM DESIGN WIND PRESSURE		+/- 16 PSF	ASCE 7-10 SECTION 30.2
NOTES	1.	EFFECTIVE AREA ABOVE USED AS BASIS FOR "WORST	
		CASE" PRESSURE CALCULATIONS. THE EFFECTIVE	
		AREA FOR EACH INDIVIDUAL COMPONENT SHALL BE	
		CALCULATED AND PRESSURE VALUES ADJUSTED	
		ACCORDINGLY.	
	2.	INCREASED WIND PRESSURES AT EDGES,	
		OVERHANGS, AND OTHER SURFACES ARE AS DEFINED IN ASCE 7-10 "MINIMUM DESIGN LOADS FOR	
		BUILDINGS AND OTHER STRUCTURES".	
EARTHQUAKE LOAD:		BOILDINGO AND OTHER OTROUTURES.	
SEISMIC - FORCE RESISTING SYSTEM		H. STEEL SYSTEMS NOT SPECIFICALLY DETAILED	ASCE 7-10 TABLE 12.2-1
SOIL SITE CLASSIFICATION		D	ASCE 7-10 SECTION 20.3
SPECTRAL RESPONSE ACCELERATION AT 0.2 SEC		0.157g	ASCE 7-10 FIGURE 22-1
SPECTRAL RESPONSE ACCELERATION AT 1.0 SEC		0.078g	ASCE 7-10 SECTION 11.4
SEISMIC IMPORTANCE FACTOR		1.0	ASCE 7-10 TABLE 1.5-2
DESIGN SPECTRAL RESPONSE COEFFICIENT	SDS	0.168g	ASCE 7-10 SECTION 11.4.
DESIGN SPECTRAL RESPONSE COEFFICIENT	SD1	0.125g	ASCE 7-10 SECTION 11.4.
SEISMIC DESIGN CATEGORY		В	ASCE 7-10 TABLE 11.6-(1
ANALYSIS PROCEDURE		EQUIV. LATERAL FORCE	ASCE 7-10 SECTION 12.8
:	1	1	1

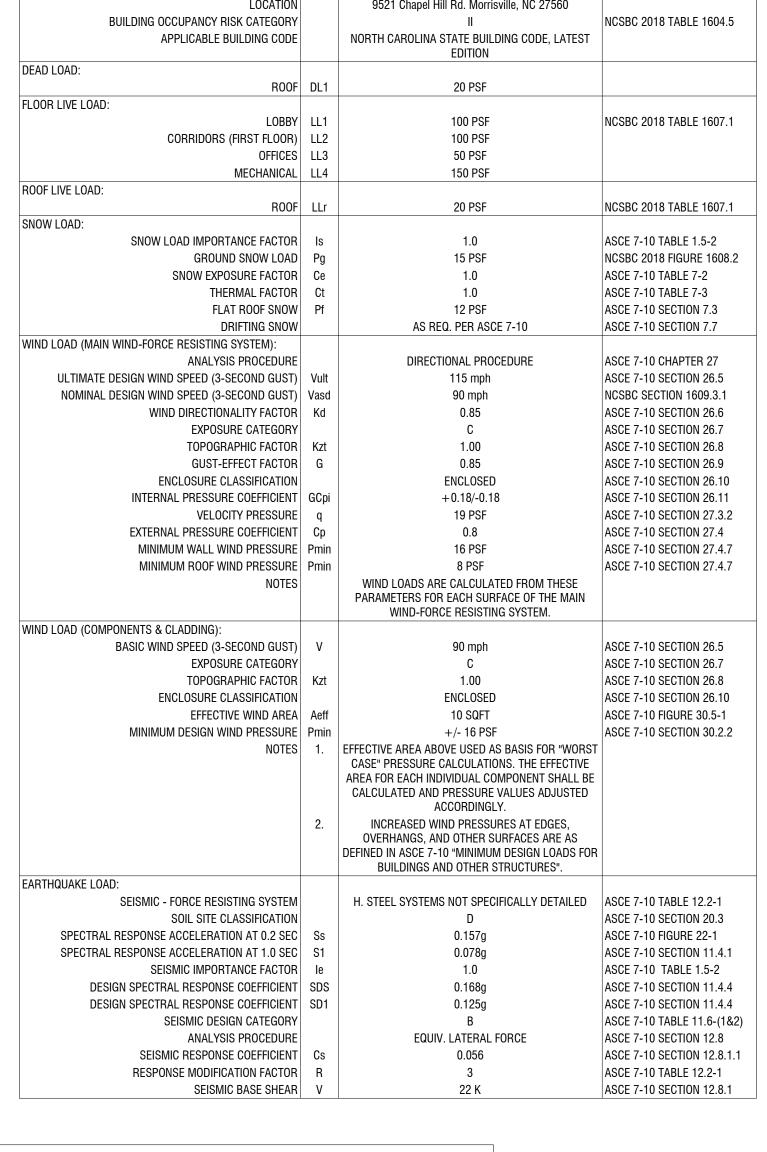

T.O.S. HIGH ROOF

T.O.S. SKYLIGHT

T.O.S. MAIN ROOF

T.O.S. LOW ROOF

FOUNDATION PLAN

16' - 5 1/2"

12' - 3 1/2"

22' - 1 1/2"

27' - 4"





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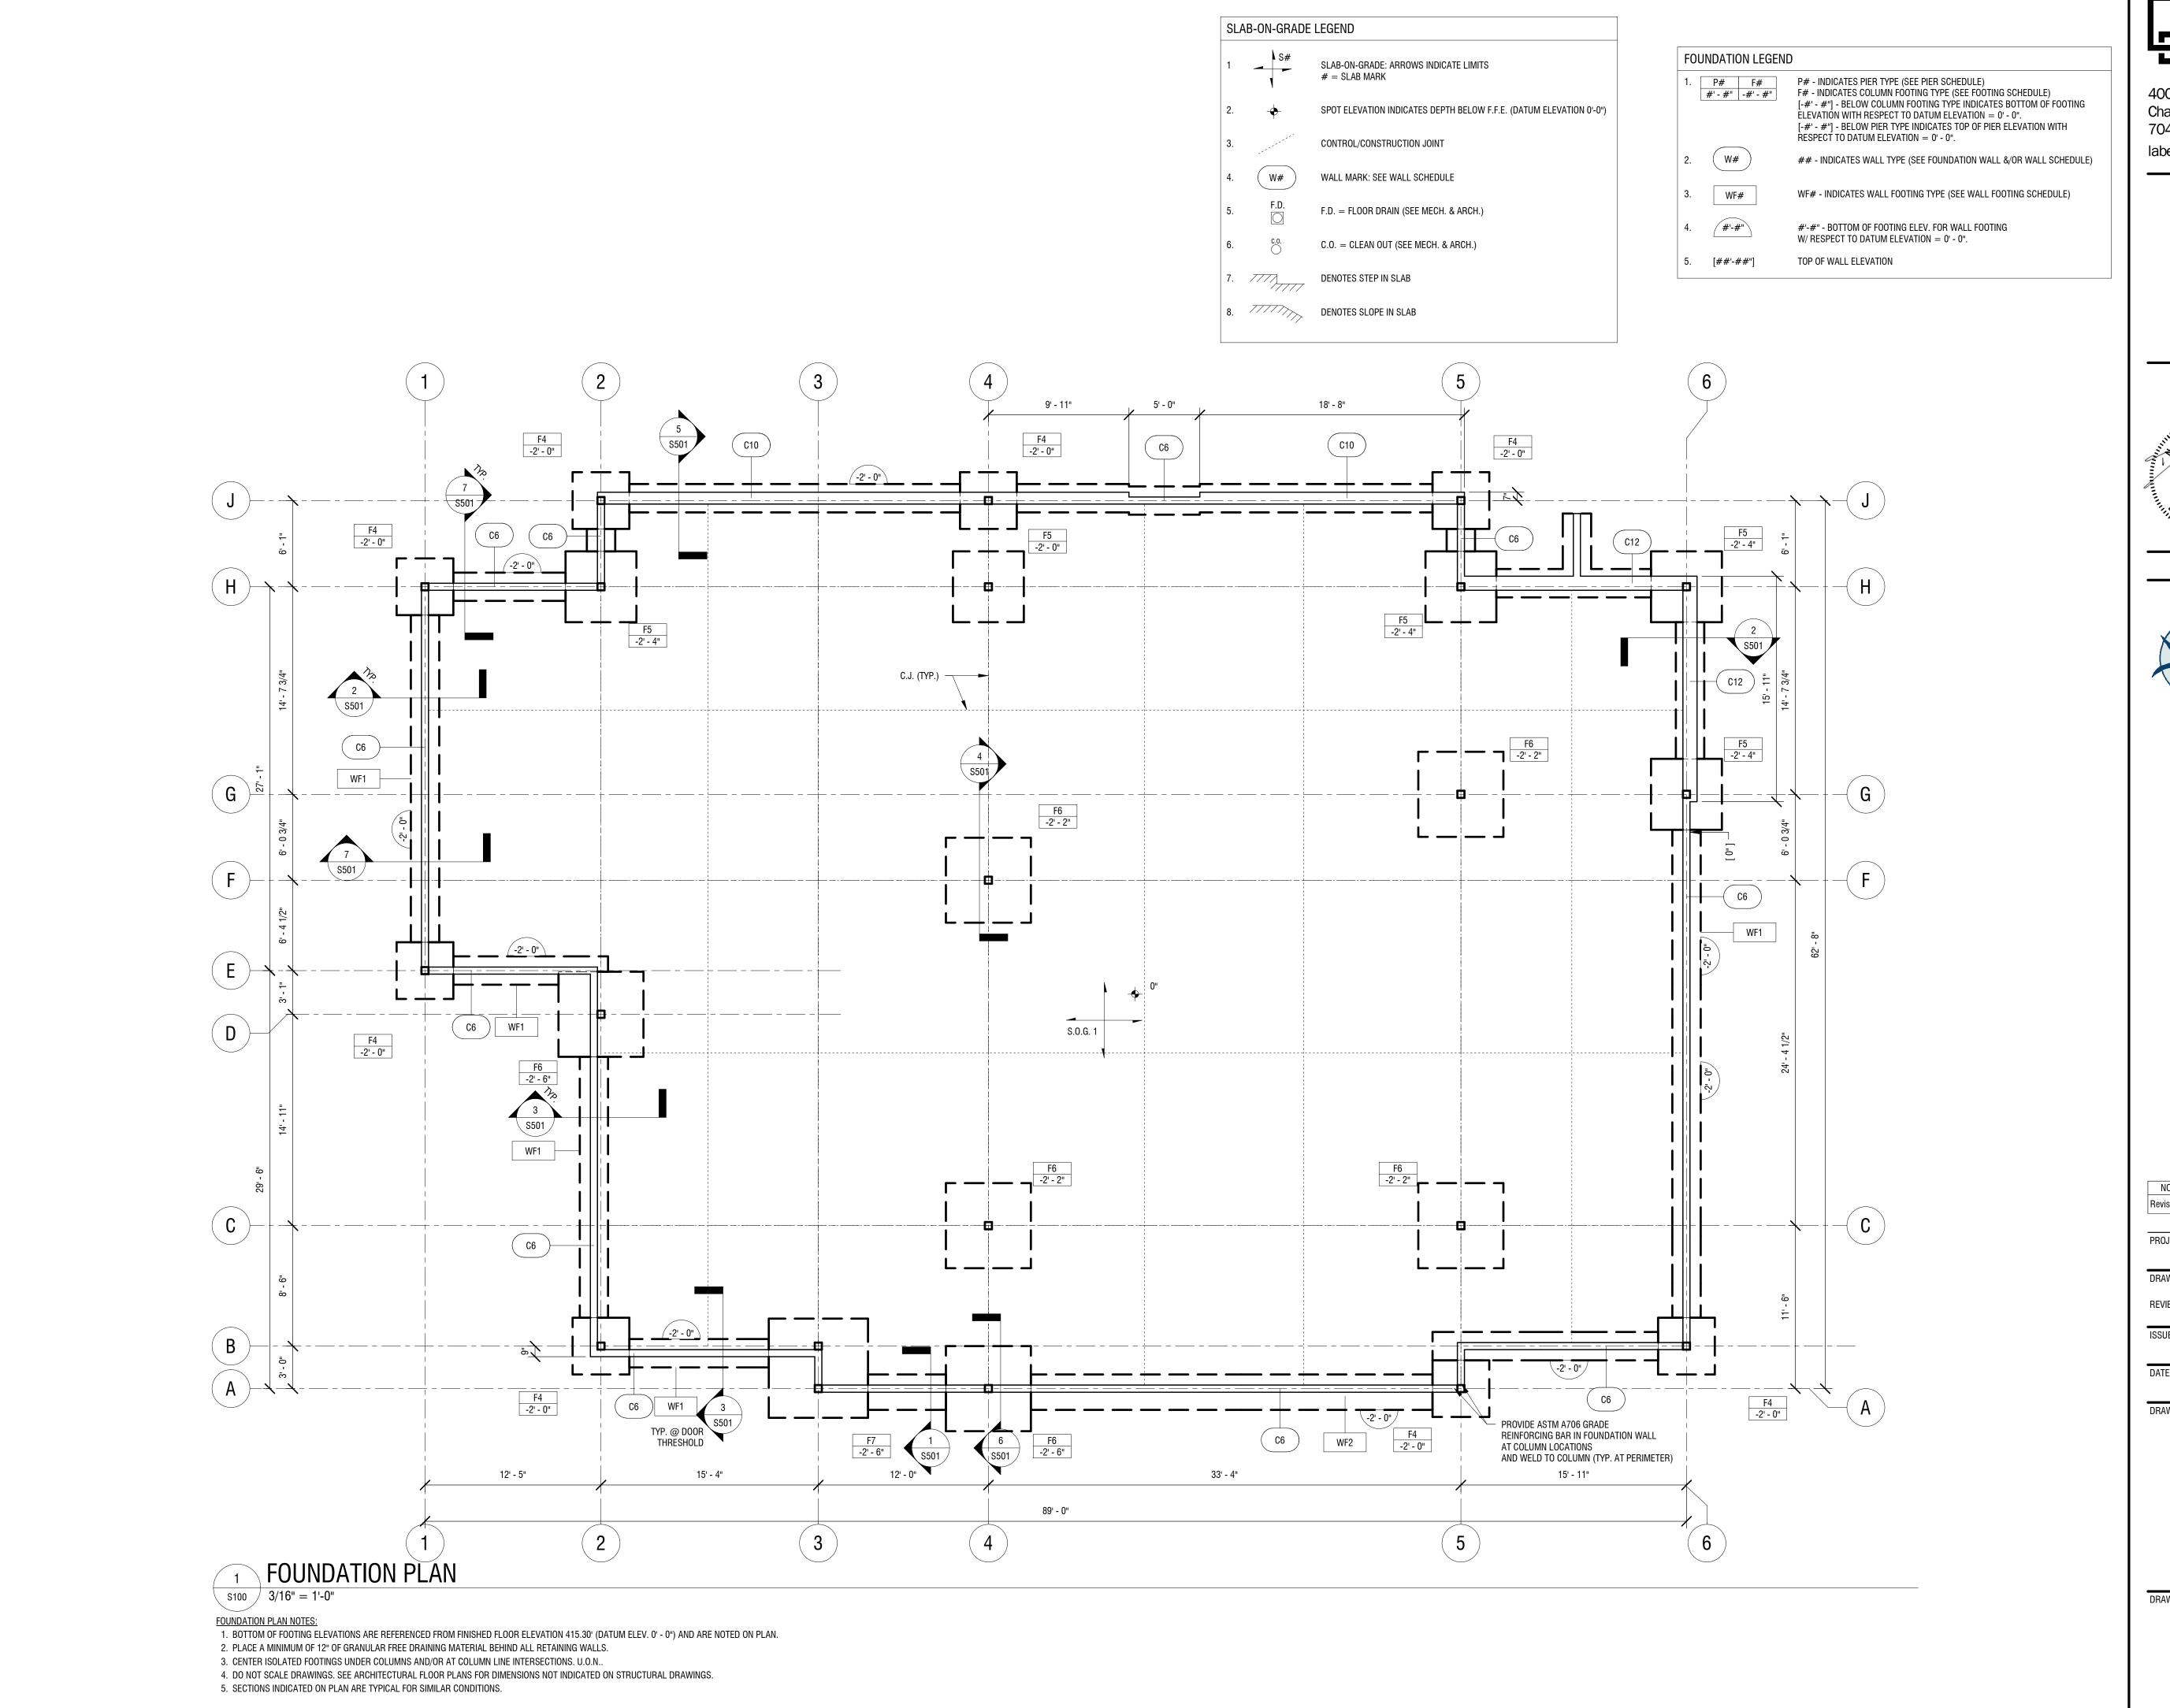
LCCU - Morrisville Site Adapt

9521 Chapel Hill Rd. Morrisville, NC 27560

NO:	DATE:	DESCRIPTION:	
Revisions			
PROJECT N	UMBER:	2230150	
DRAWN BY:		JLW	
REVIEWED BY:		DRH	
ISSUED FOF	₹:	BID SET	
DATE:		08.23.2024	

GENERAL SCHEDULES

DRAWING NUMBER:







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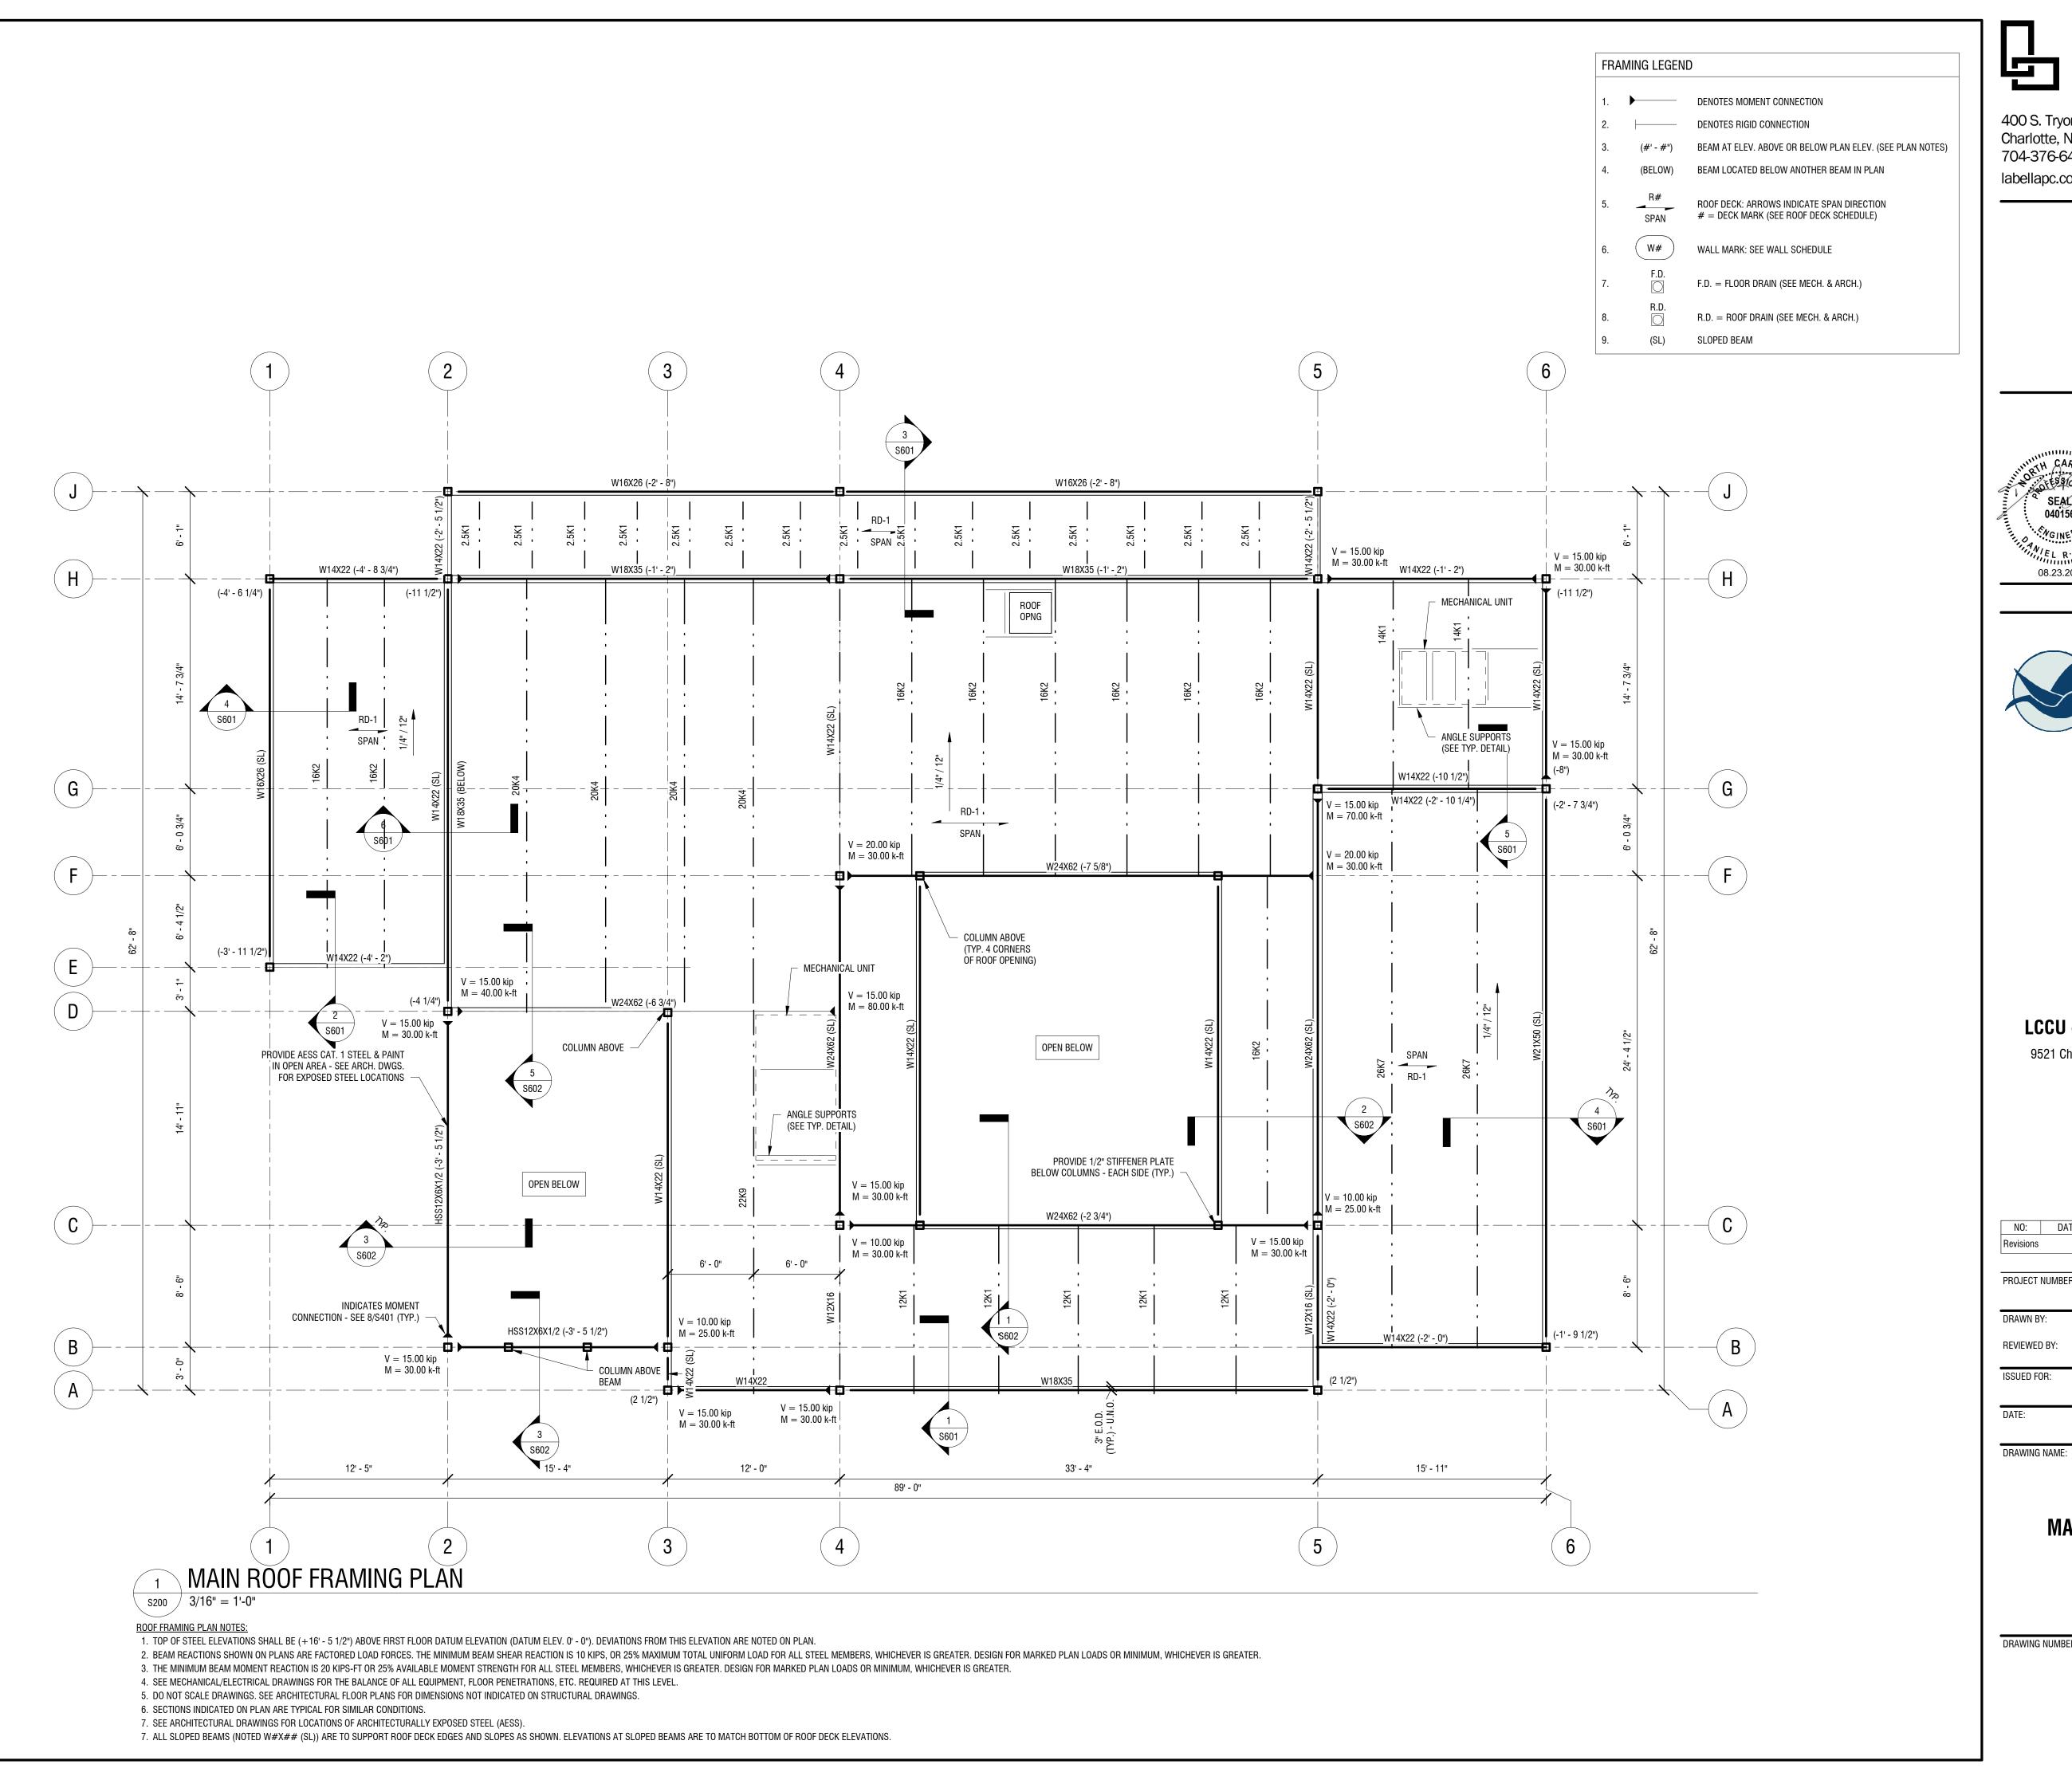
LCCU - Morrisville Site Adapt


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30150
LW
PRH
) SET

FOUNDATION PLAN

DRAWING NUMBER:



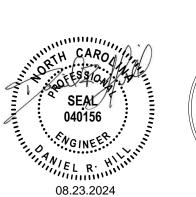

CORPORATE ENGINEERING LICENSE NO. C-0430

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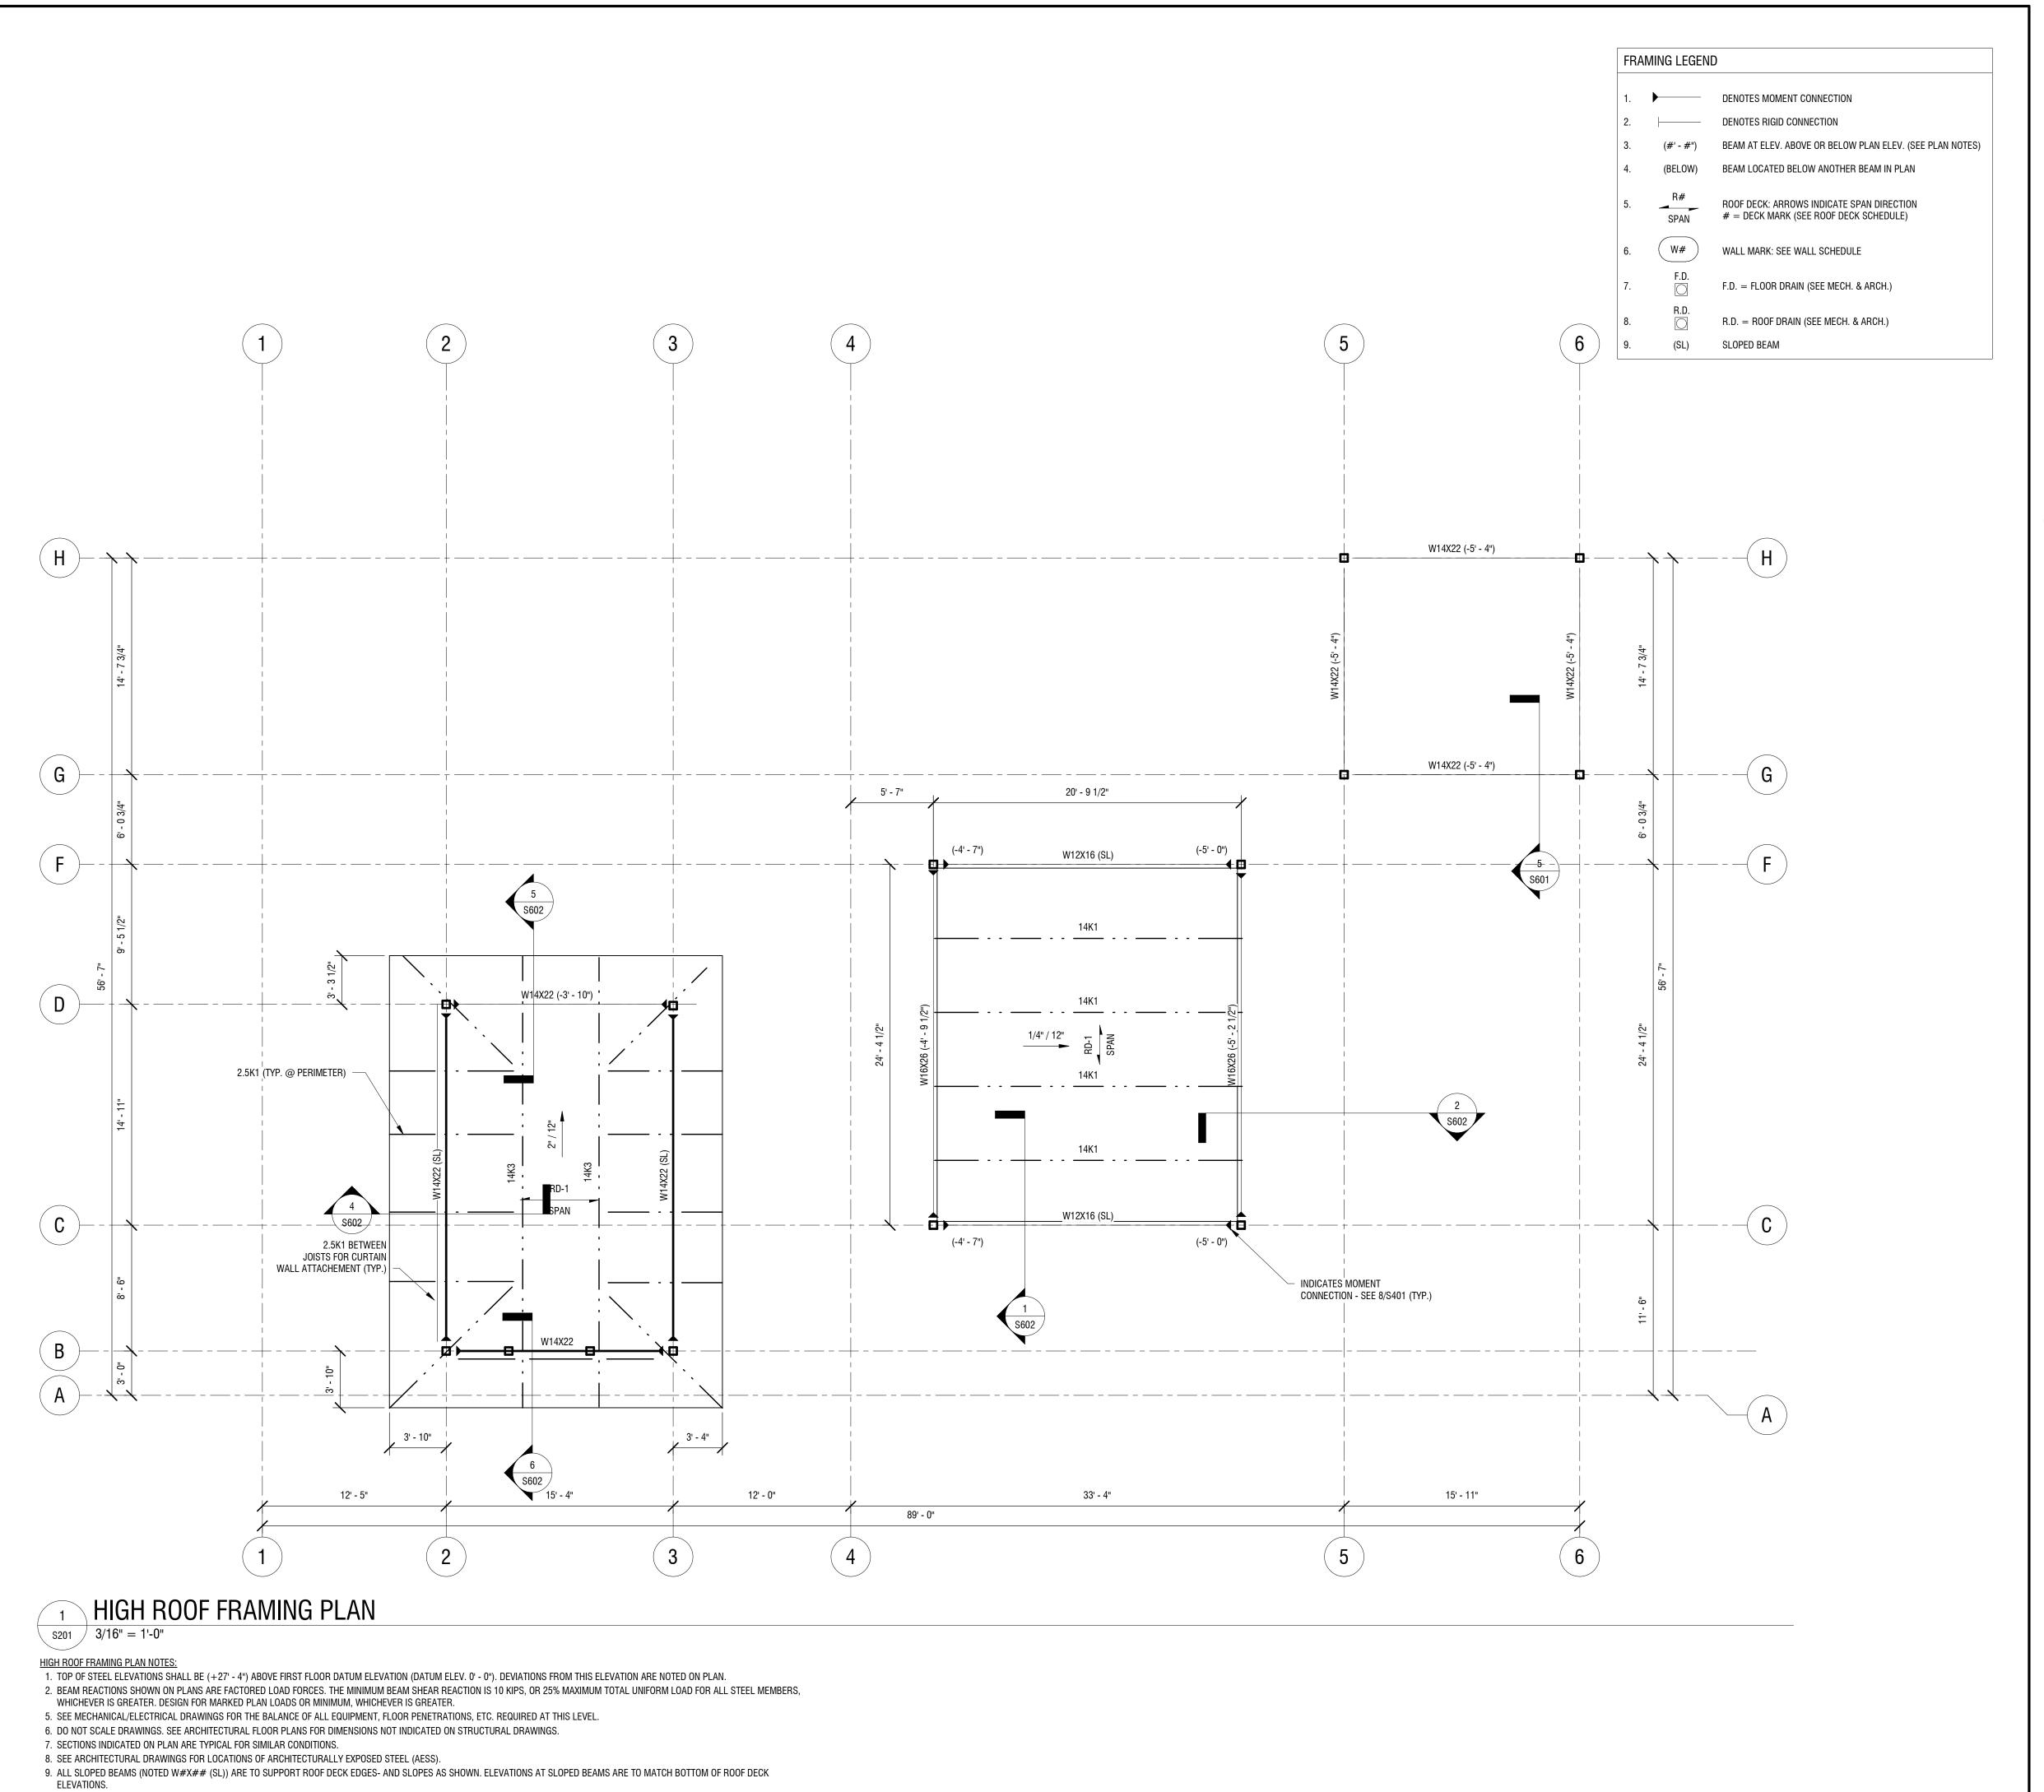
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NO:	DATE:	DESCRIPTION:
Revisions		
PROJECT N	UMBER:	2230150
		2230130
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	<i>.</i>	DRH
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		BID SET
DATE:		00 00 0004
		08.23.2024

MAIN ROOF FRAMING **PLAN**

DRAWING NUMBER:



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Revisions

PROJECT NUMBER:

2230150


DRAWN BY:
JLW
REVIEWED BY:
DRH

ISSUED FOR:
BID SET

DATE:
08.23.2024

HIGH ROOF FRAMING PLAN

DRAWING NUMBER:

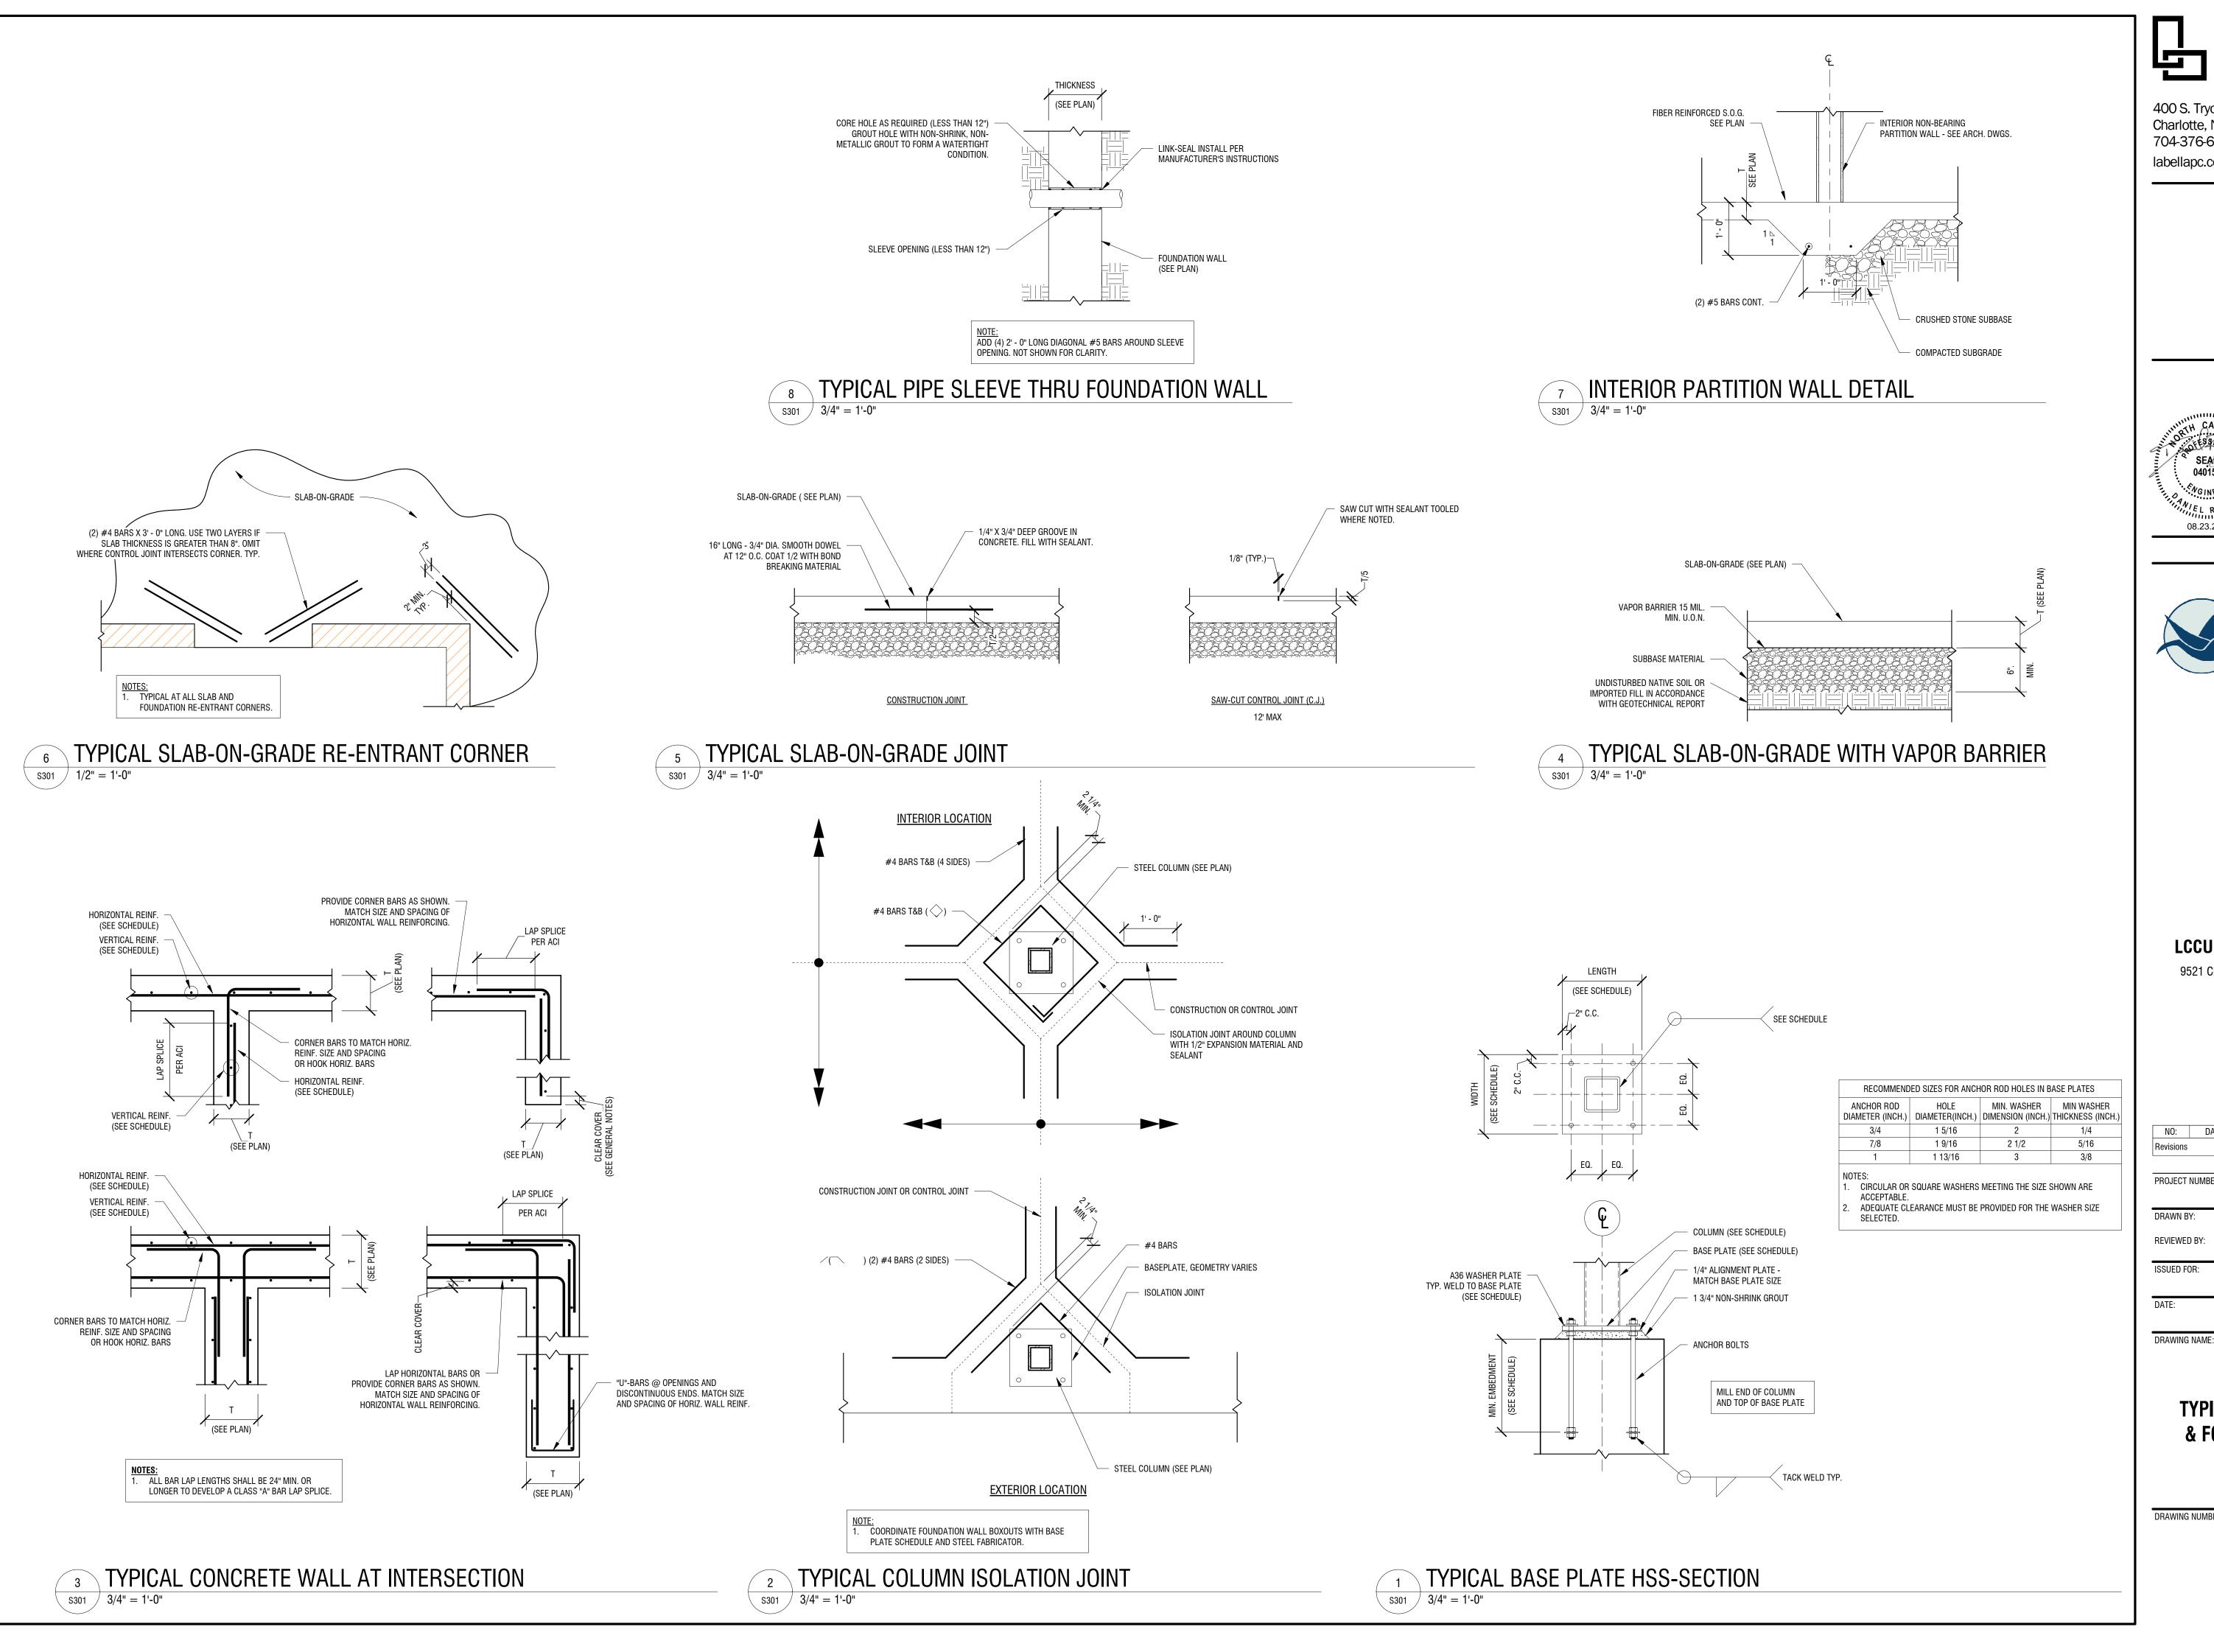



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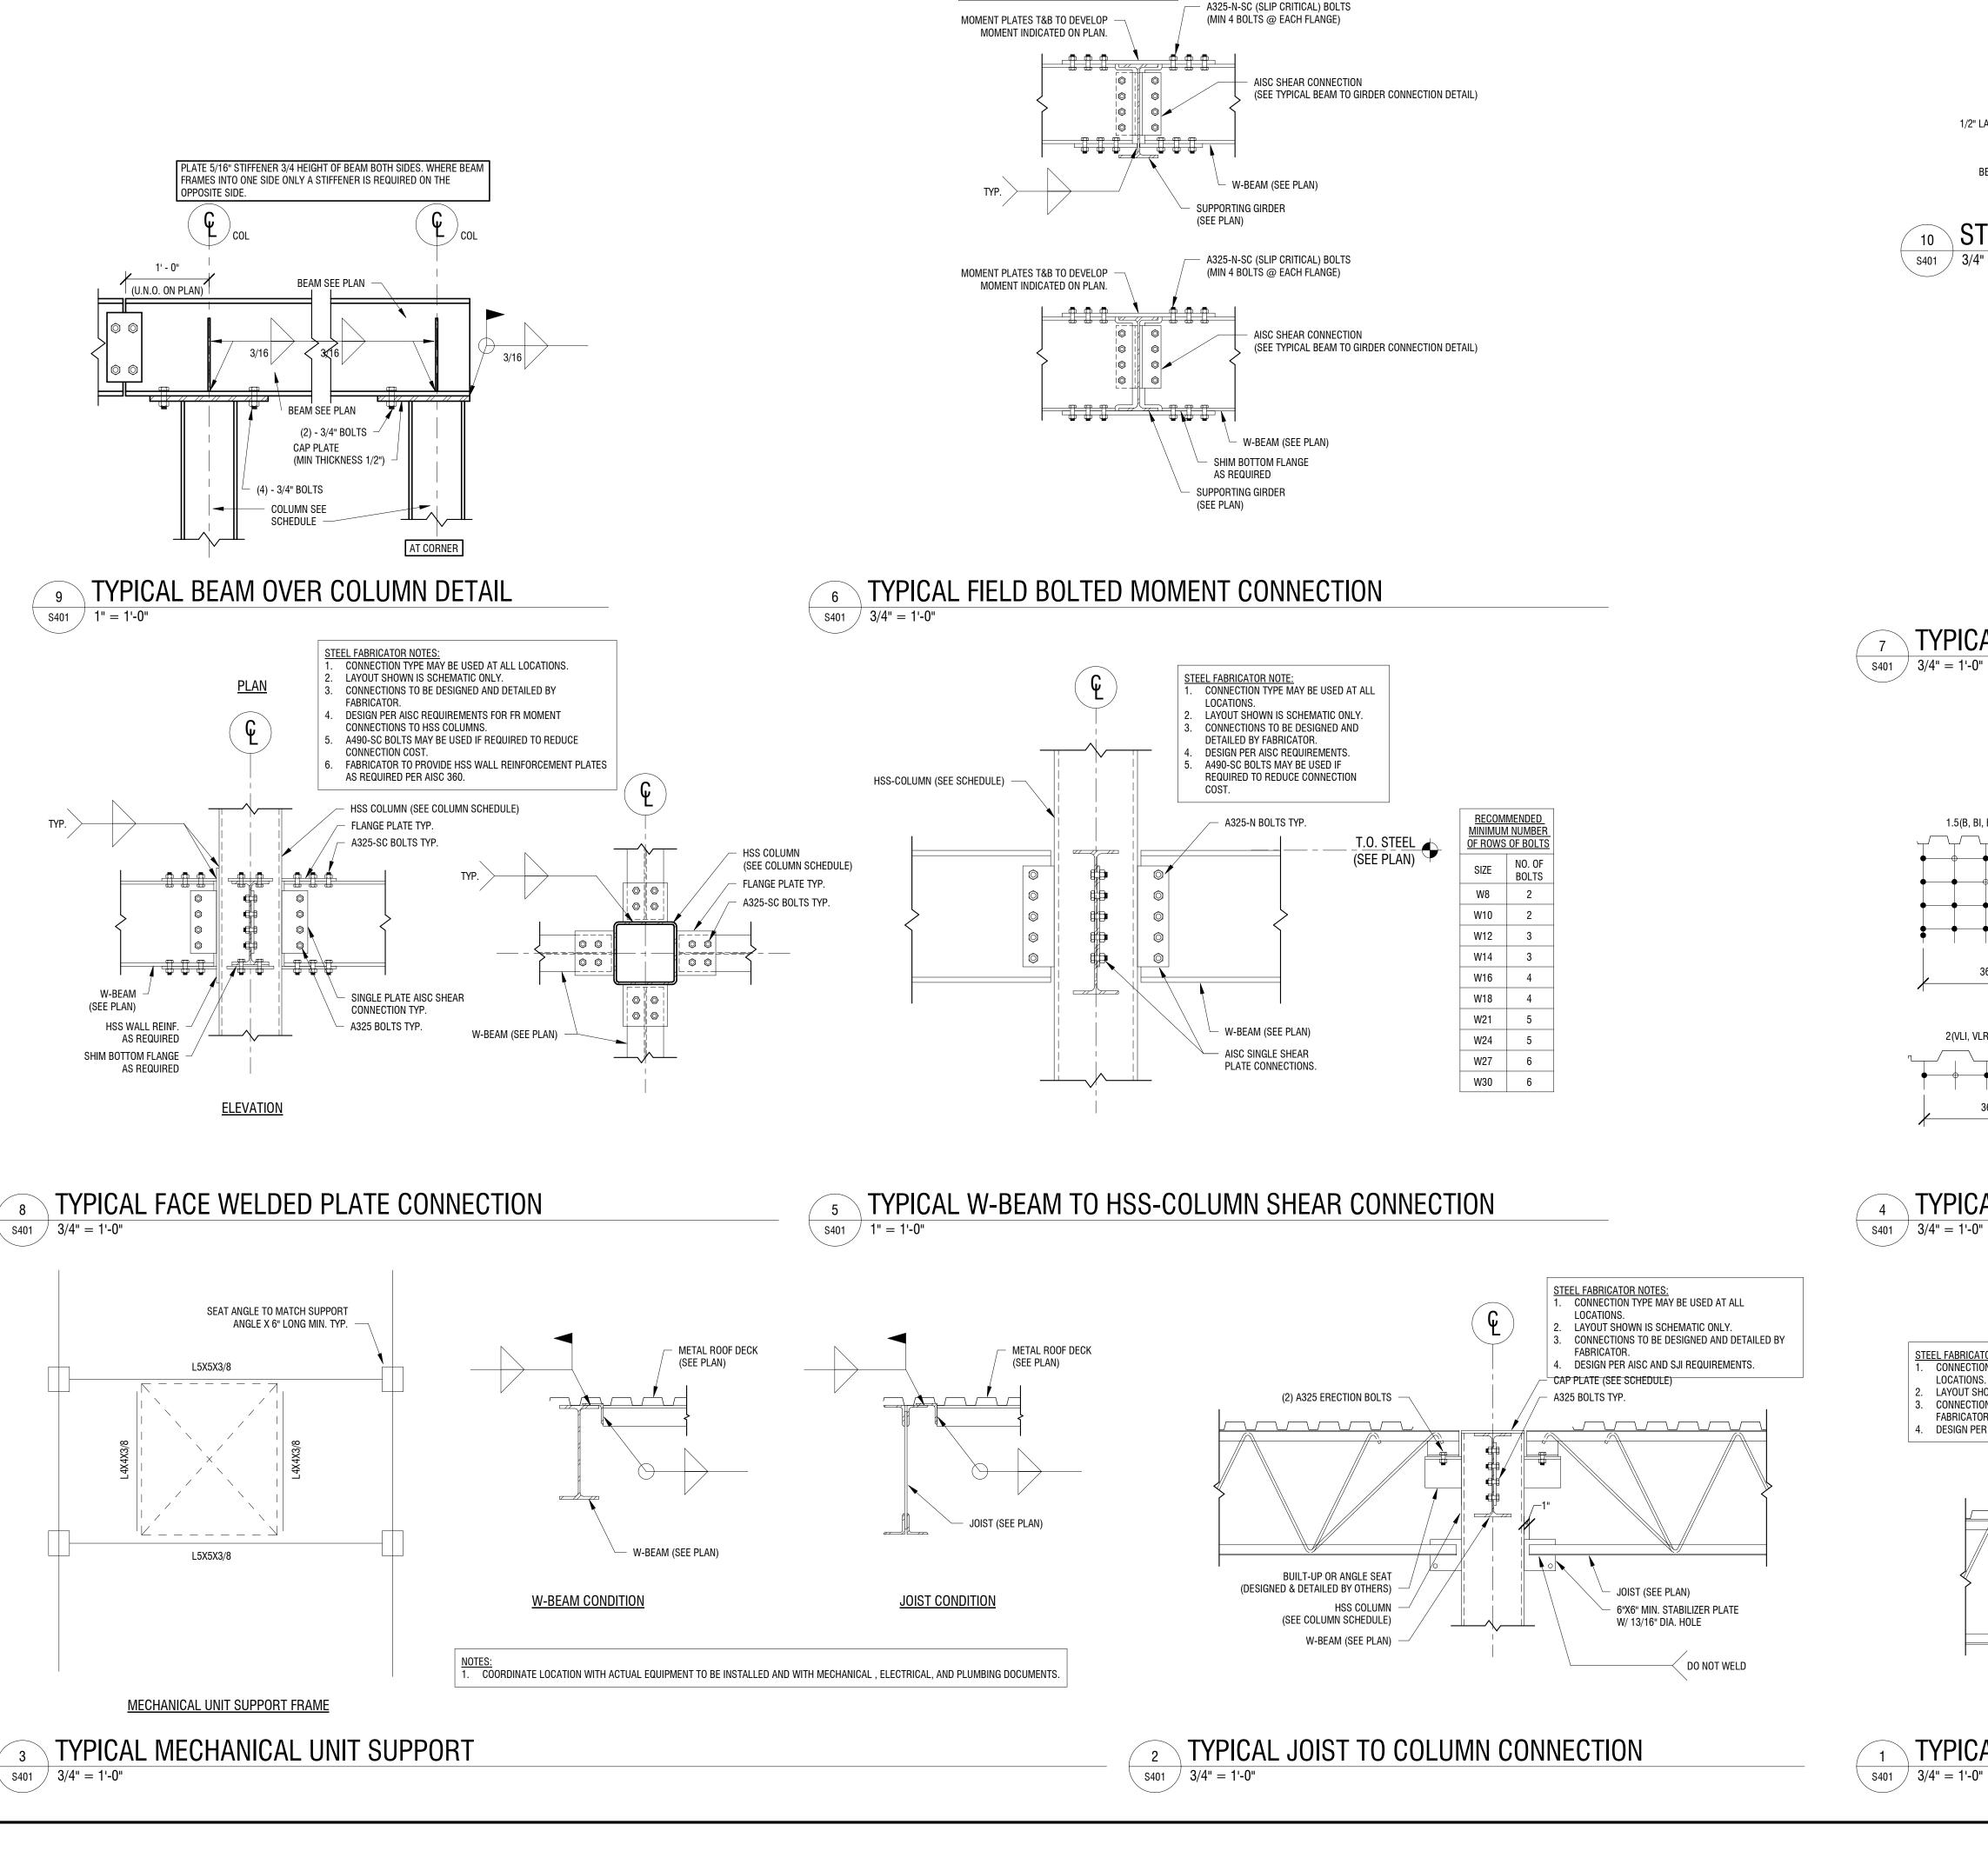
LCCU - Morrisville Site Adapt

9521 Chapel Hill Rd. Morrisville, NC 27560

NO:	DATE:	DES	CRIPTION:
Revisions			
PROJECT N	IUMBER:	2220150	
		2230150	
DRAWN BY	' :	JLW	
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REVIEWED BY:		DRH	
ISSUED FO	D.		
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DATE:		08.23.2024	
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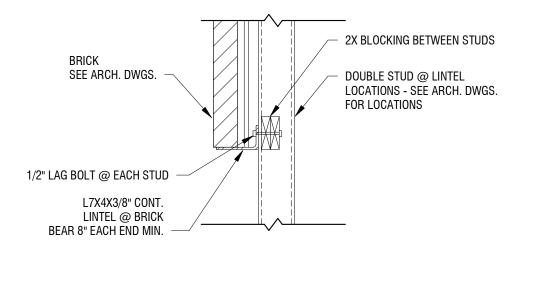
TYPICAL SLAB-ON-GRADE & FOUNDATION DETAILS

DRAWING NUMBER:




STEEL FABRICATOR NOTE: A490-N-SC BOLTS MAY BE USED IF REQUIRED BY


MAGNITUDE OF BEAM END REACTIONS.






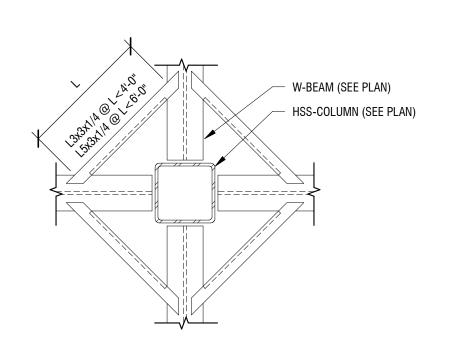

7 TYPICAL DECK SUPPORT AT HSS-COLUMNS 3/4" = 1'-0"

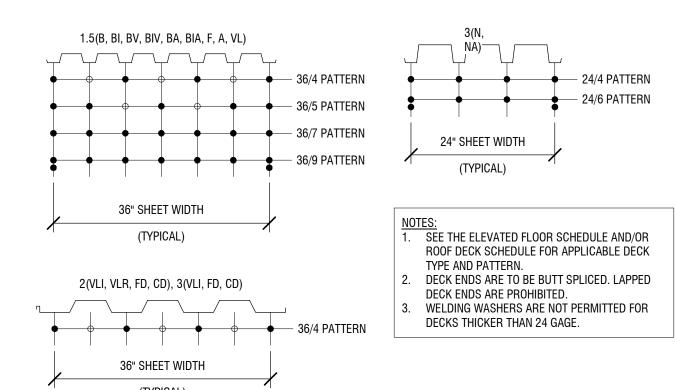


4 TYPICAL METAL DECK FASTENING LAYOUT 3/4" = 1'-0"

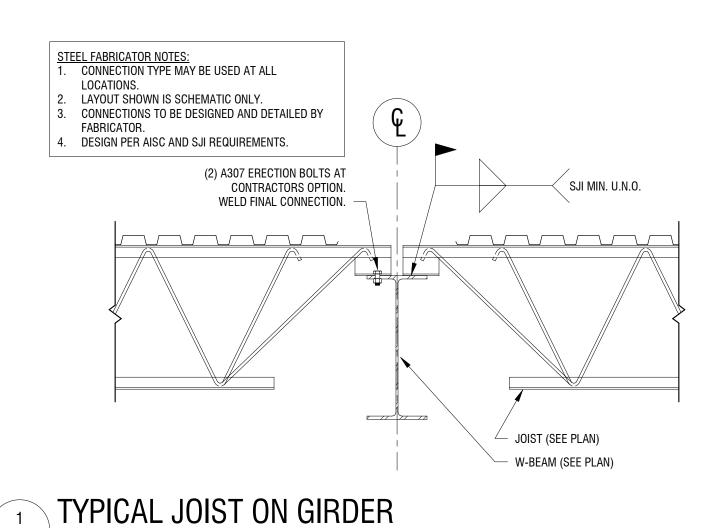

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NO: DATE: DESCRIPTION:
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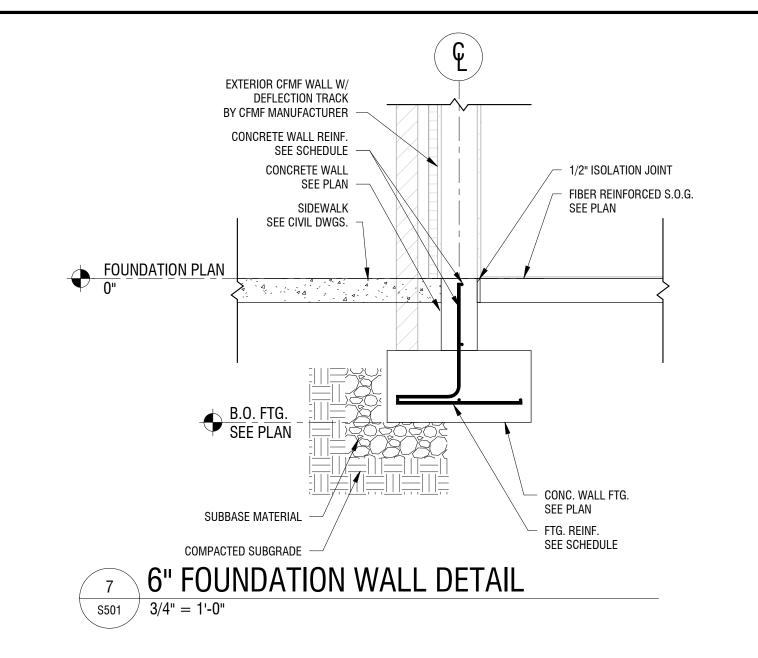
DRAWN BY:
JLW
REVIEWED BY:
DRH


ISSUED FOR:
BID SET

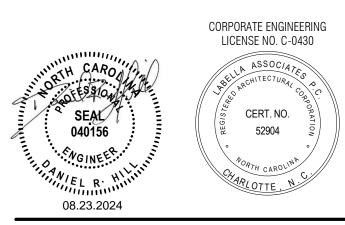
DATE:
08.23.2024

TYPICAL STEEL DETAILS

DRAWING NUMBER:




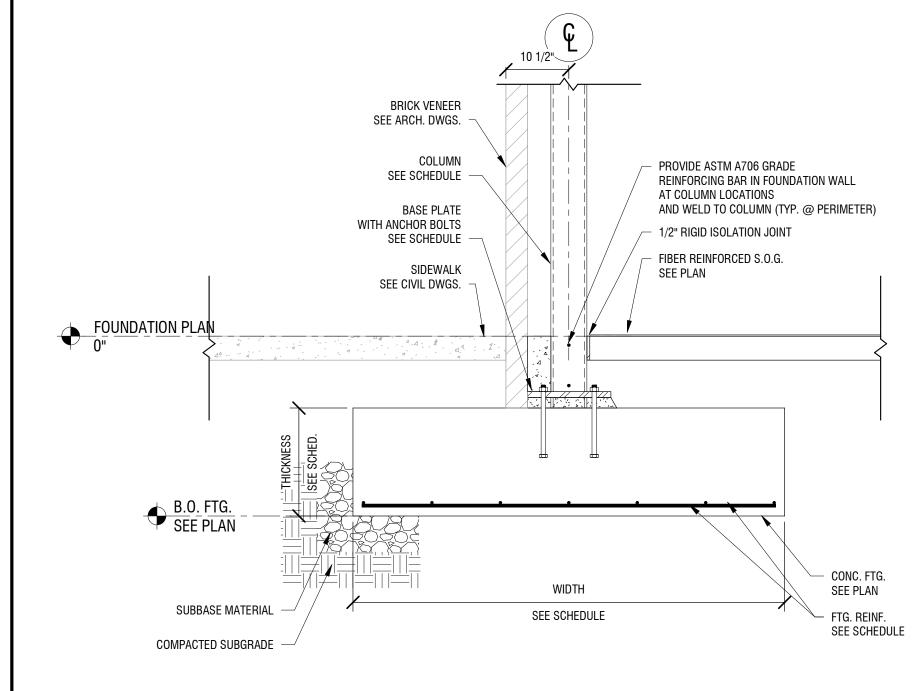

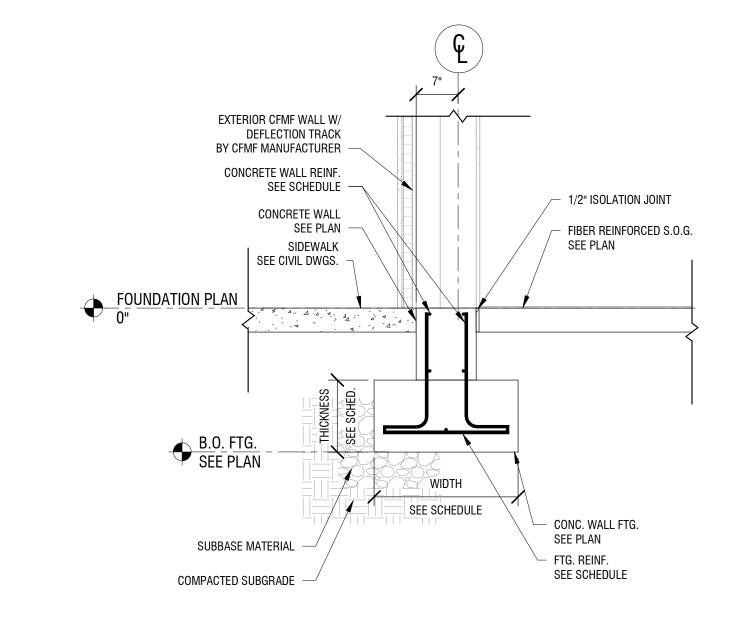

FOUNDATION WALL DETAIL

5 **FOUND** \$501 3/4" = 1'-0"

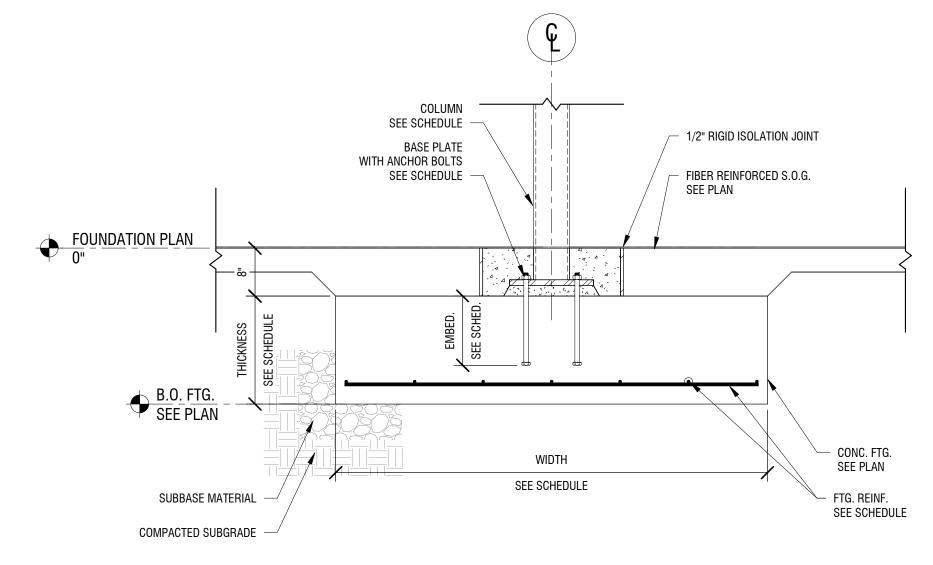

STEEL COLUMN AT BRICK SHELF FOUNDATION DETAIL

1/2" ISOLATION JOINT

CONC. WALL FTG. SEE PLAN

SEE SCHEDULE

FTG. REINF.

SEE SCHEDULE

FIBER REINFORCED S.O.G.

CURTAIN WALL

SEE ARCH. DWGS.

CONCRETE WALL REINF. SEE SCHEDULE -

CONCRETE WALL

SEE CIVIL DWGS.

FOUNDATION PLAN

SUBBASE MATERIAL


THRESHOLD DETAIL


COMPACTED SUBGRADE

s501 3/4" = 1'-0"


SEE PLAN -

SIDEWALK

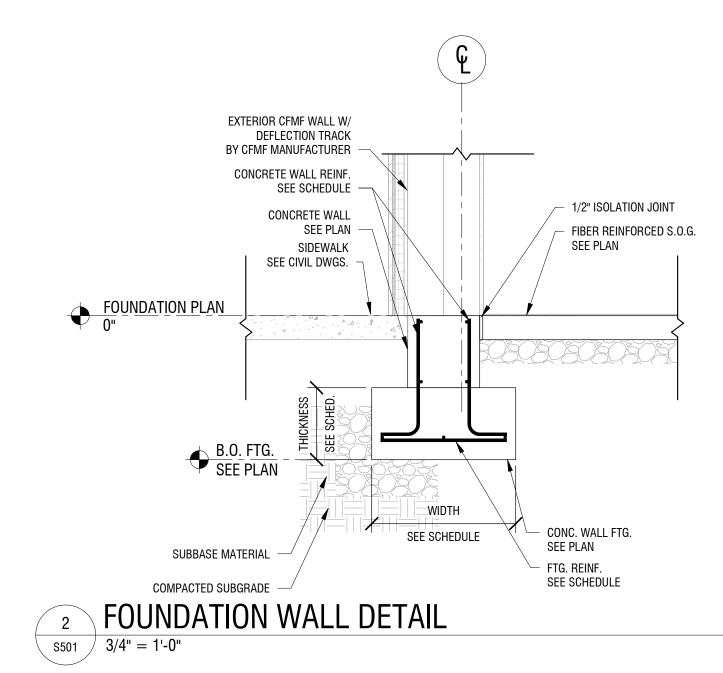

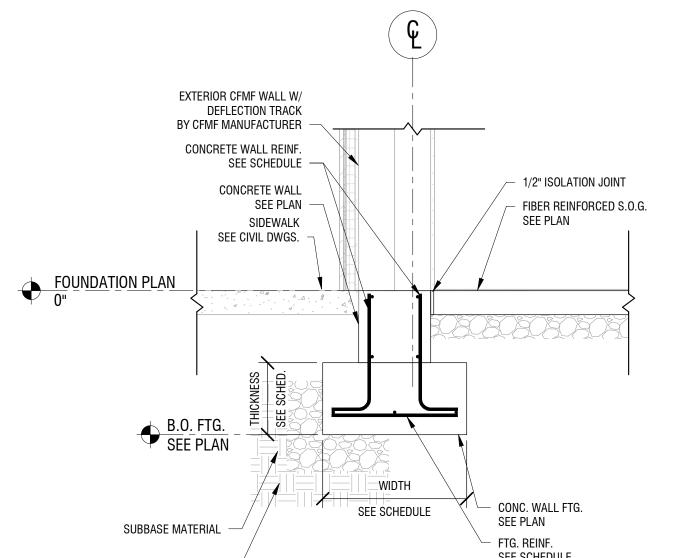


INTERIOR STEEL COLUMN FOUNDATION DETAIL 4 IN I ERIO 3/4" = 1'-0"

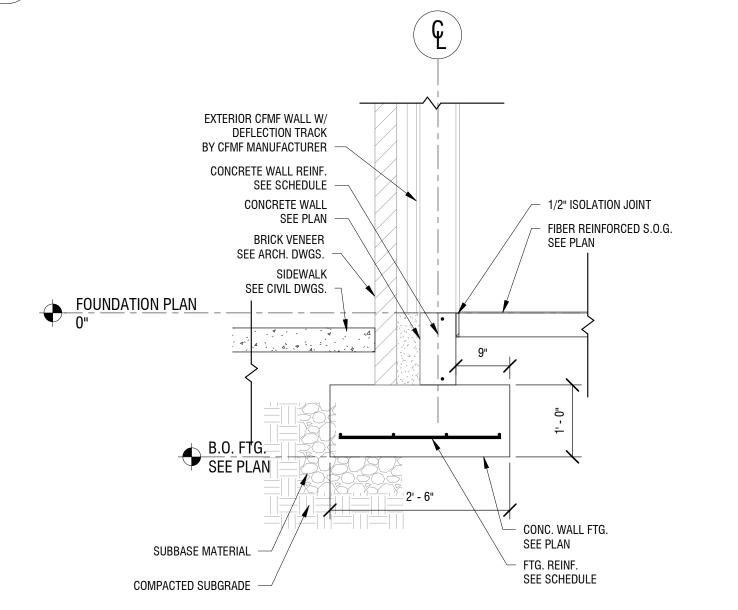

1 FOUNDATION WALL BRICK SHELF DETAIL

S501 3/4" = 1'-0"

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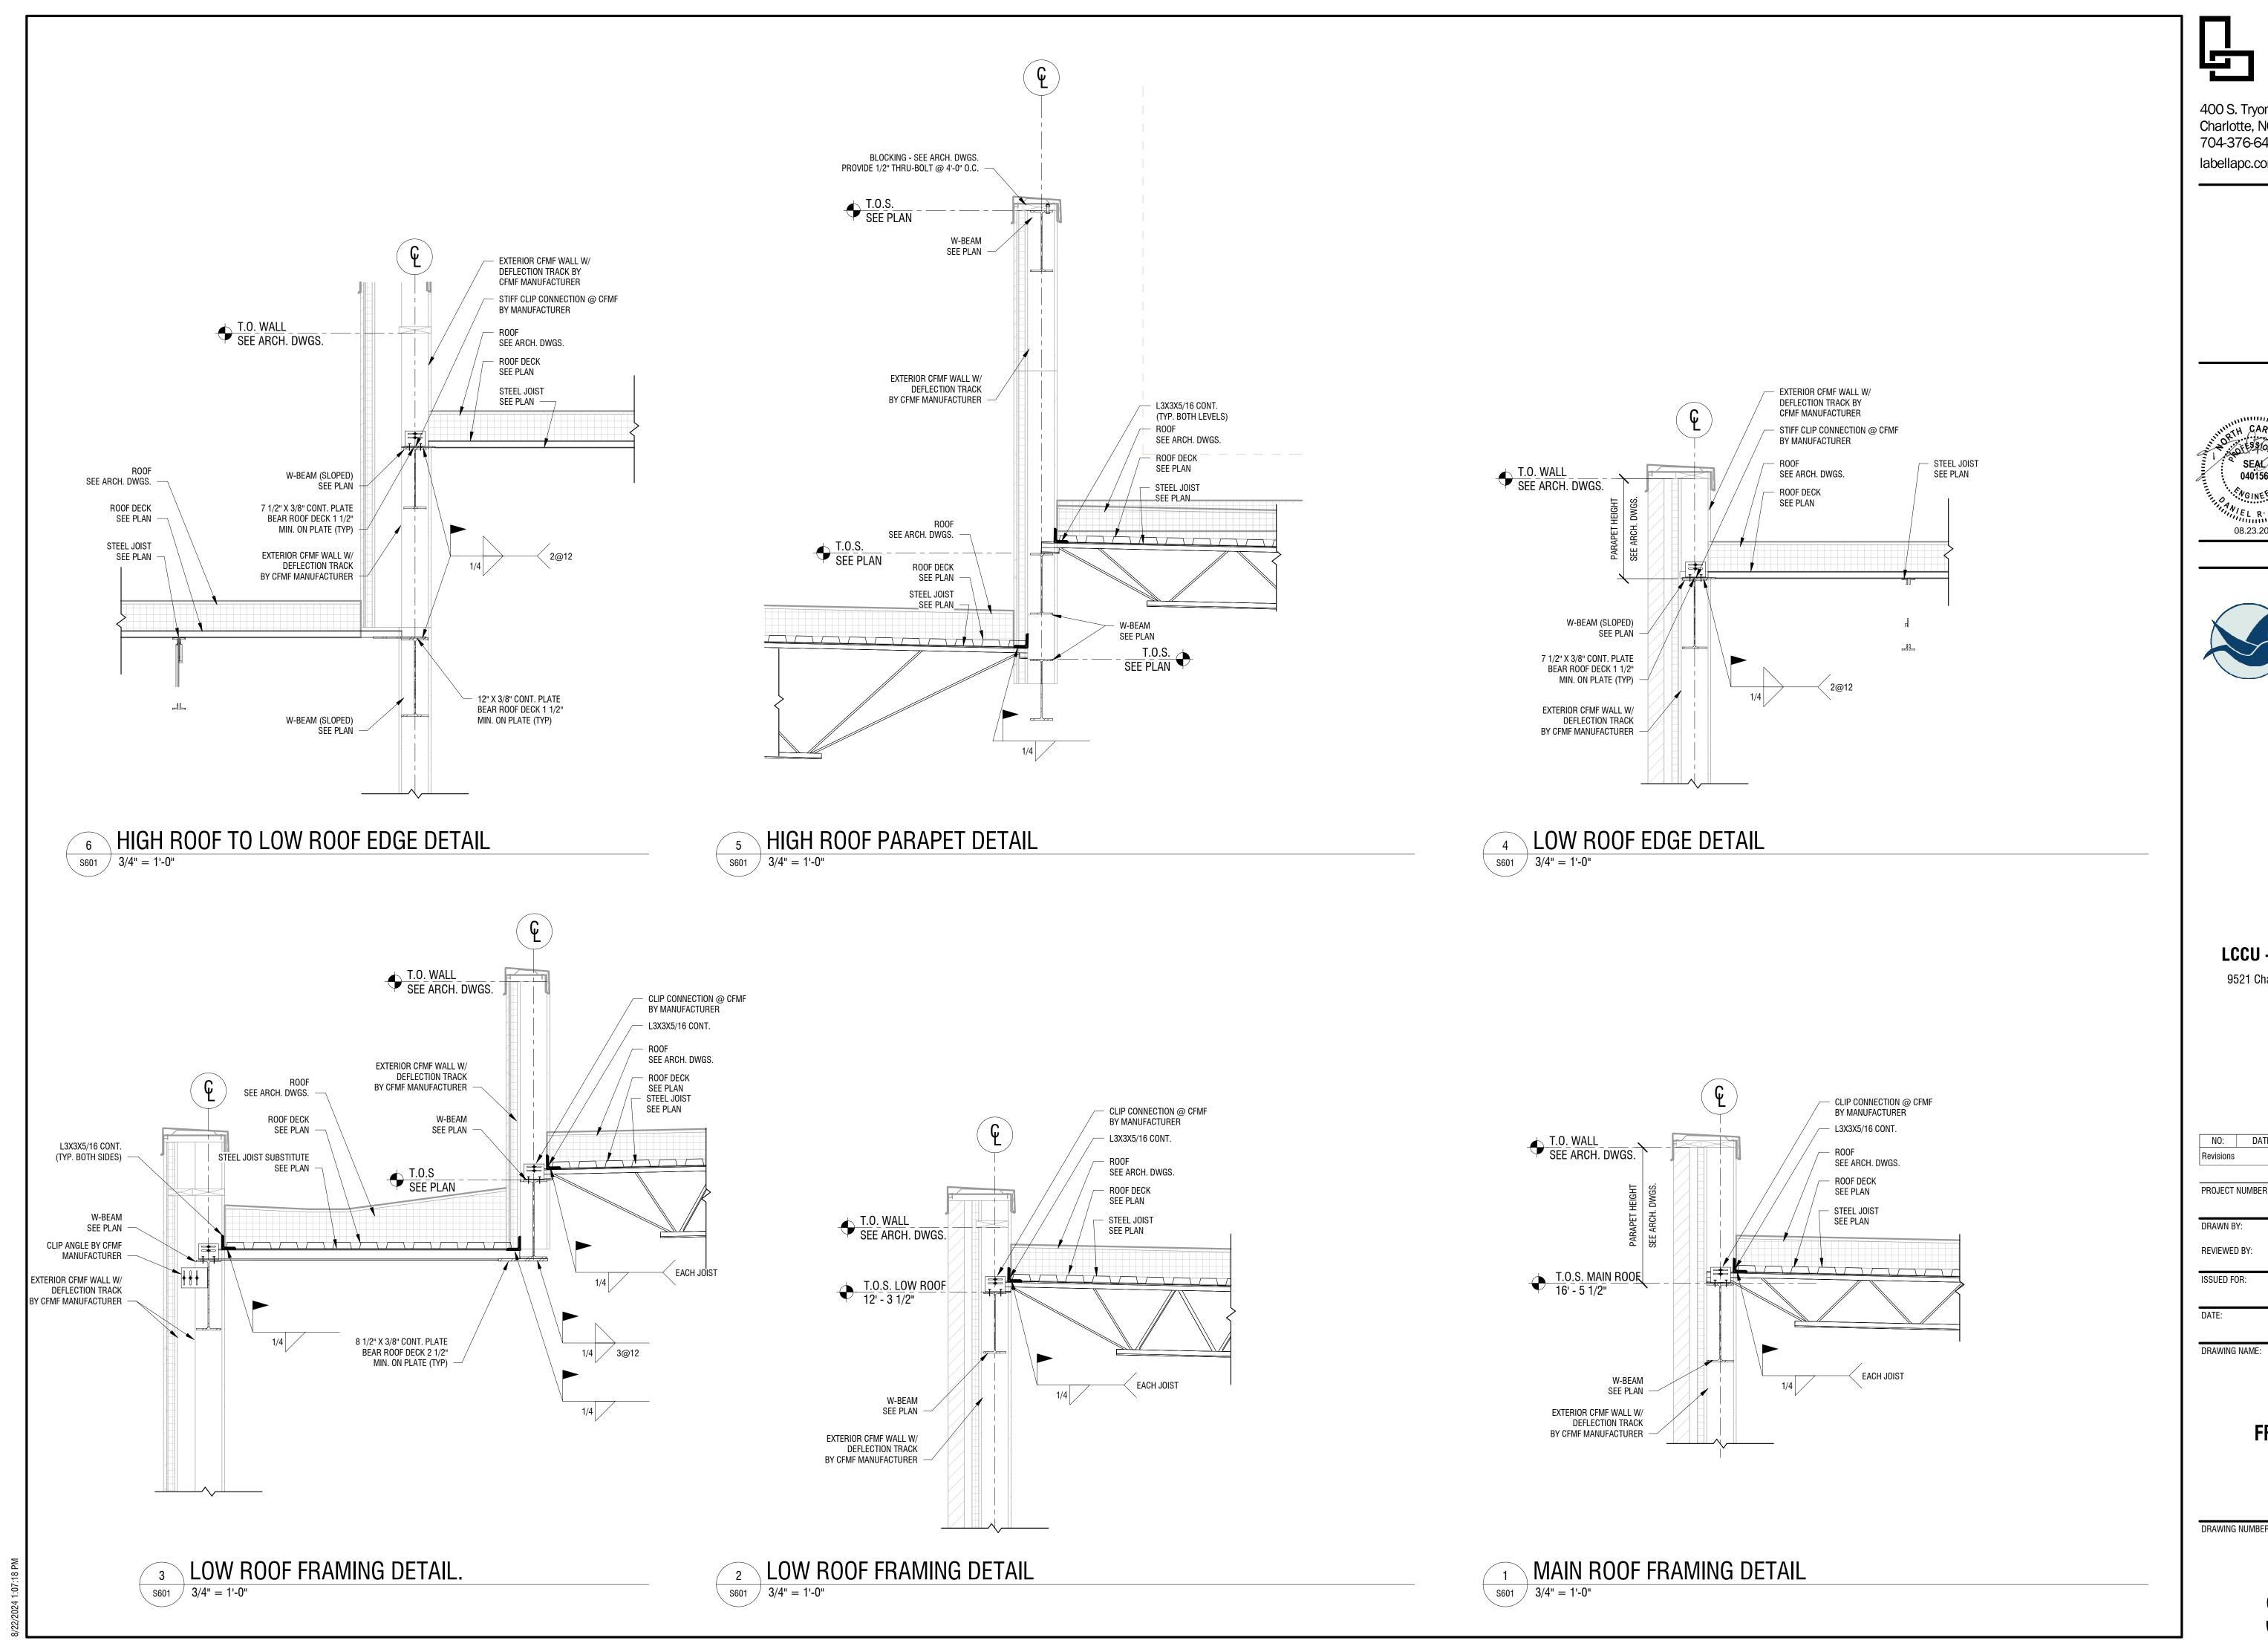
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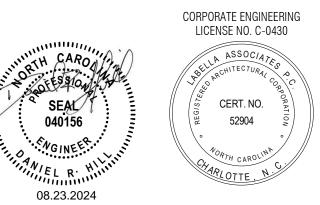
NO: DATE: DESCRIPTION: Revisions PROJECT NUMBER: 2230150 DRAWN BY: JLW REVIEWED BY: DRH ISSUED FOR: **BID SET** DATE: 08.23.2024

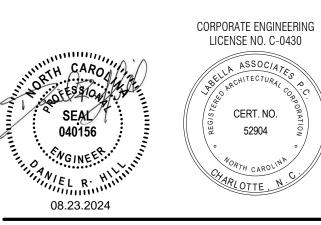FOUNDATION DETAILS

DRAWING NUMBER:

DRAWING NAME:





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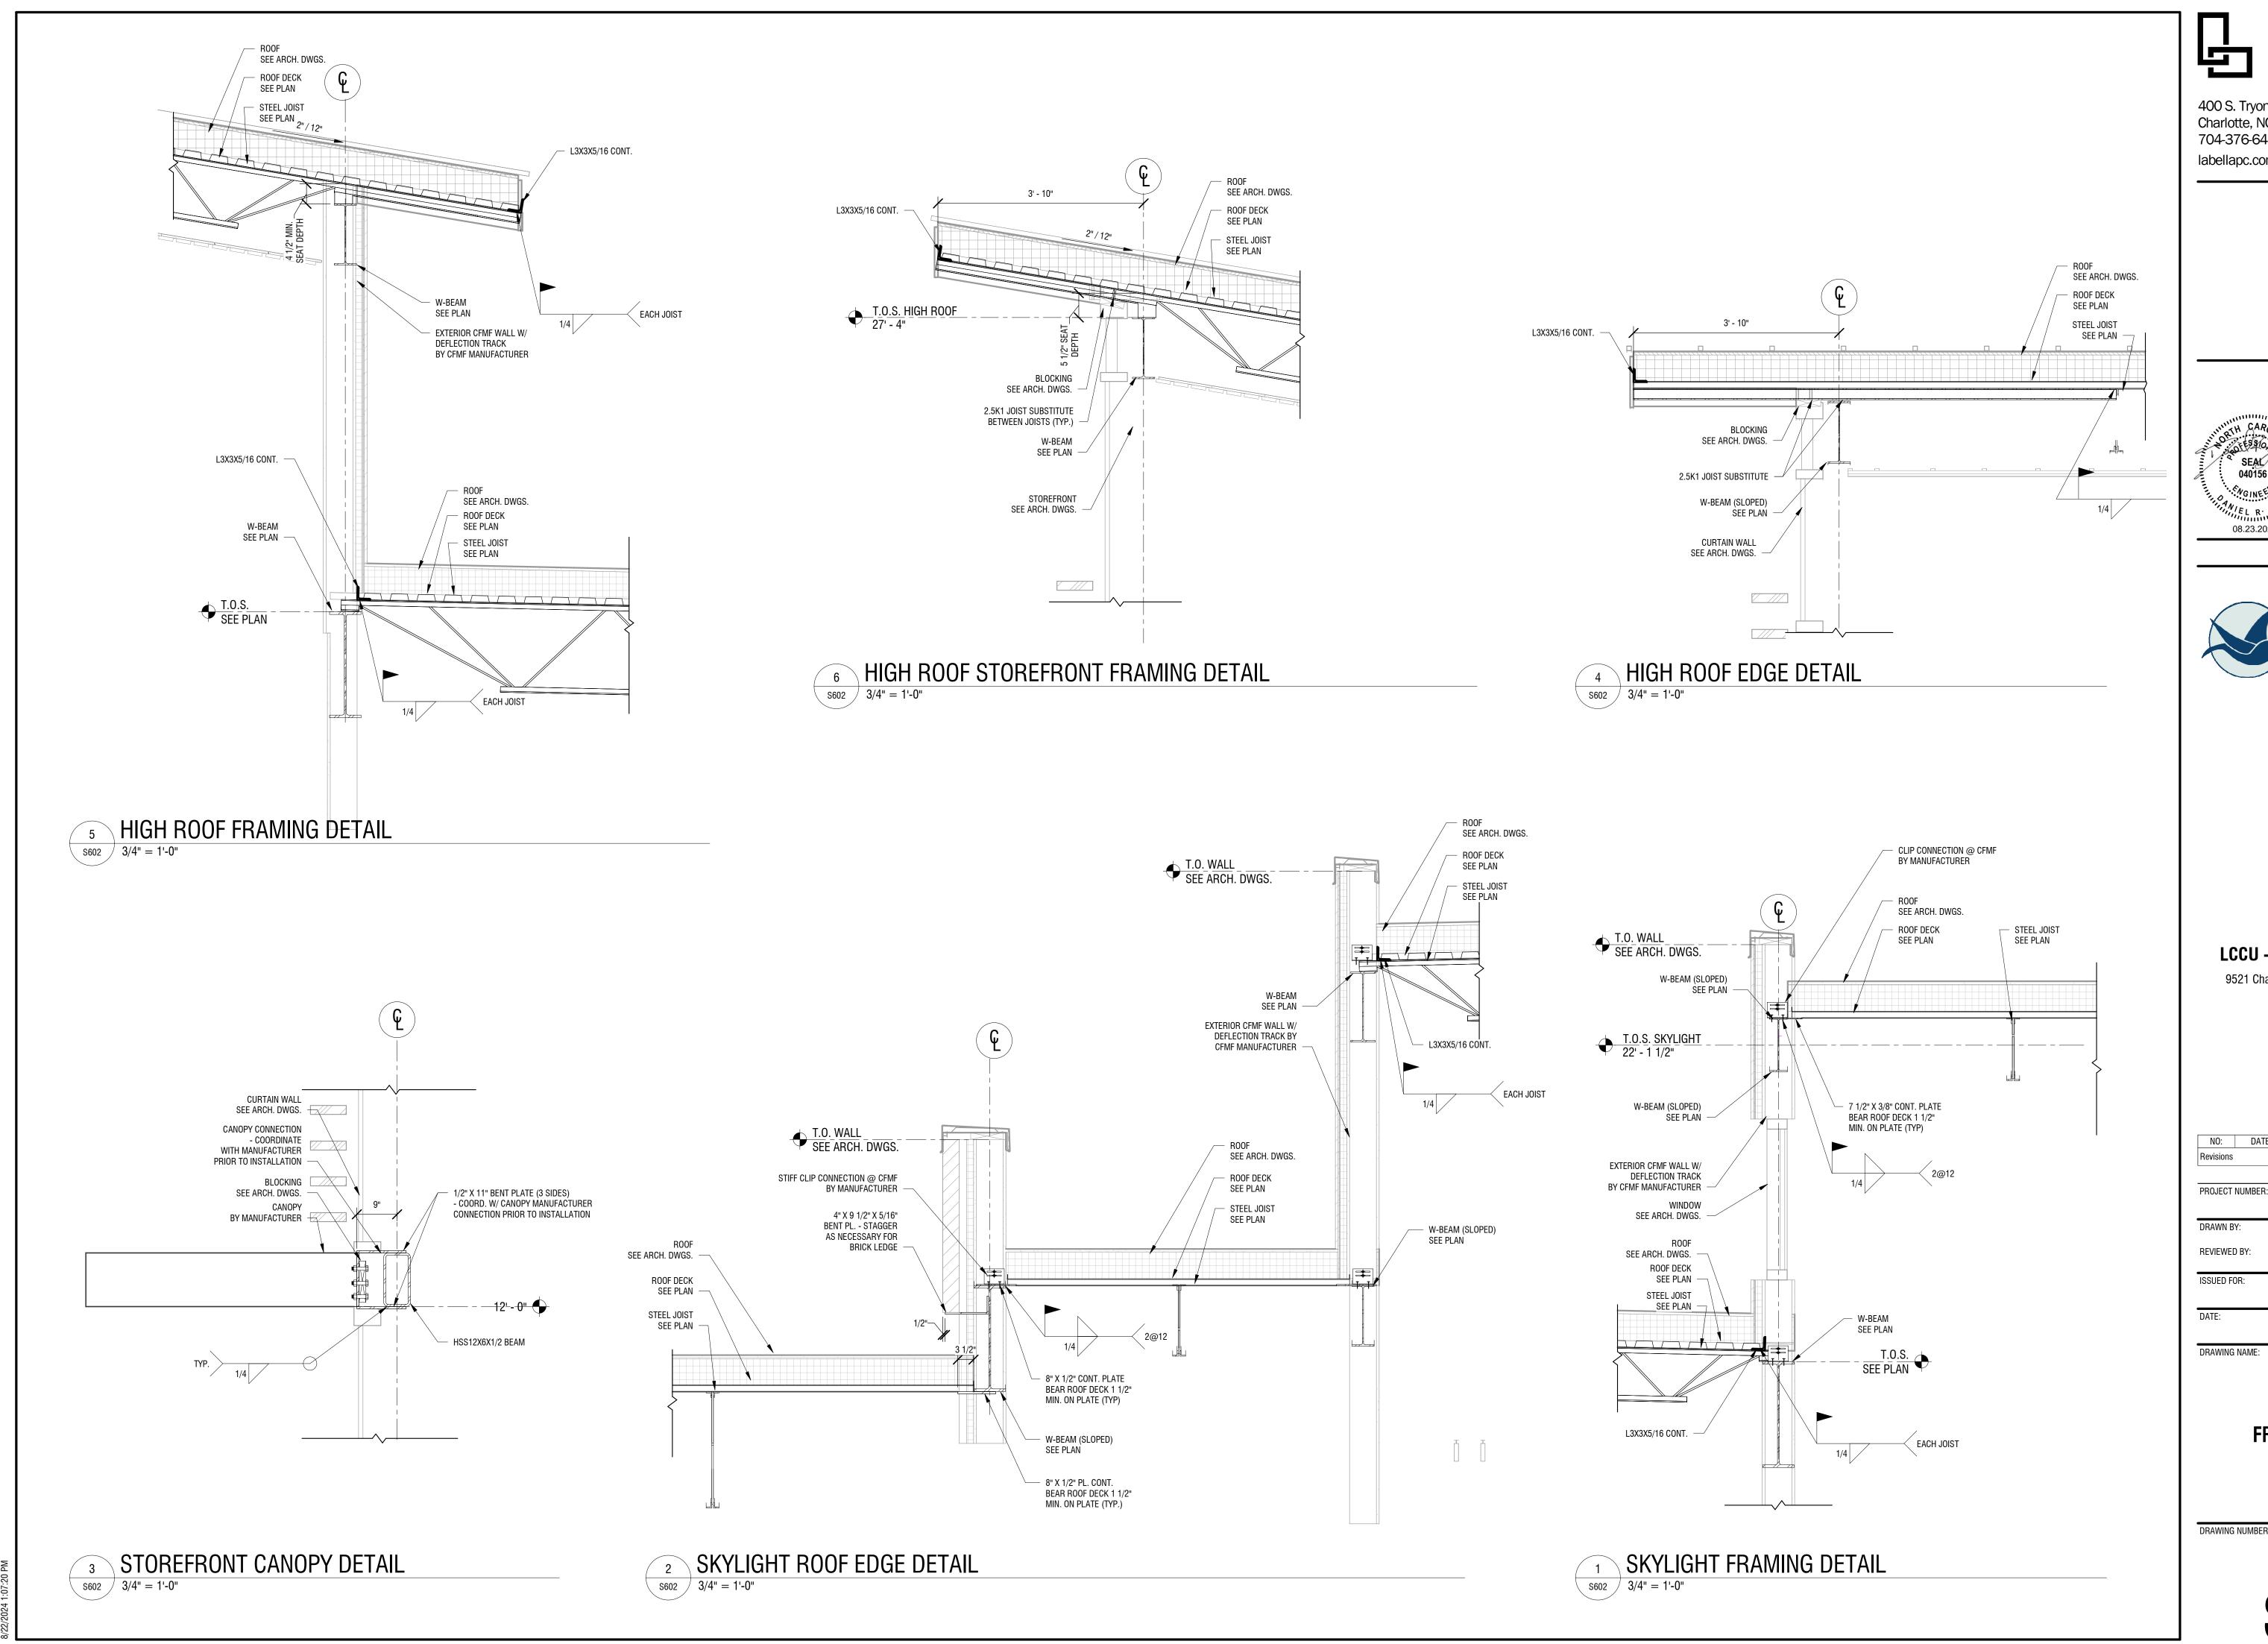


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FRAMING DETAILS


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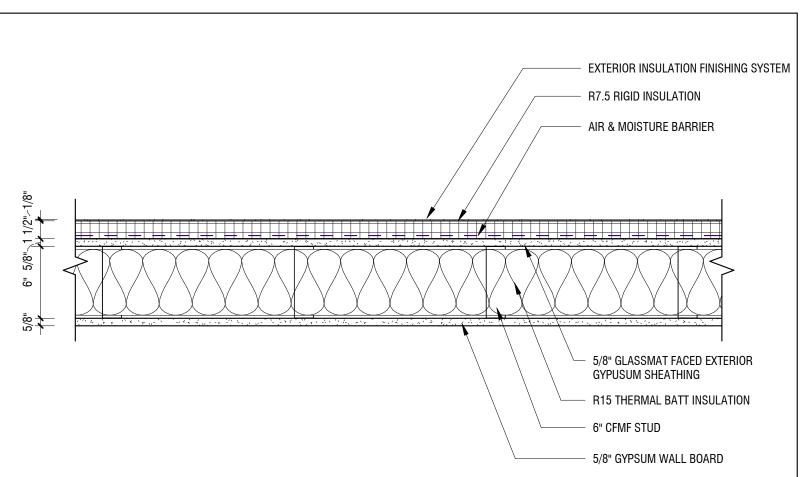
ASSEMBLY TYPES

DRAWING NUMBER:


DRAWING NAME:


SNAP ON STANDING SEAM METAL ROOFING SYSTEM 30# ROOFING FELT 19/32" FIRE-RETARDANT-TREATED PLYWOOD ROOF SHEATHING - R30 RIGID INSULATION — 1 1/2" METAL DECKING

R2 STANDING SEAM ROOF O/ METAL DECK

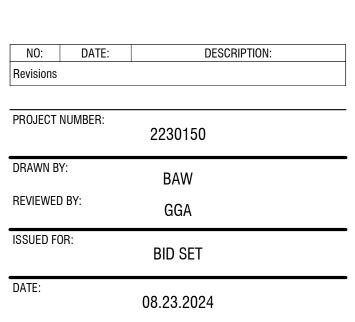


W6 EXT. WALL - EIFS 1 1/2" = 1'-0"

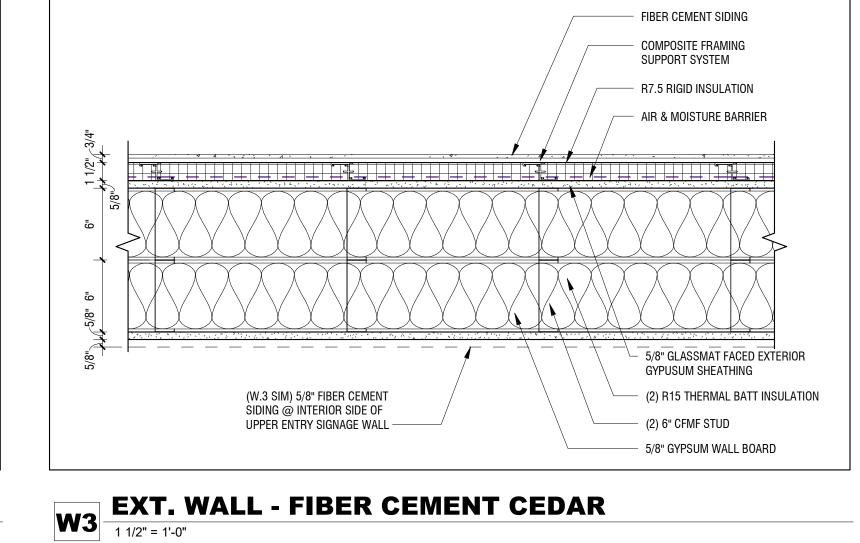


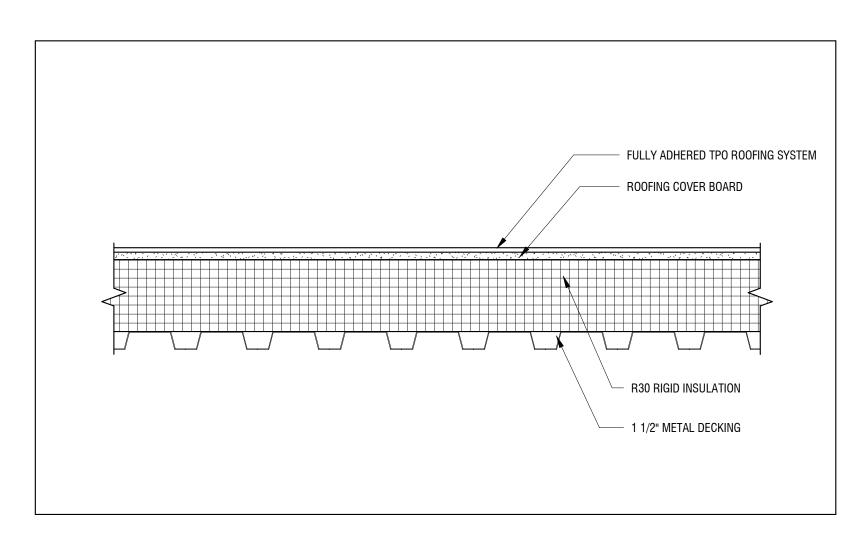


R1 TPO ROOF W/ RIGID O/ METAL DECK

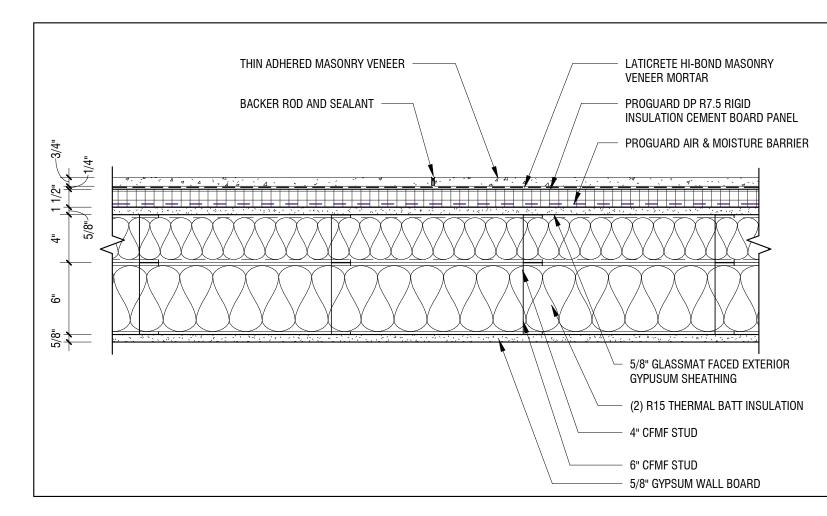


W5 EXT. WALL - FIBER CEMENT EMPIRE BLOCK

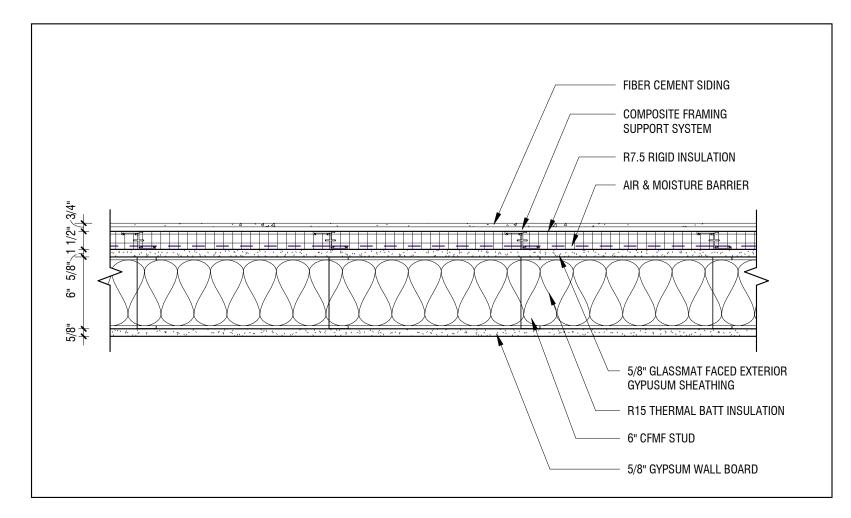


W2 EXT. WALL - FIBER CEMENT CEDAR

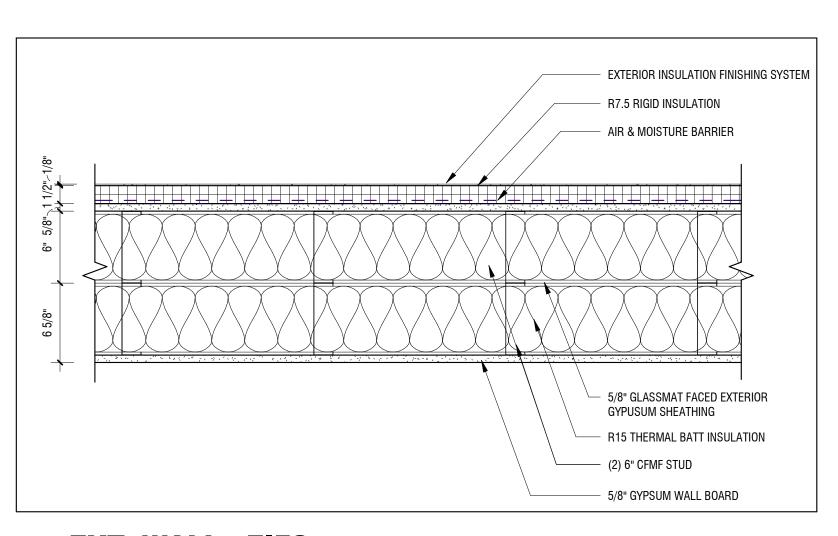


W7 EXT. WALL - EIFS
1 1/2" = 1'-0"

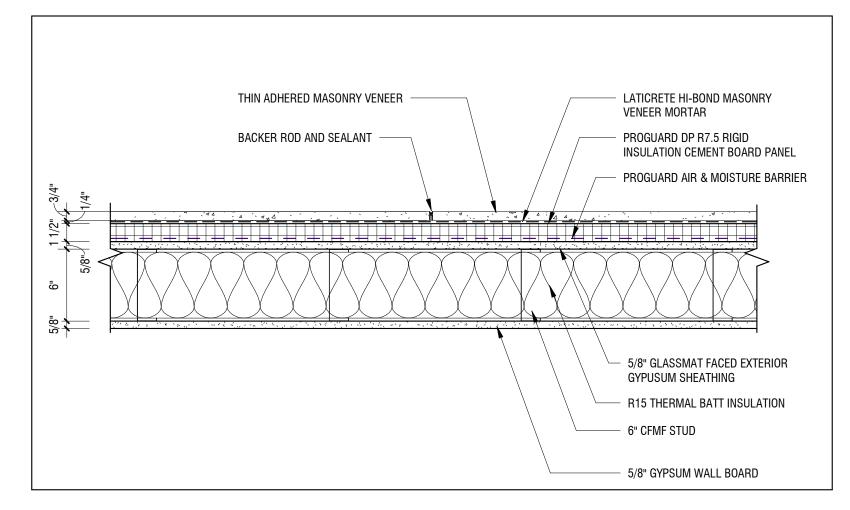

W4 EXT. WALL - FIBER CEMENT EMPIRE BLOCK

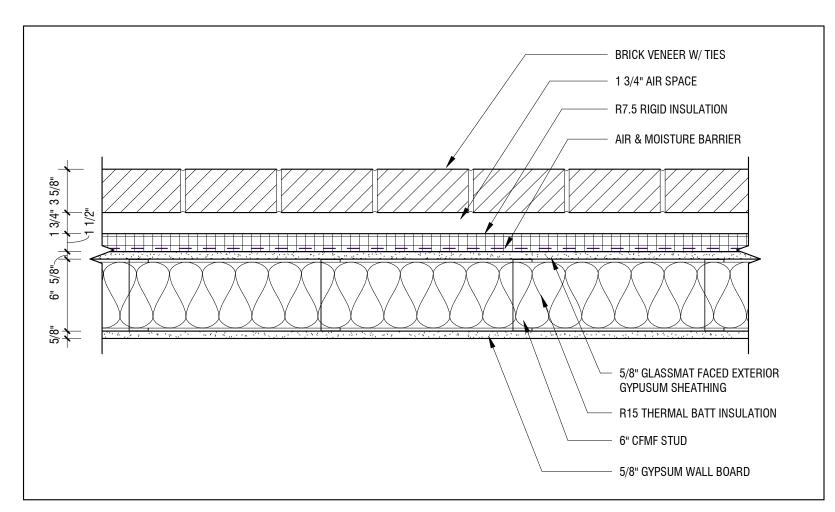


W1 EXT. WALL - BRICK VENEER

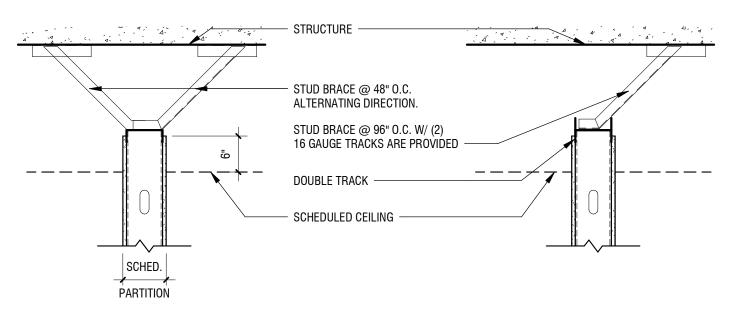

METAL STUD BRACE, AT A MINIMUM, EQUAL TO FRAMING OF BRACED PARTITION
 COORDINATE BRACE LOCATIONS W/ WORK OF ALL OTHER TRADES

PARTITION DETAILS - BRACED PARTITION


A002 SCALE: 3/4" = 1'-0"

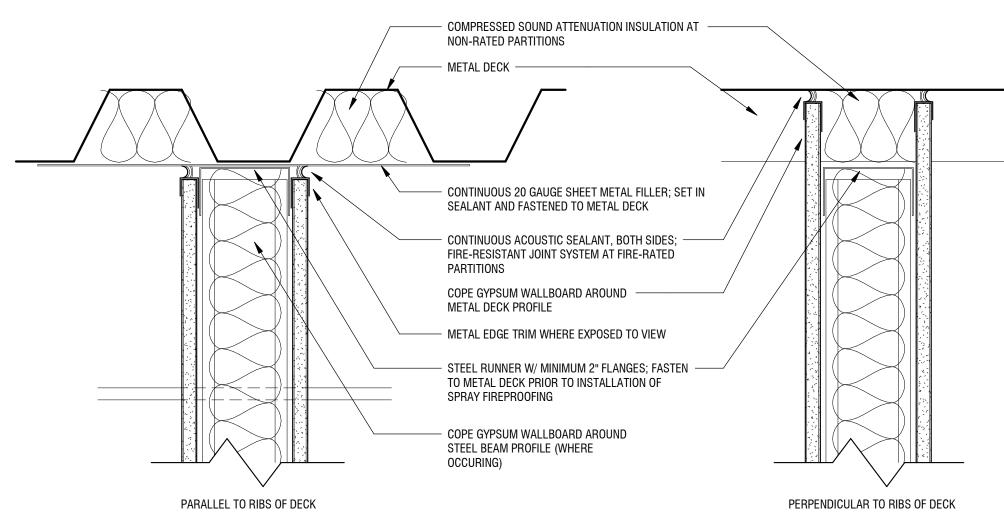

NOTE: FASTEN STEEL RUNNER TO METAL DECK; FRICTION FIT METAL STUDS TO RUNNER AND FASTEN GYPSUM WALLBOARD TO STUDS (DO NOT FASTEN TO RUNNER); MAINTAIN 3/4" - 1" GAP BETWEEN METAL DECK AND METAL STUD / GYPSUM WALLBOARD TO ACCOMODATE DEFLECTION OF STRUCTURE

² PARTITION DETAILS - METAL STUD


A002 | SCALE: 3" = 1'-0"

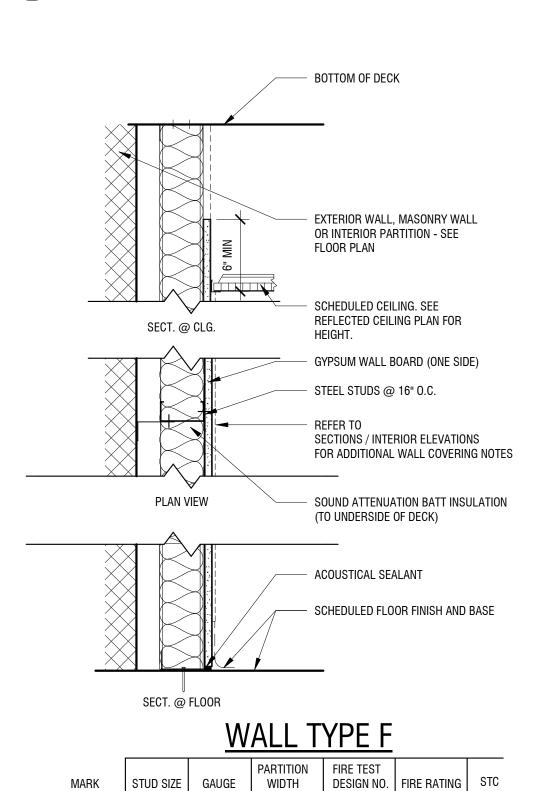

NON-RATED

NON-RATED

NON-RATED

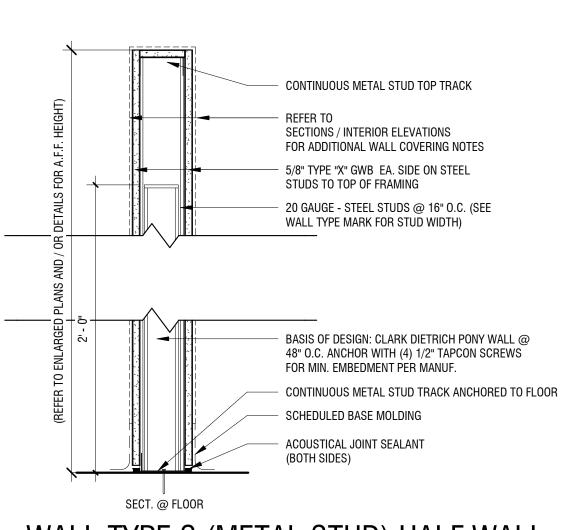

WALL TYPE S (METAL STUD) HALF WALL STUD SIZE GAUGE PARTITION FIRE TEST DESIGN NO. FIRE RATING STC EACH SIDE

NON-RATED

1x 5/8" + 1x 5/8"


20 GA

9 1/4"

EDUAL EQUAL

PARTITION DETAILS - TYPICAL INTERIOR METAL STUD FRAMING

A002 | SCALE: 1/4" = 1'-0"

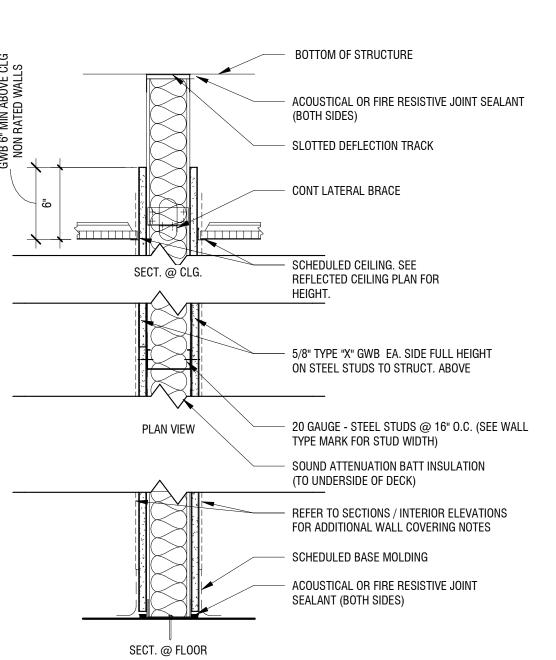

WALL TYPE S (METAL STUD)

_		STUD SIZE	GAUGE	PARTITION WIDTH	FIRE TEST DESIGN NO.	FIRE RATING	STC	GYPSUM LAYERS EACH SIDE
_	S2.0	2 1/2" (x2)	20 GA	7 3/4"		NON-RATED		1x 5/8" + 1x 5/8"
	S3.0	3 5/8"	20 GA	4 7/8"		NON-RATED		1x 5/8" + 1x 5/8"
	S6.0	6"	20 GA	7 1/4"		NON-RATED		1x 5/8" + 1x 5/8"

PARTITION TYPE LEGEND:



MATERIAL DESIGNATION

- S METAL STUDS @ 16" O.C., REFER TO TYPES FOR GA./MIL THICKNESS
- METAL STUDS @ 12" O.C./ FURRING CHANNELS / HAT CHANNELS/ Z-FURRING CHANNELS x REFER TO TYPES FOR GA./MIL THICKNESS

SIZE SUFFIX

- 2 1/2" METAL STUDS
- 3 5/8" METAL STUDS
- 6 6" METAL STUDS
- 8" METAL STUDS

RATING SUFFIX

0 NON-RATED CMU OR METAL STUD PARTITION

ACCESSORIES SUFFIX

h HALF WALL COORDINATE WITH INTERIOR DRAWINGS.

GENERAL PARTITION NOTES:

- 1. ALL PARTITIONS EXTEND FROM CONCRETE FLOOR TO DECK ABOVE UNLESS OTHERWISE NOTED.
- FILL FLUTES IN DECK ABOVE PARTITION WITH FIRE SAFING INSULATION AND FIRE STOP ENTIRE PERIMETER AT RATED PARTITIONS, AND EXTERIOR WALLS WITH A UL LISTED JOINT SYSTEM FIRESTOP ASSEMBLY.
- 3. PROVIDE DEFLECTION TRACKS AT METAL STUD PARTITIONS THAT TERMINATE AT THE UNDERSIDE OF STRUCTURE/DECK ABOVE.
- 4. ALL NON-BEARING PARTITIONS SHALL BE CONSTRUCTED TO LIMIT DEFLECTION TO L/360 OF THE SPAN WITH UNIFORM 5 PSF HORIZONTAL LOADING.
- 5. ALL PENETRATIONS IN FIRE RATED PARTITIONS TO BE FIRE STOPPED AND SEALED.
- 6. ALL PARTITIONS SHALL BE SEALED TO PREVENT PASSAGE OF SMOKE.
- 7. CONTRACTOR TO REFER TO CODE/LIFE SAFETY DRAWINGS FOR RATED PARTITION LOCATIONS.
- 8. PROVIDE GLASS-MAT GYPSUM BOARD AT ALL WET LOCATIONS AND AREAS TO RECEIVE WALL TILE, REFER TO SPECIFICATION IN PROJECT MANUAL.
- 9. PROVIDE DOUBLE FRAMING AT ALL DOOR, WINDOW AND CASED OPENING JAMBS. PROVIDE BOX HEADERS AT ALL HEAD CONDITIONS.
- 10. FOR ALL PARTITIONS, GC TO COORDINATE AND PROVIDE BLOCKING FOR ALL TRADES (U.N.O.) NOT LIMITED TO WALL MOUNTED ARCHITECTURAL WOODWORK, FINISH CARPENTRY, TOILET PARTITIONS AND ACCESSORIES, EQUIPMENT, HANDRAILS, HARDWARE AND SIMILAR ITEMS. ALL BLOCKING TO BE FIRE TREATED.



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Revisions

PROJECT NUMBER:

2230150

DRAWN BY: BAW

REVIEWED BY: GGA

ISSUED FOR:

BID SET

DATE:

08.23.2024

DRAWING NAME:

PARTITION TYPES

DRAWING NUMBER:

A002

F3.0

3 5/8"

PARTITION TYPES


18 GA

18 GA

18 GA

4 1/4"

6 5/8"

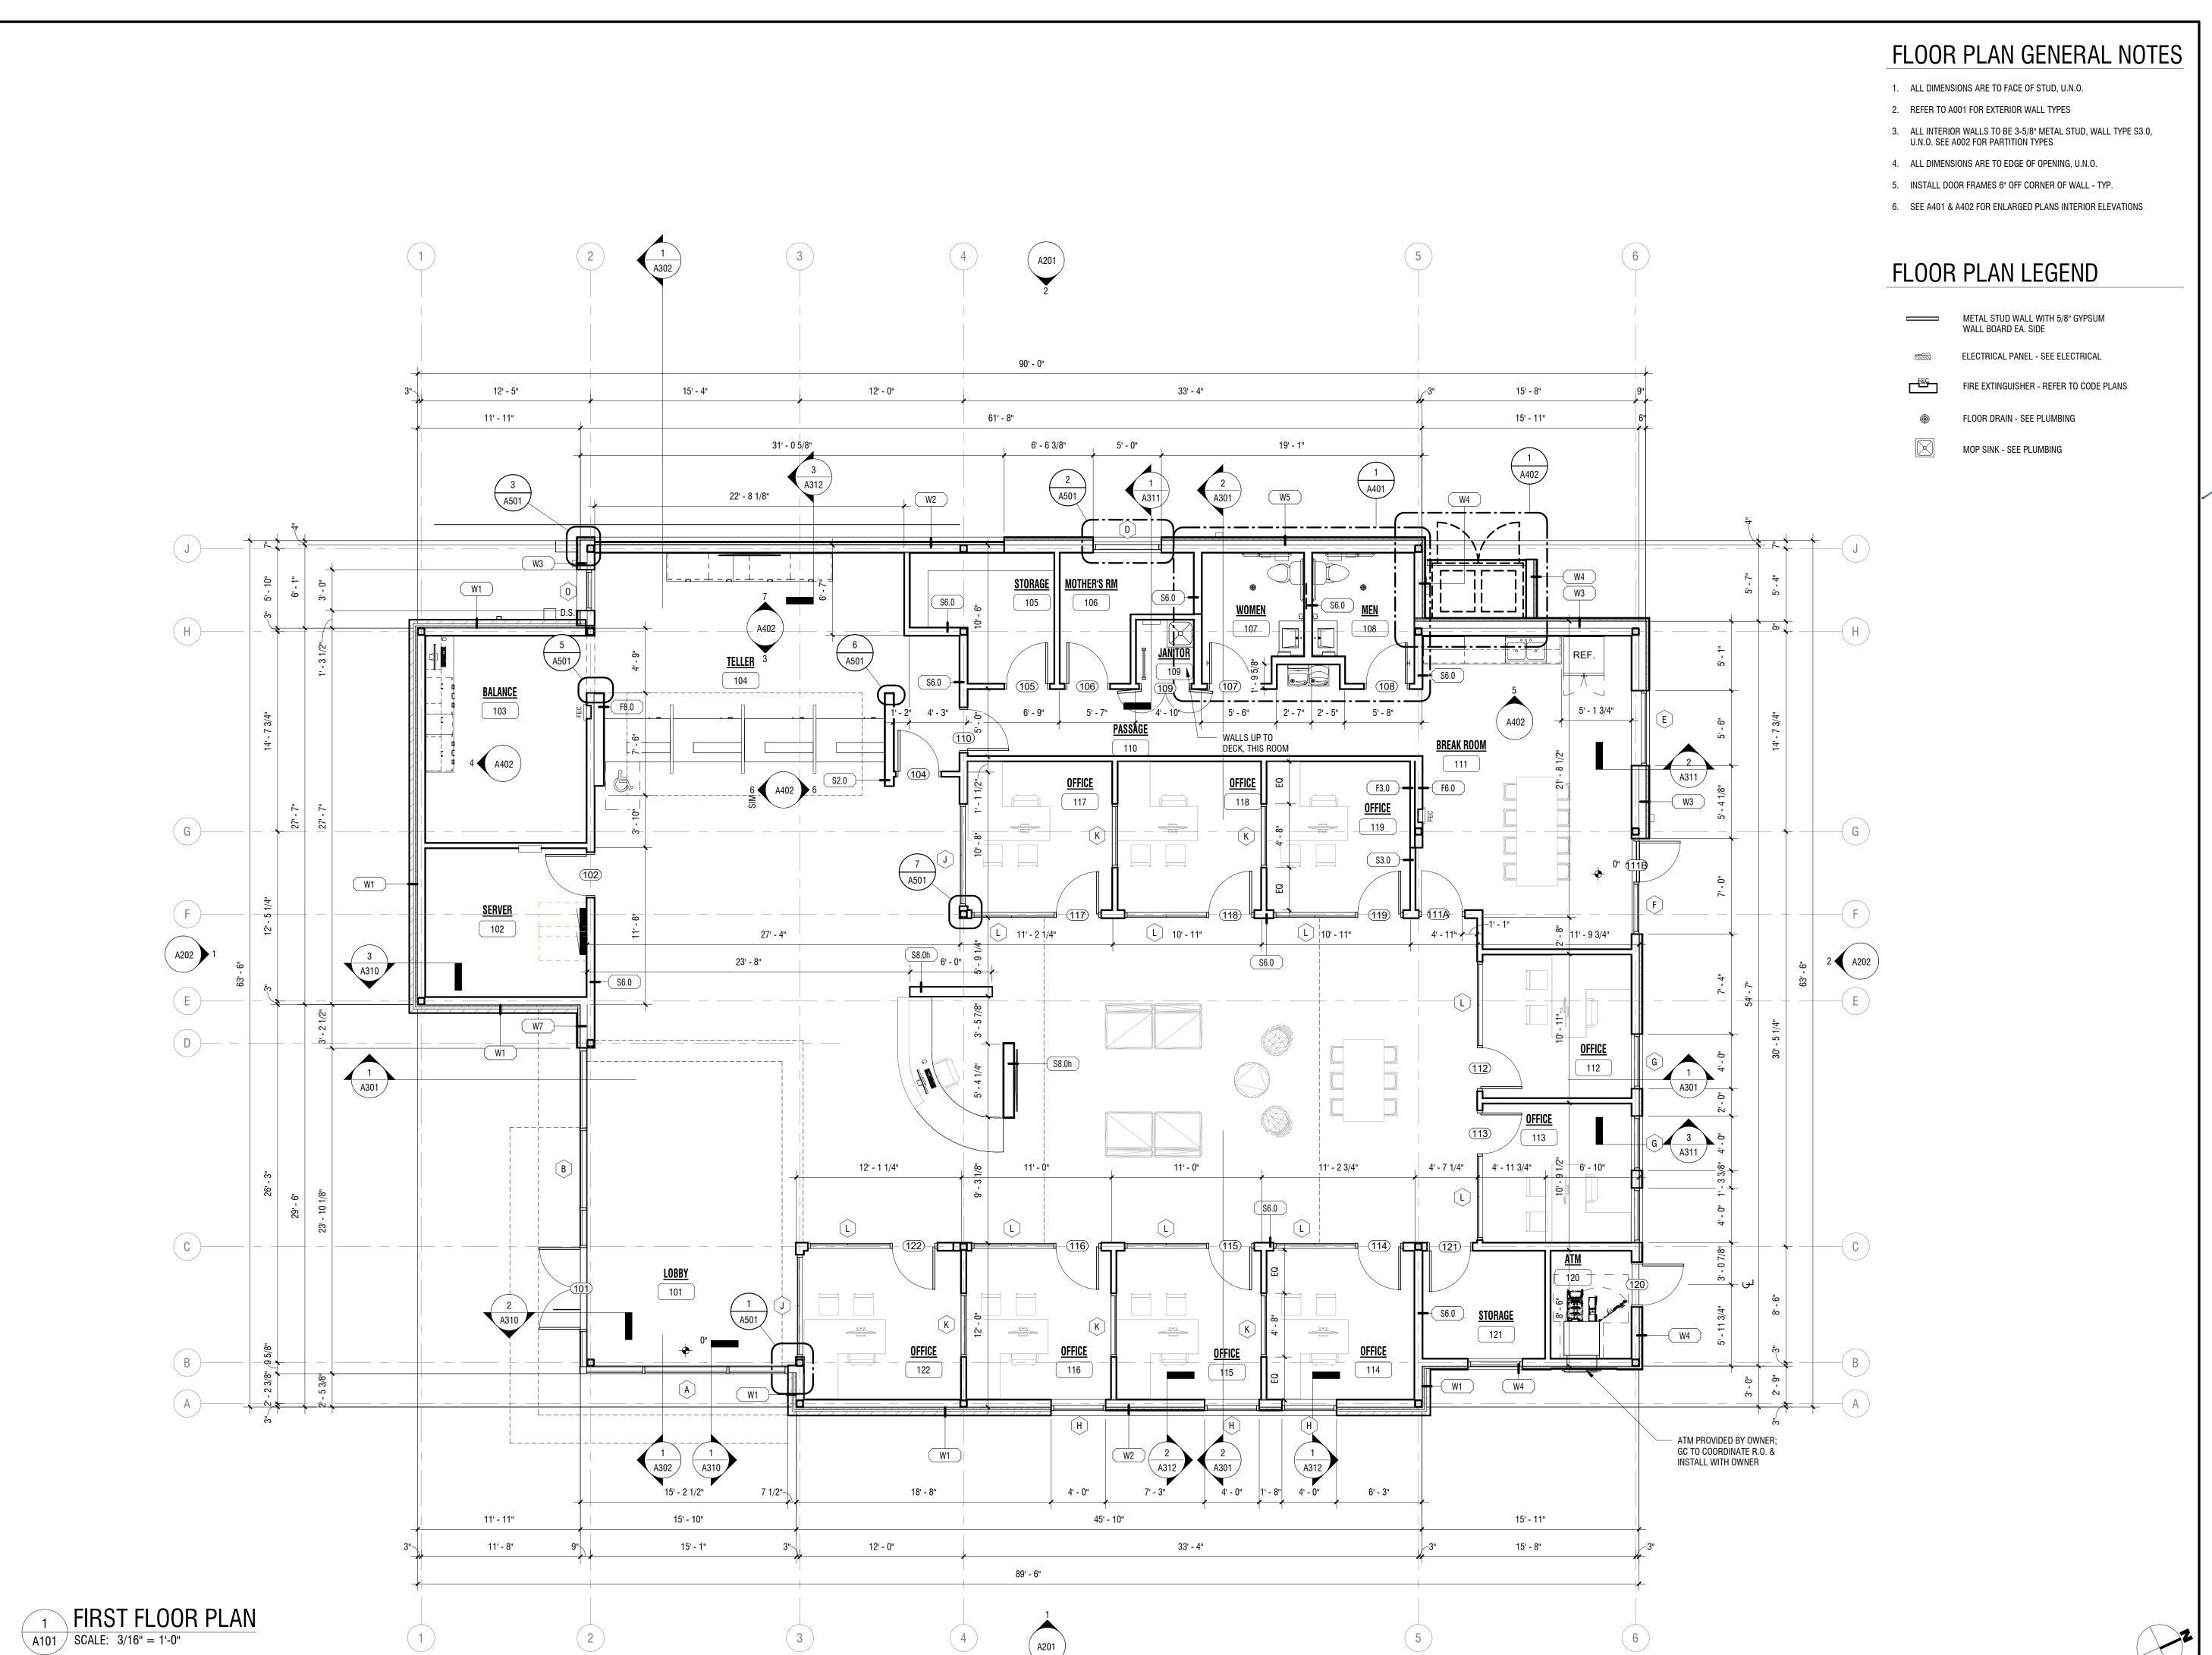





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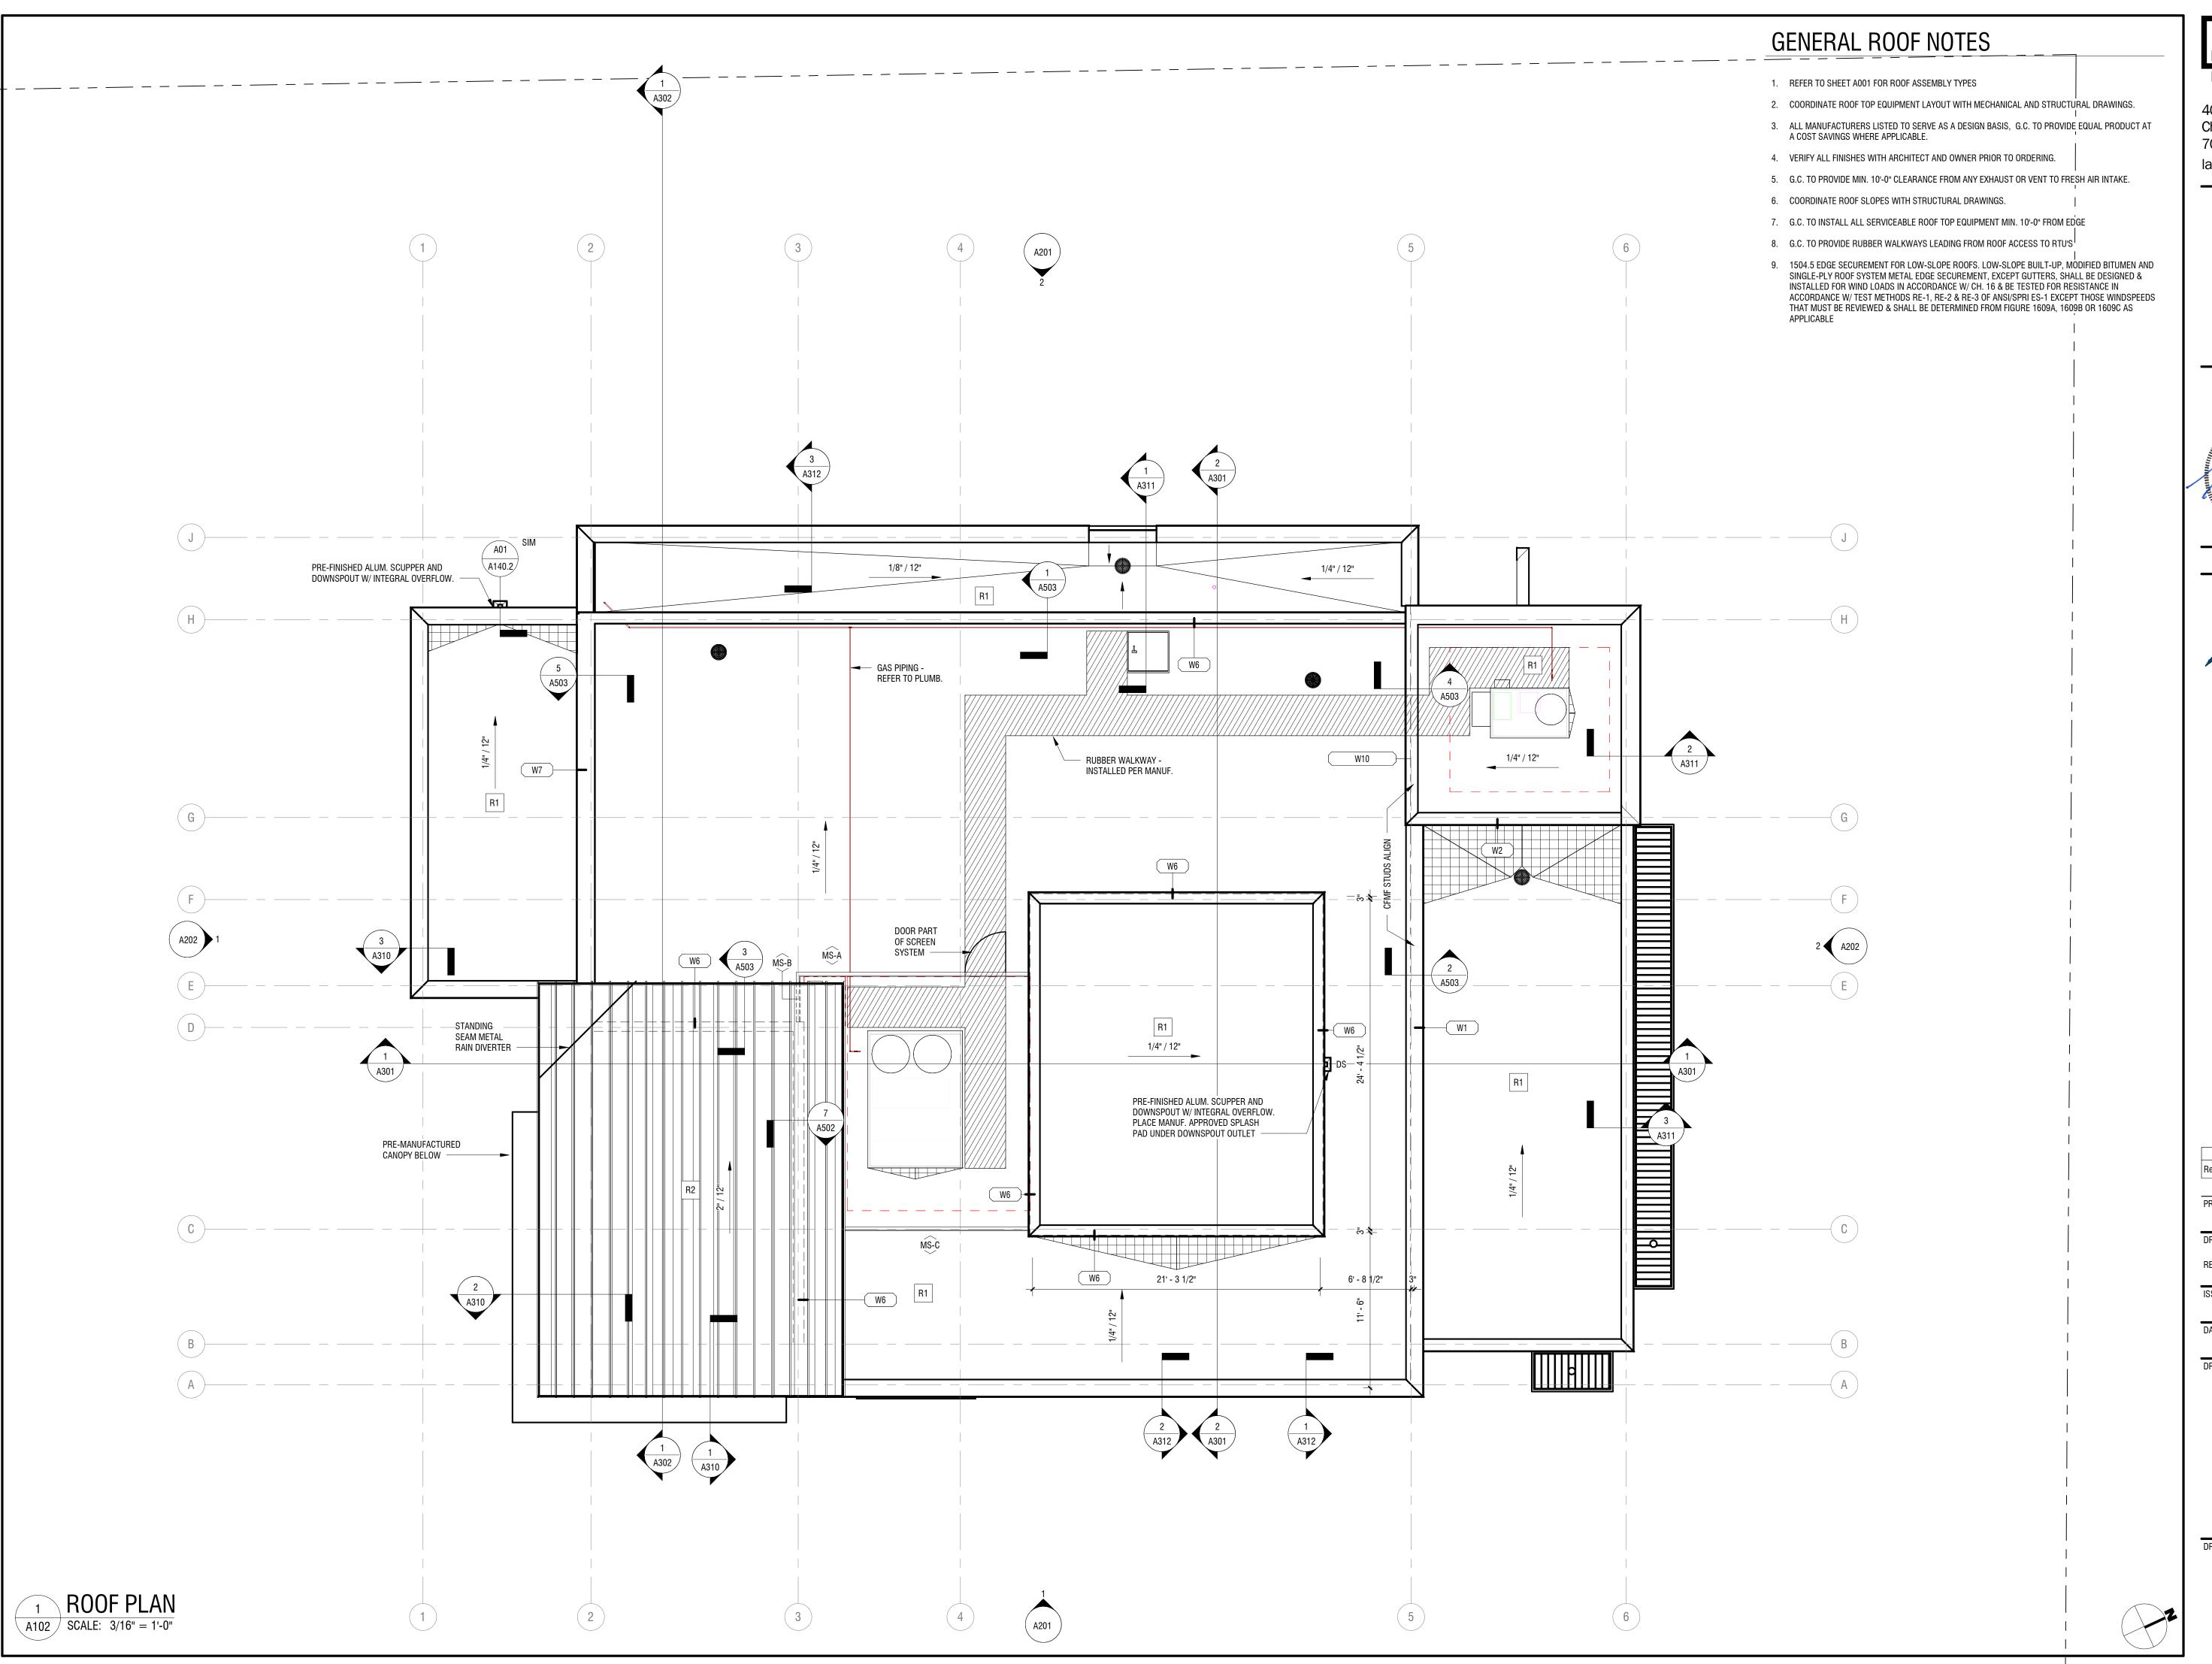


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FIRST FLOOR PLAN

DRAWING NUMBER:







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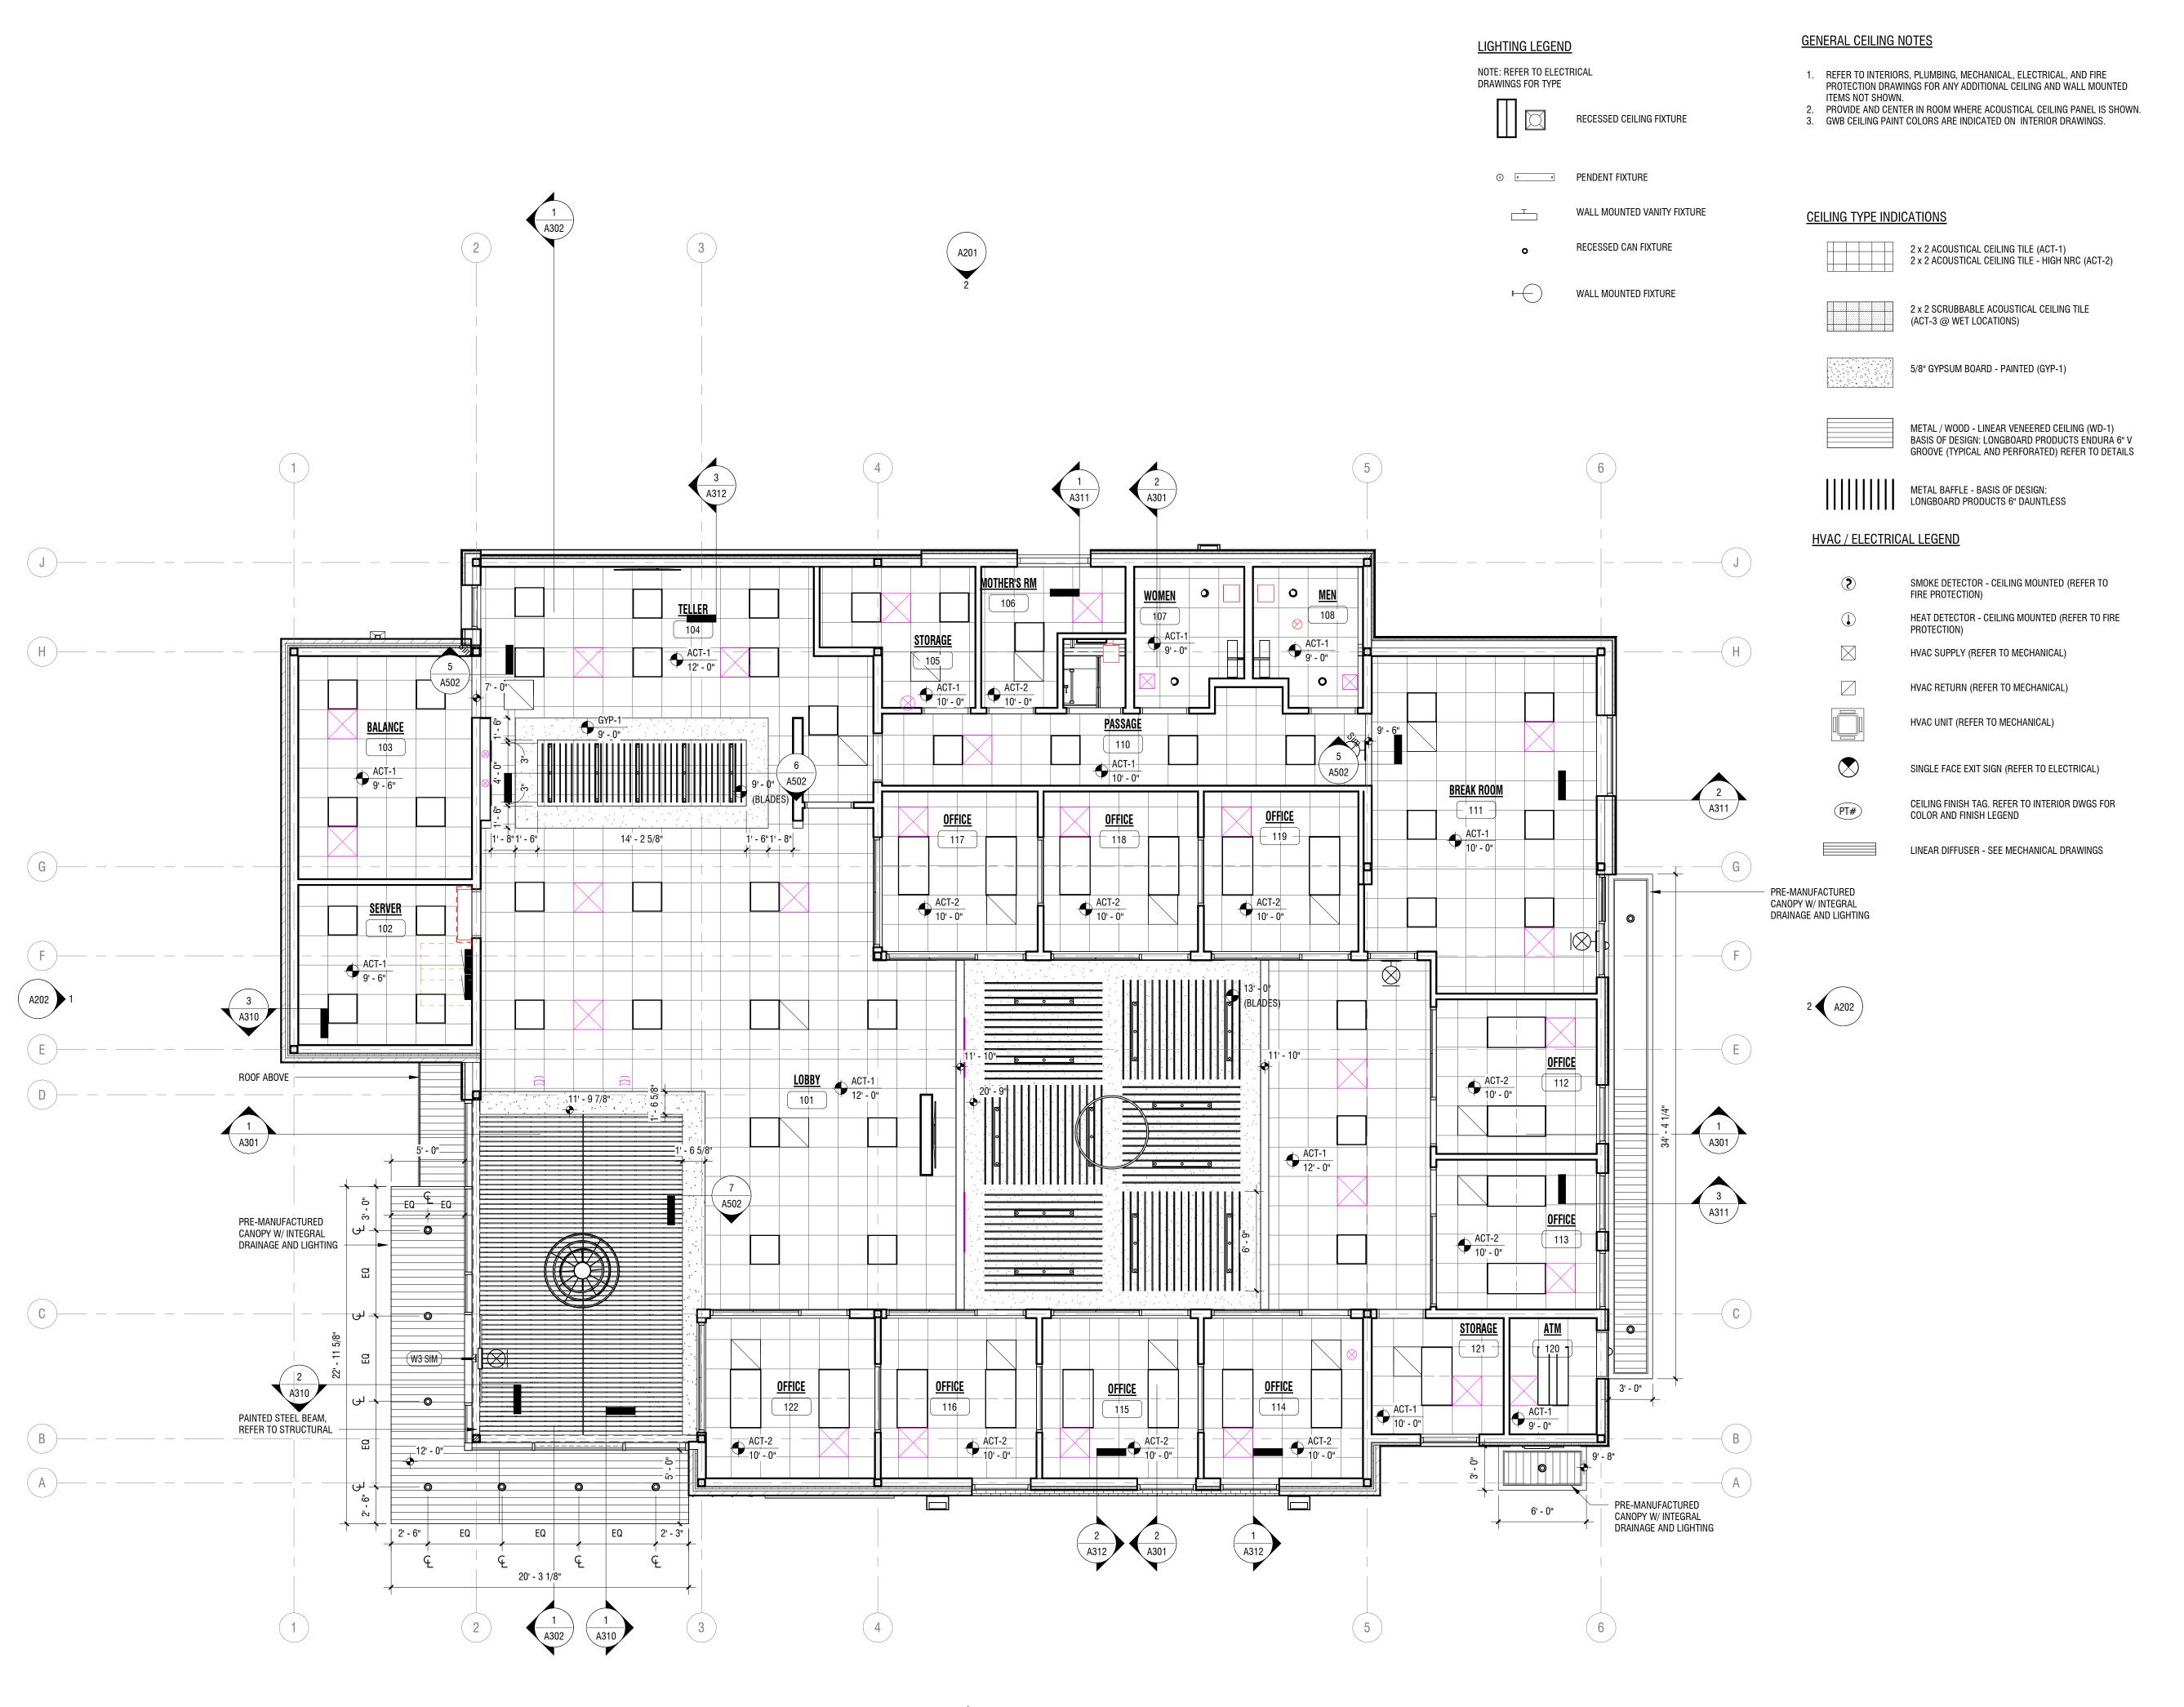


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ROOF PLAN

DRAWING NUMBER:







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FIRST FLOOR REFLECTED
CEILING PLAN

DRAWING NUMBER:





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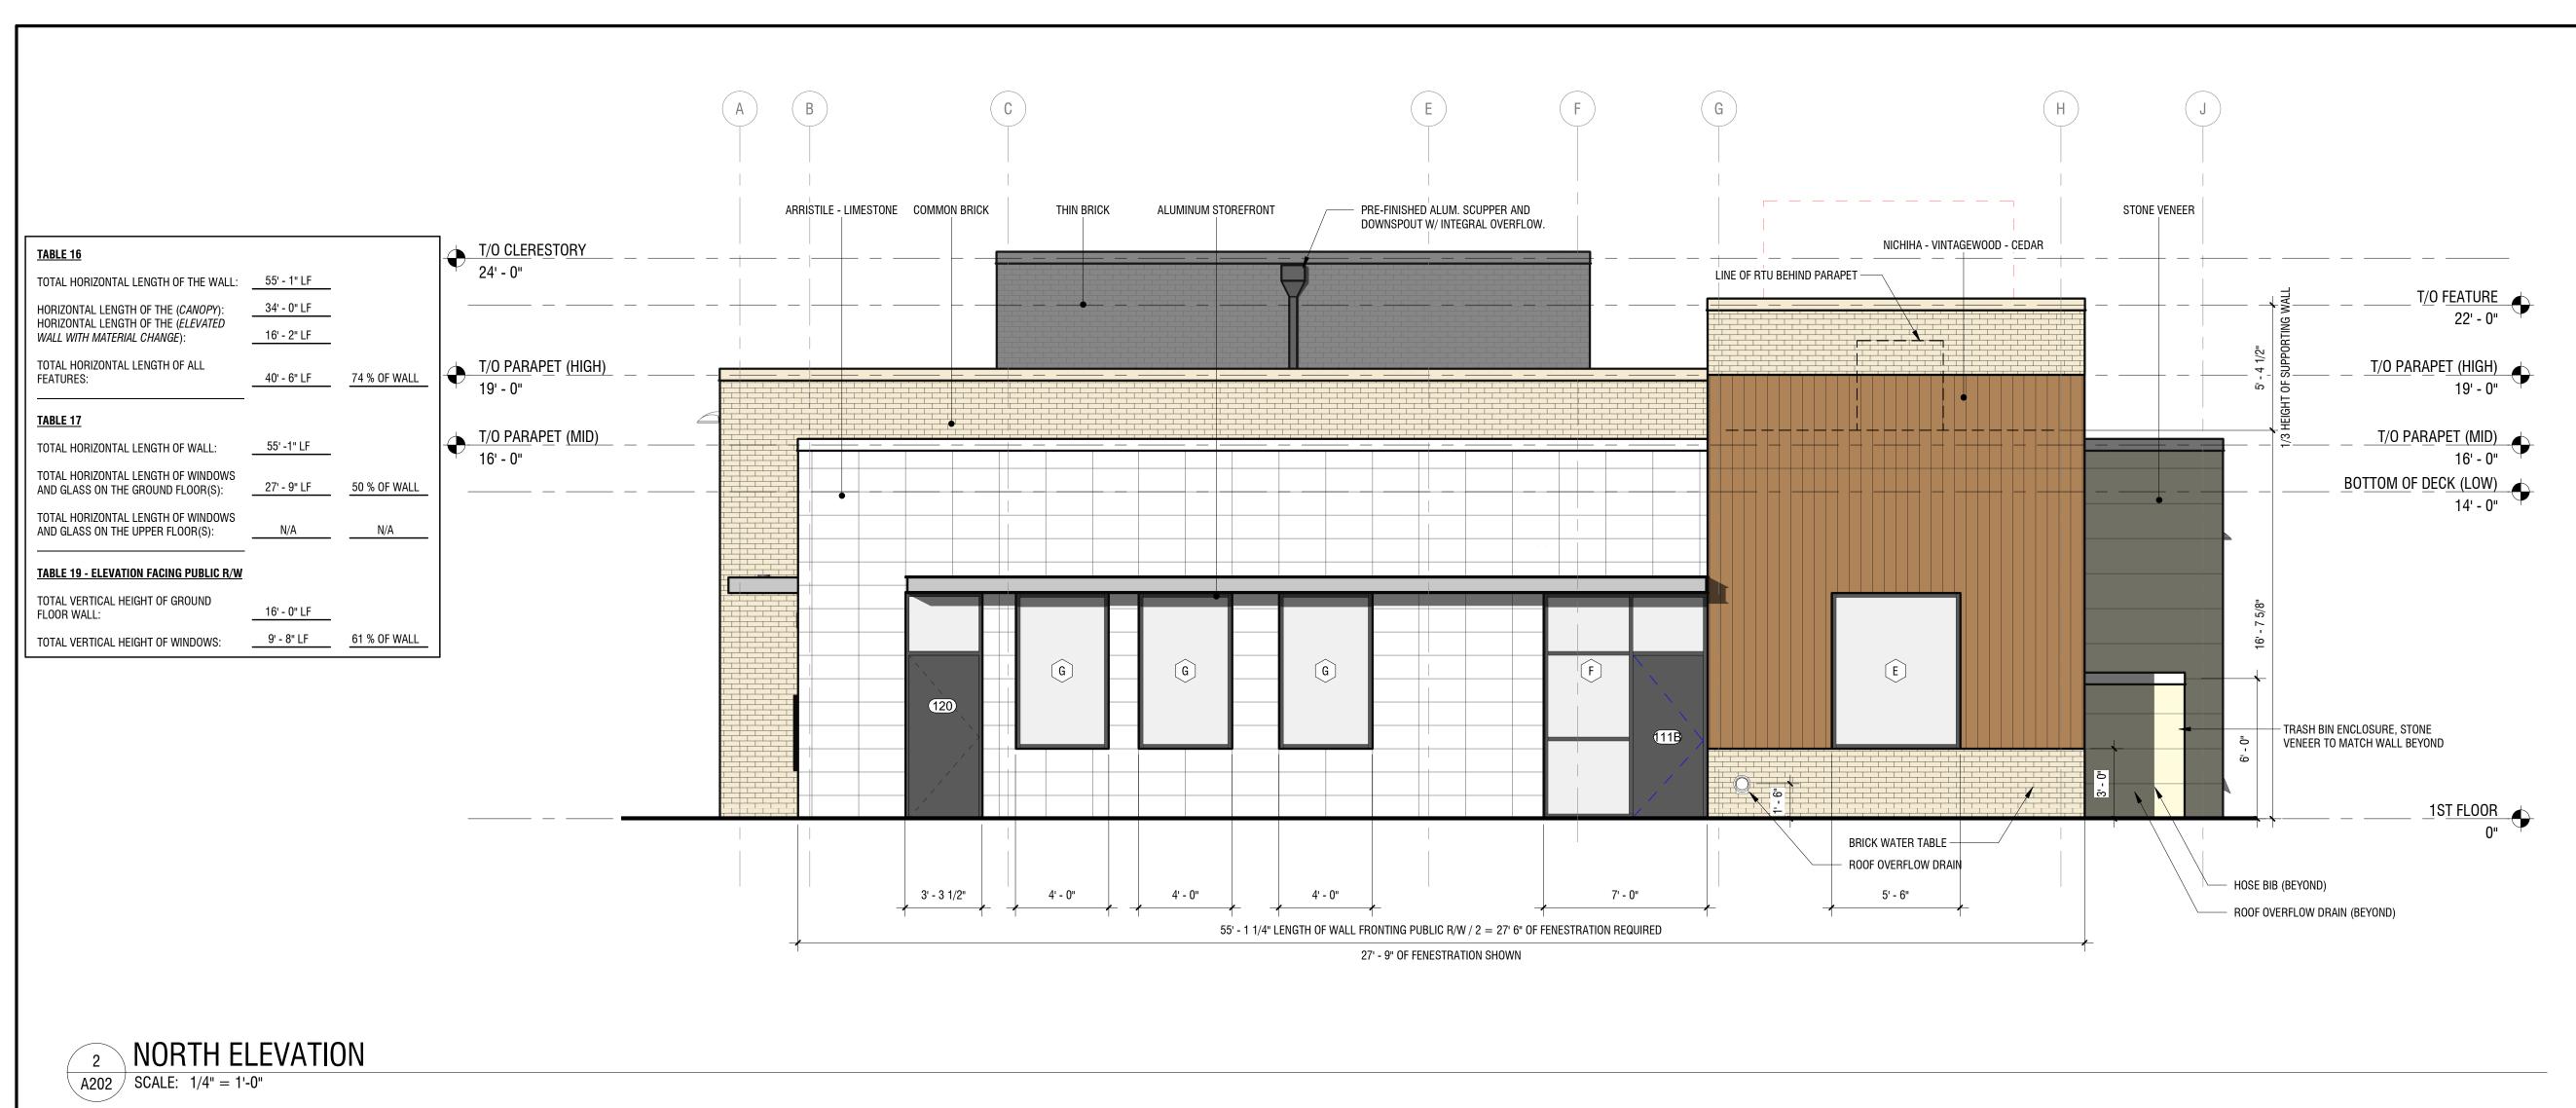
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С	06.26.2024	Cycle 4 - Site Review
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OJECT	NUMBER:	2230150
AWN BY:		BAW
VIEWED BY:		GGA
SUED FOR:		BID SET
TE:		08.23.2024
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EXTERIOR ELEVATIONS





- GROUND FLOOR WINDOWS COMPLY WITH DIRECT VIEWS TO THE BUILDING'S INTERIOR.
- DIRECT VIEWS TO THE BUILDINGS INTER
- 2. FASCIA SIGNS REQUIRE SEPARATE APPROVAL.
- 3. ANY SIGNS PROPOSED ARE FOR ILLUSTRATIVE PURPOSES ONLY.
- 4. PRIOR TO THE ISSUANCE OF ANY CERTIFICATE OF OCCUPANCY, A CERTIFICATION FROM THE MANUFACTURER OF CORRECT INSTALLATION OF ALL EIFS SHALL BE PROVIDED TO THE TOWN PLANNING DEPARTMENT.





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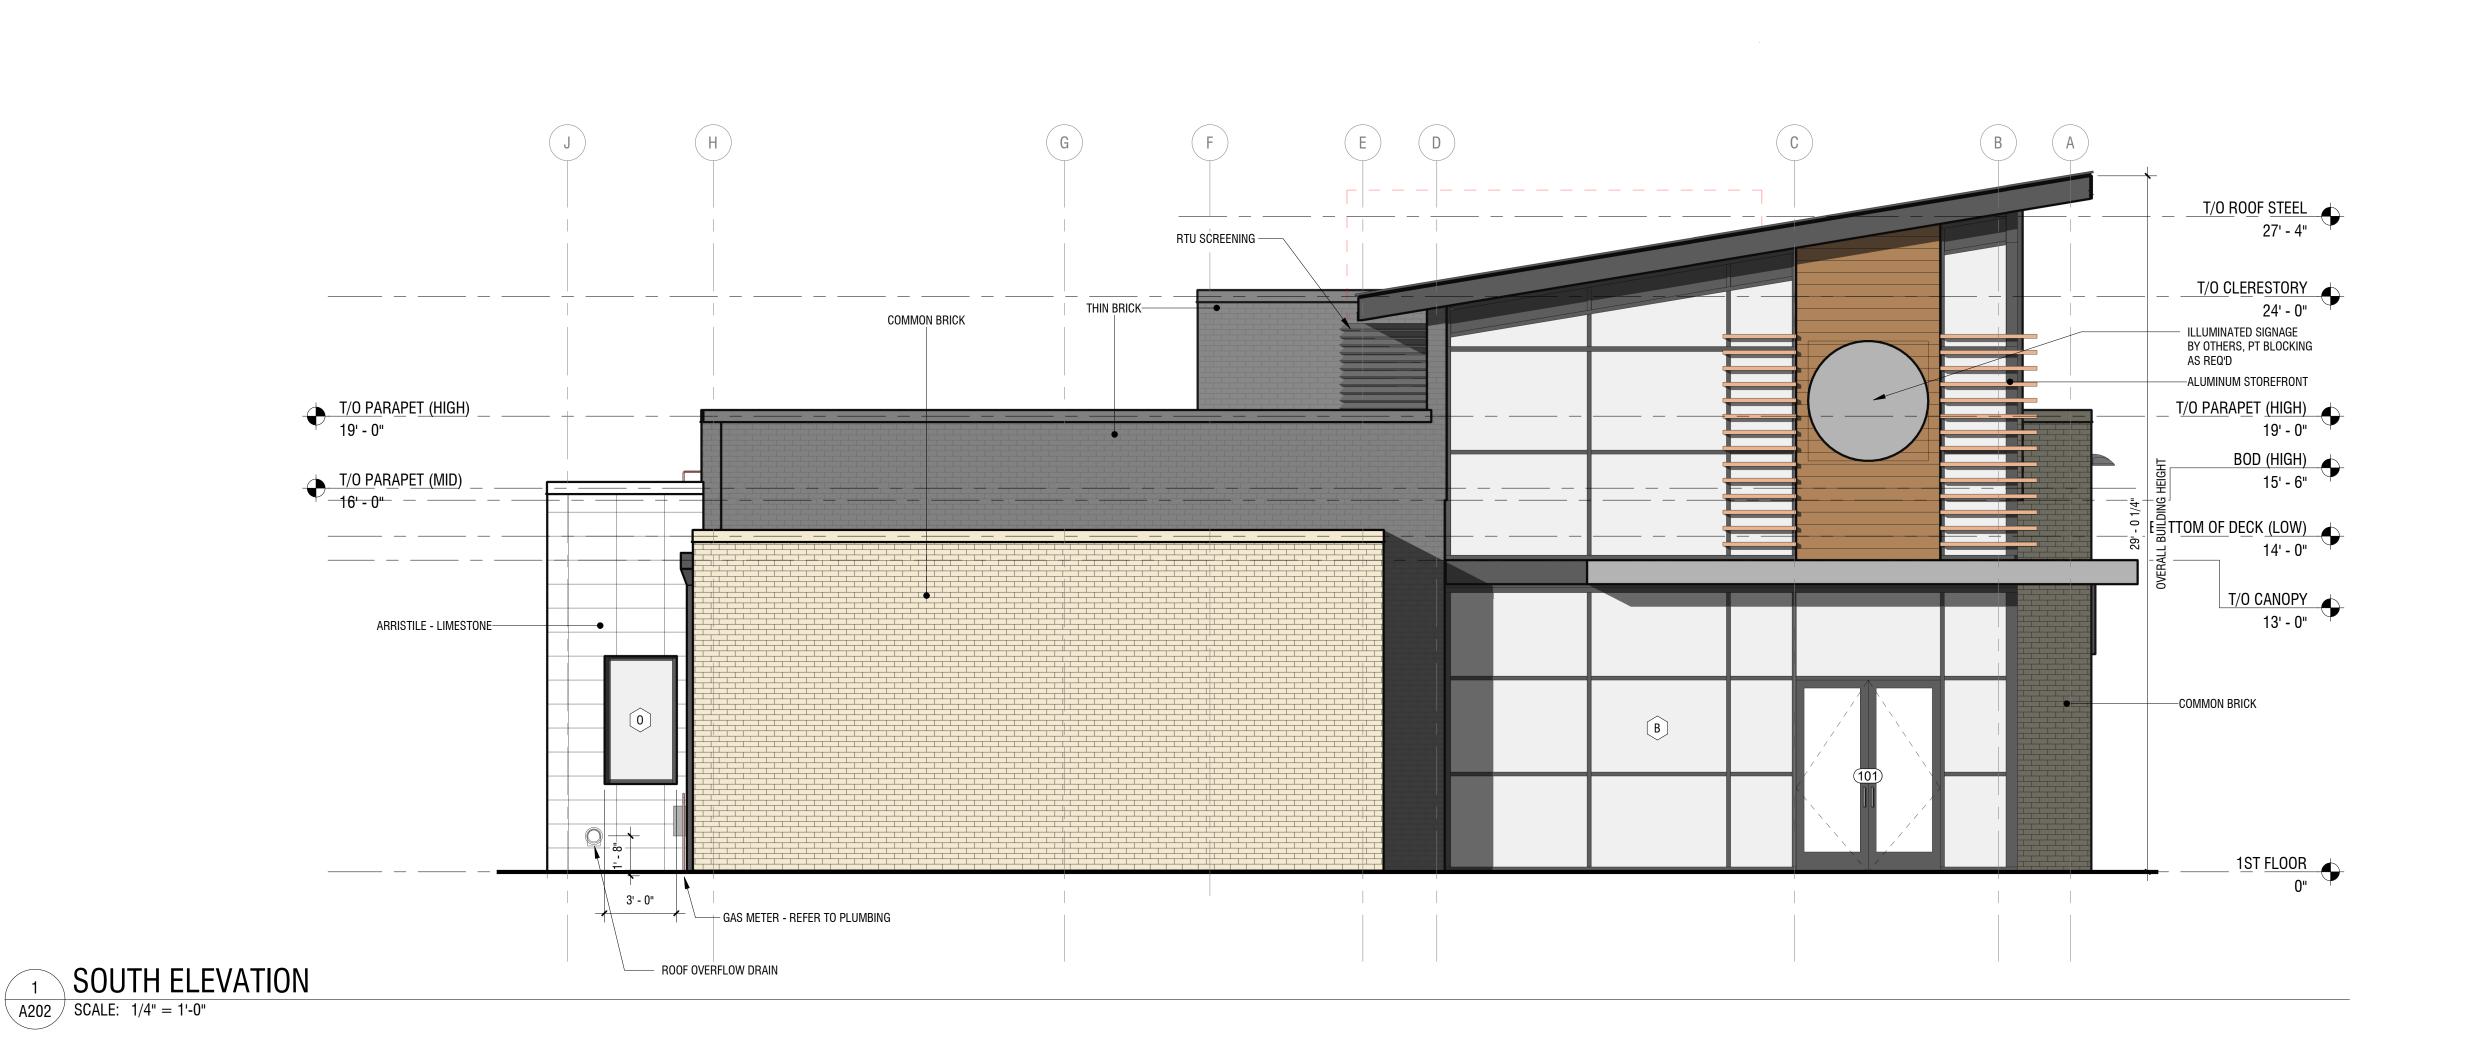



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С	06.26.2024	Cycle 4 - Site Review				
В	02.15.2024	Cycle 2 - Site Review				
NO:	DATE:	DESCRIPTION:				
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SUED FOR: BID SET						
ATE:		08.23.2024				
RAWING	RAWING NAME:					

EXTERIOR ELEVATIONS

DRAWING NUMBER:





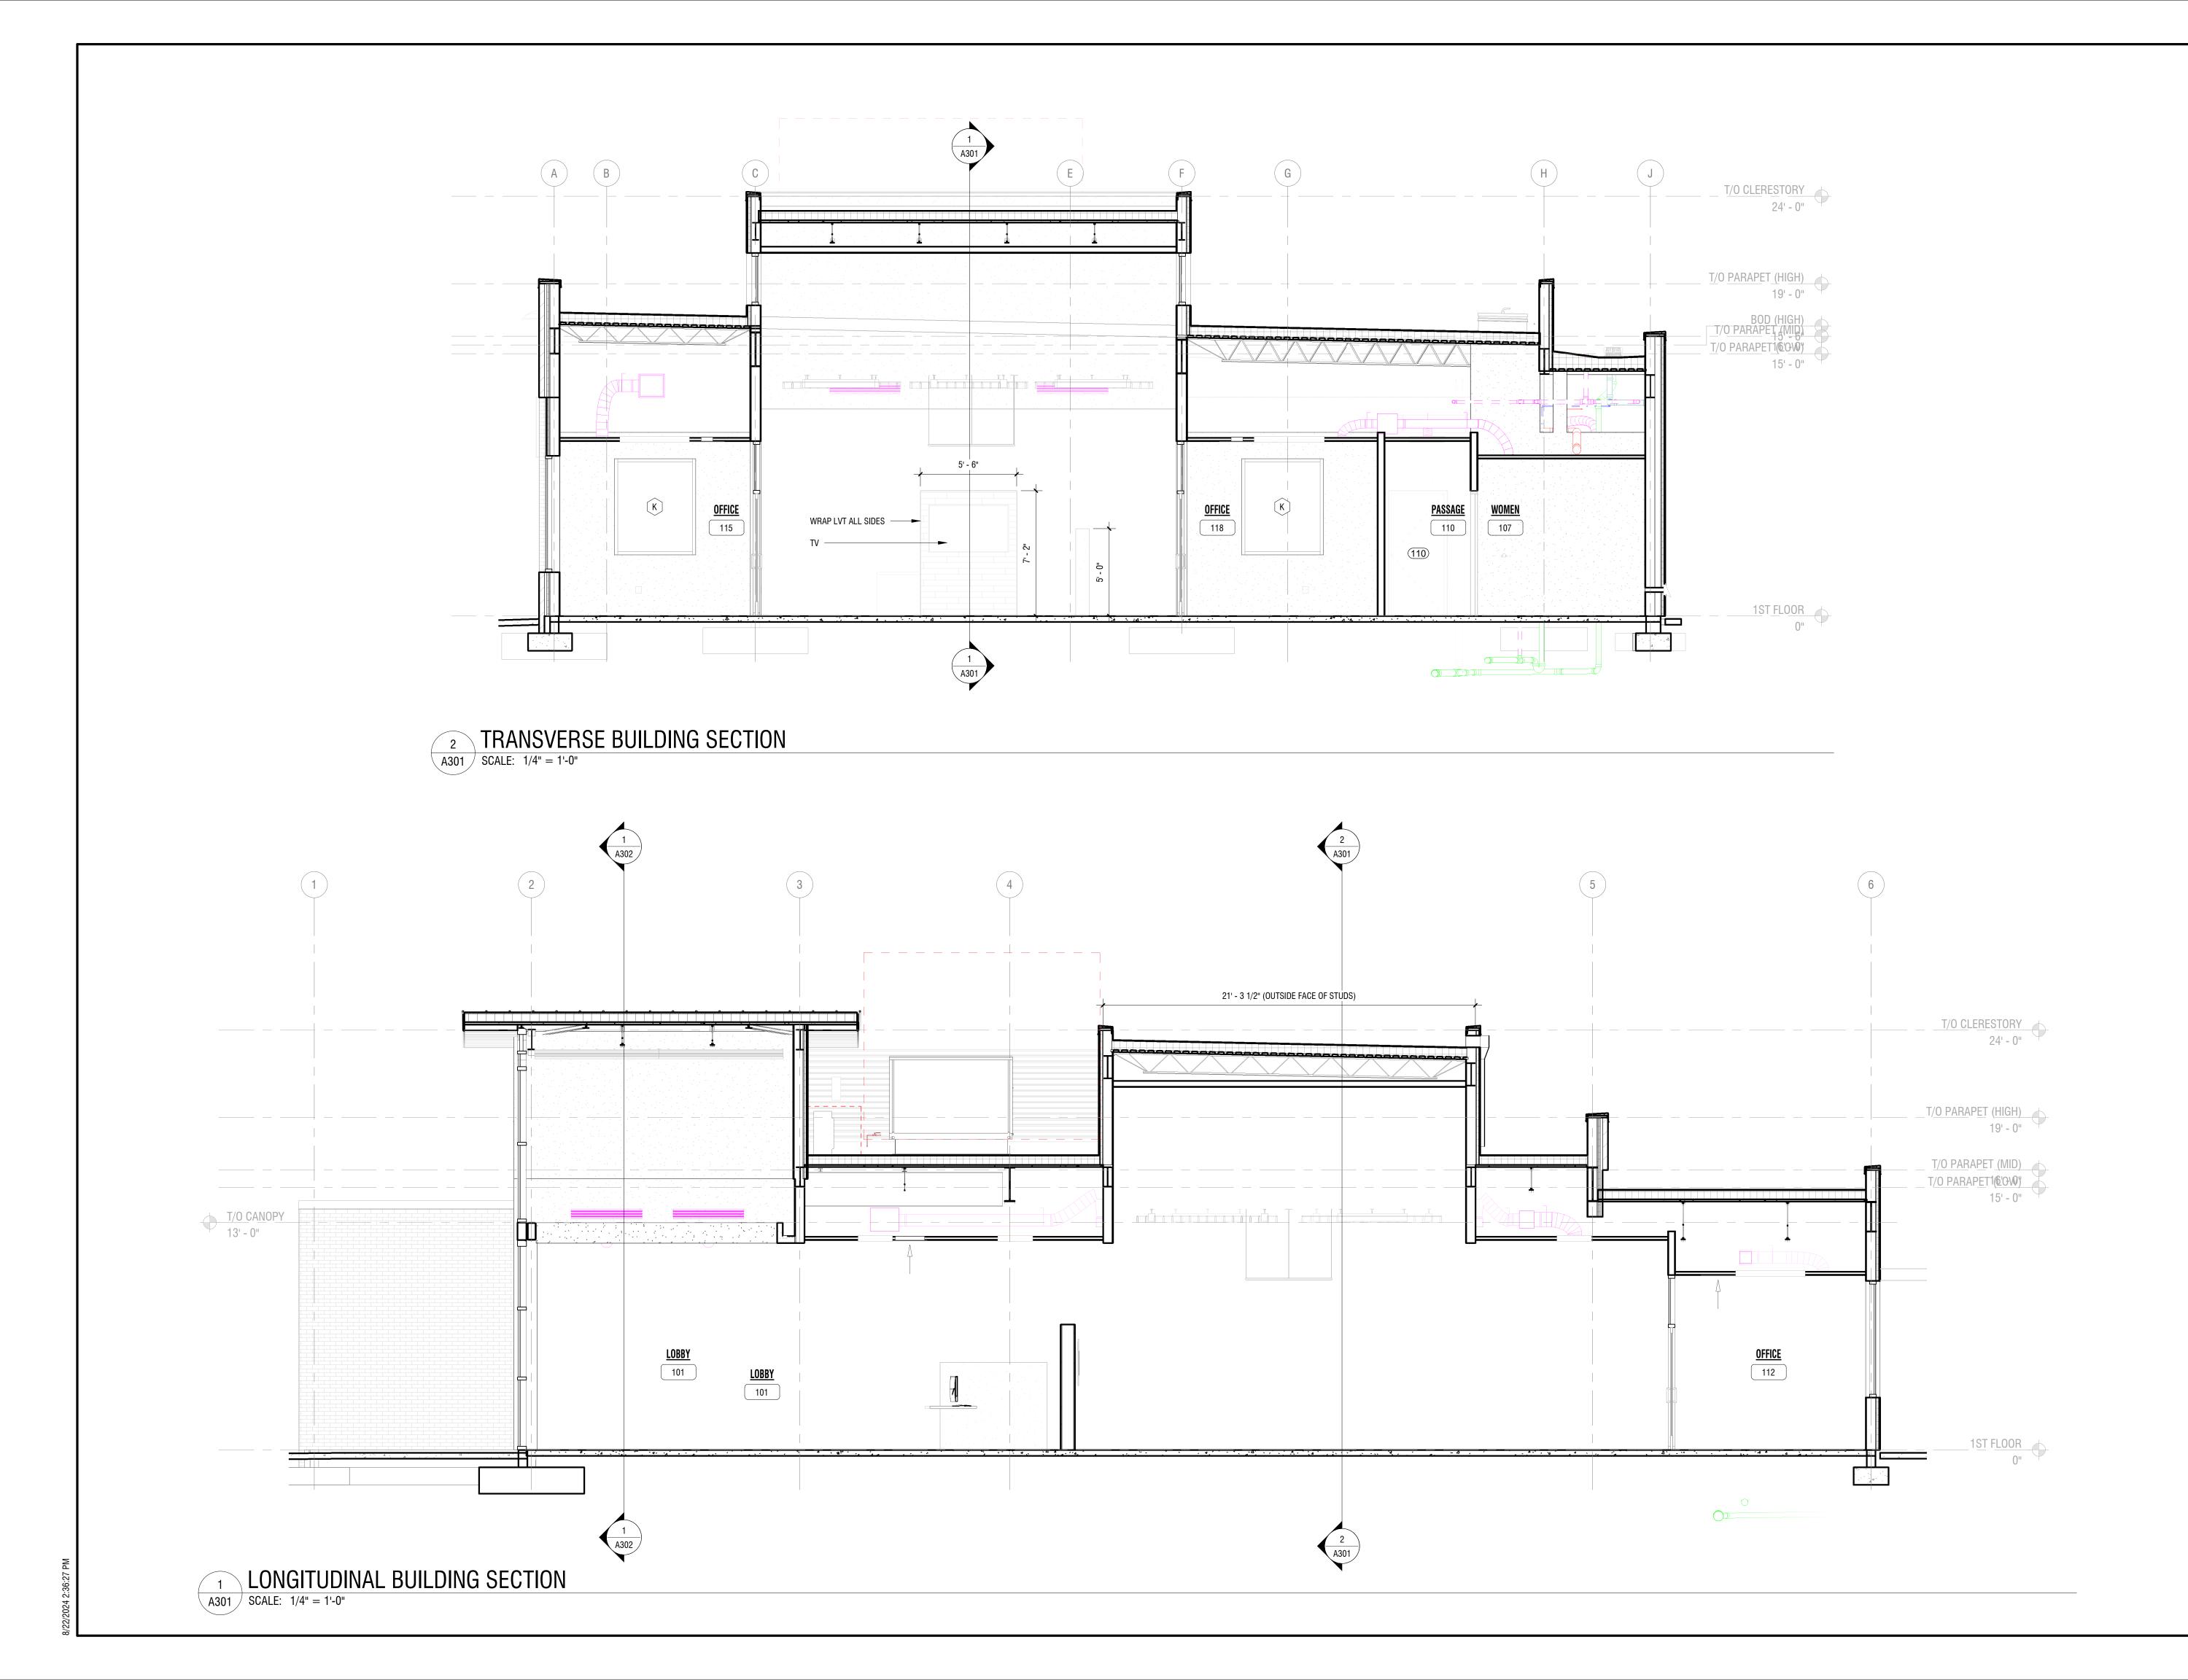



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DATE:		08.23.2024						

BUILDING SECTIONS

DRAWING NUMBER:

DRAWING NAME:





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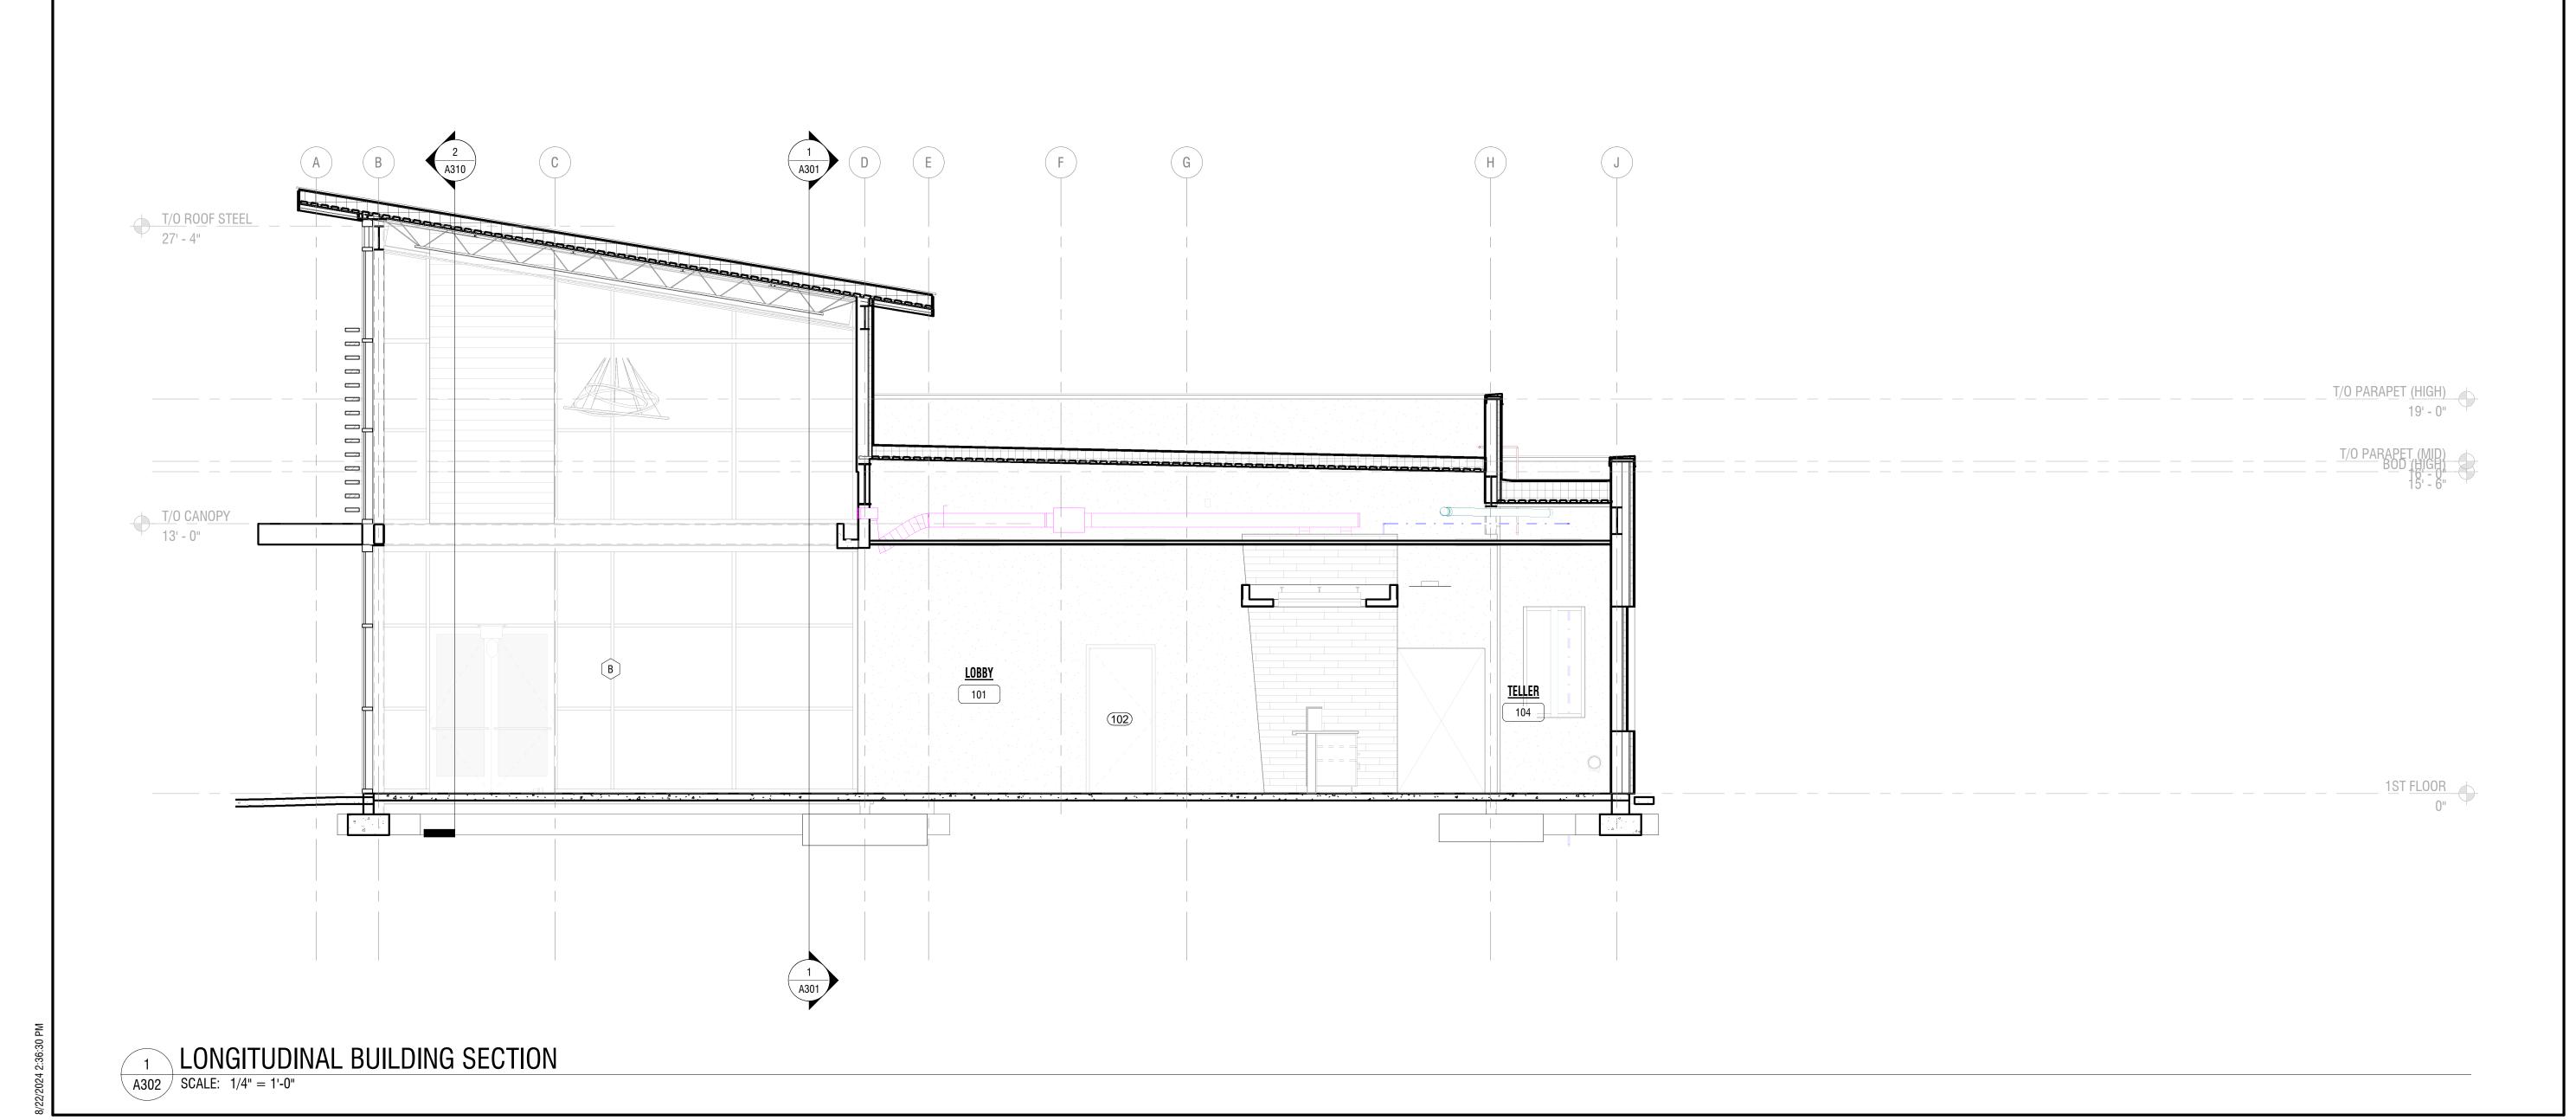



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BUILDING SECTIONS

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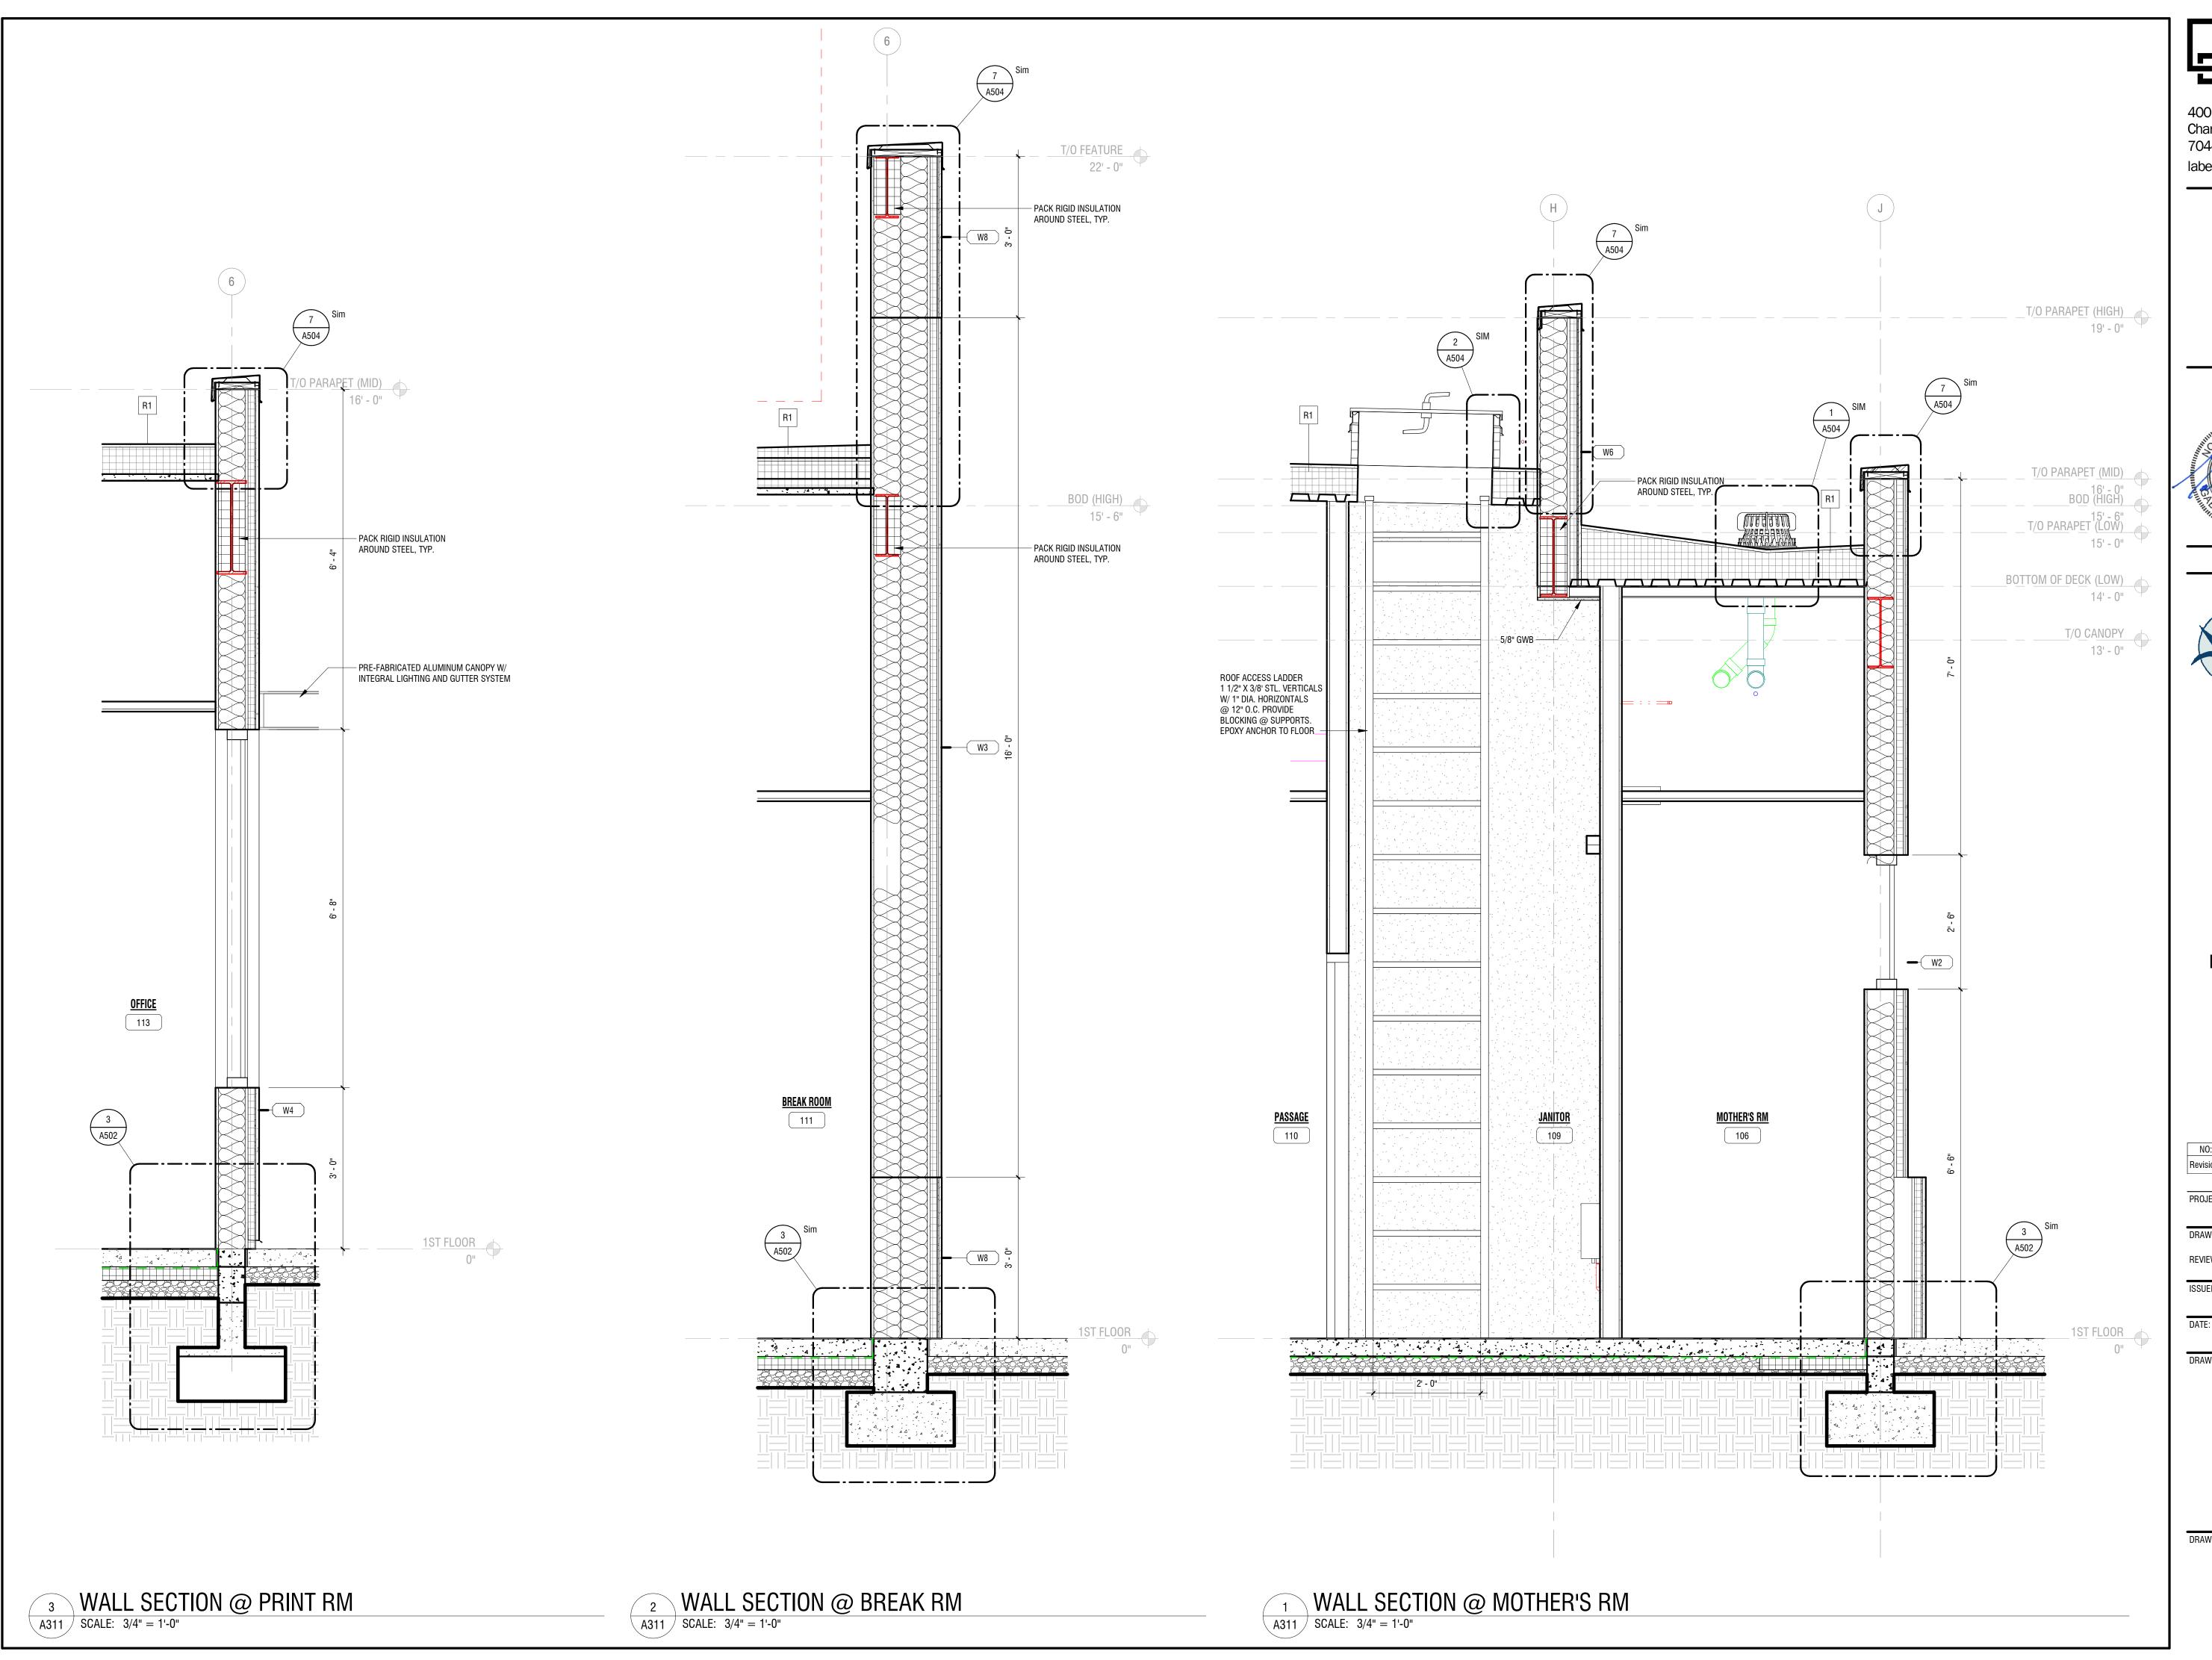


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		08.23.2024	
	NAME:		

WALL SECTIONS

DRAWING NUMBER:

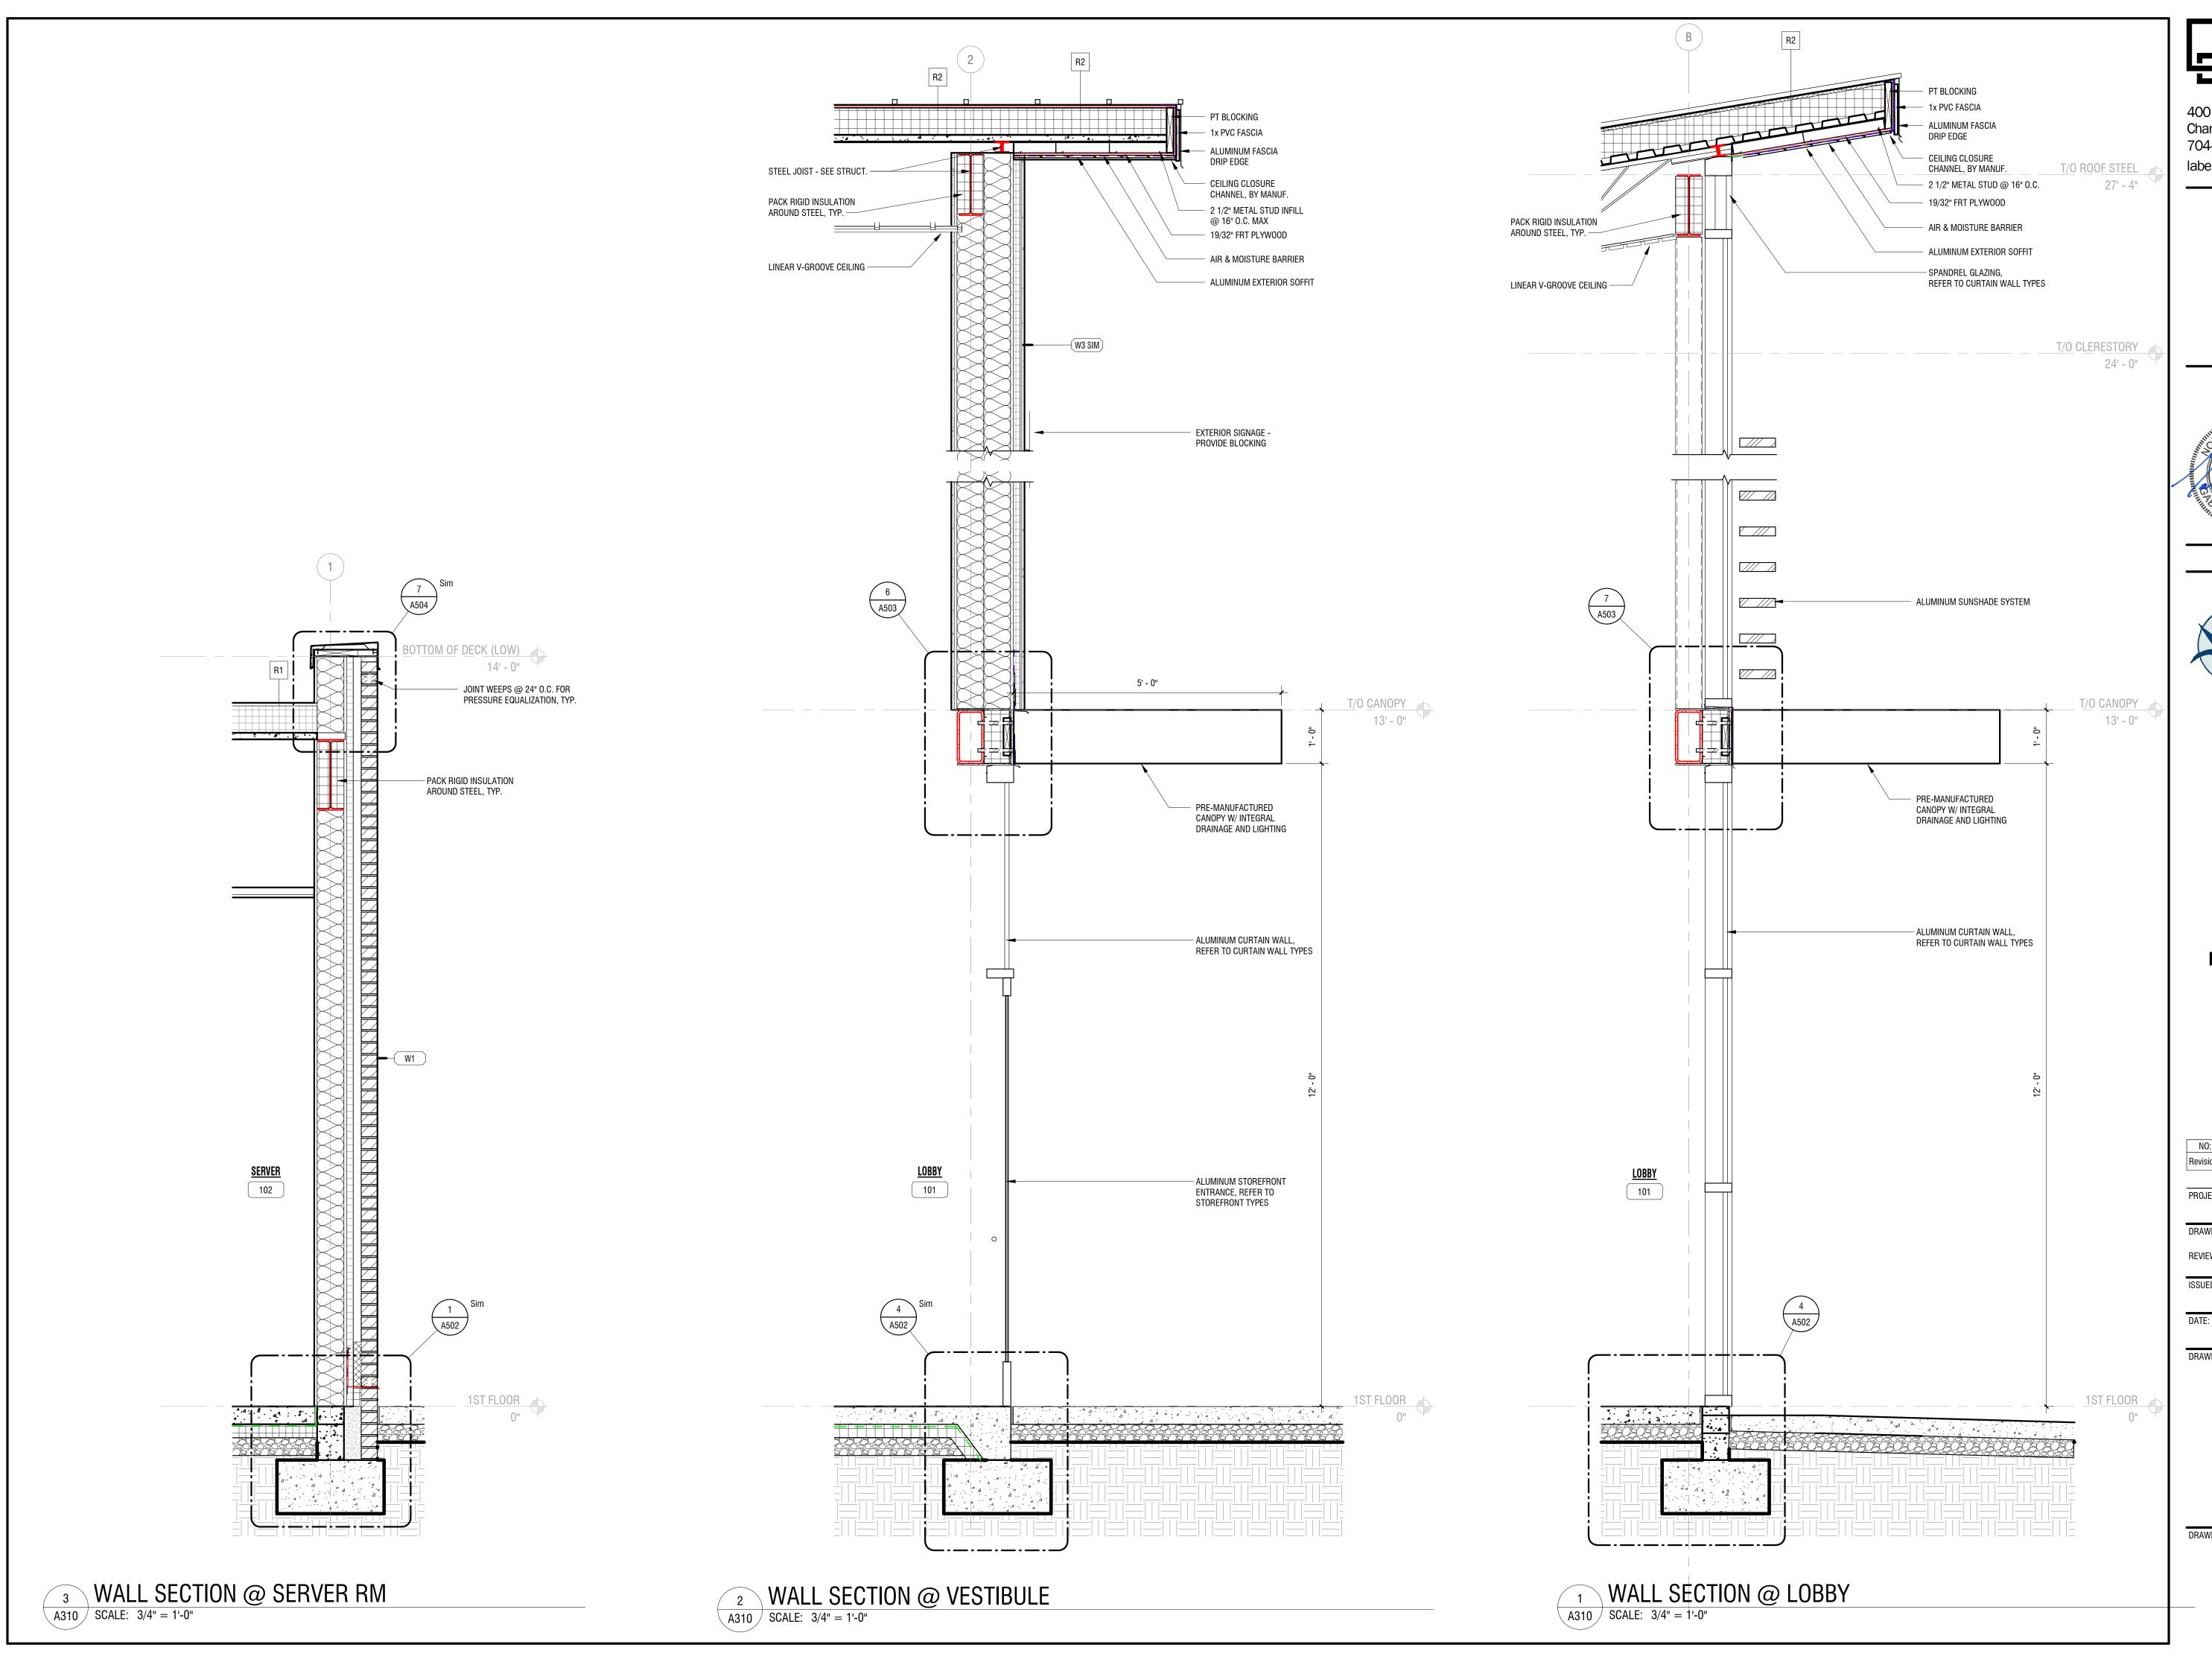





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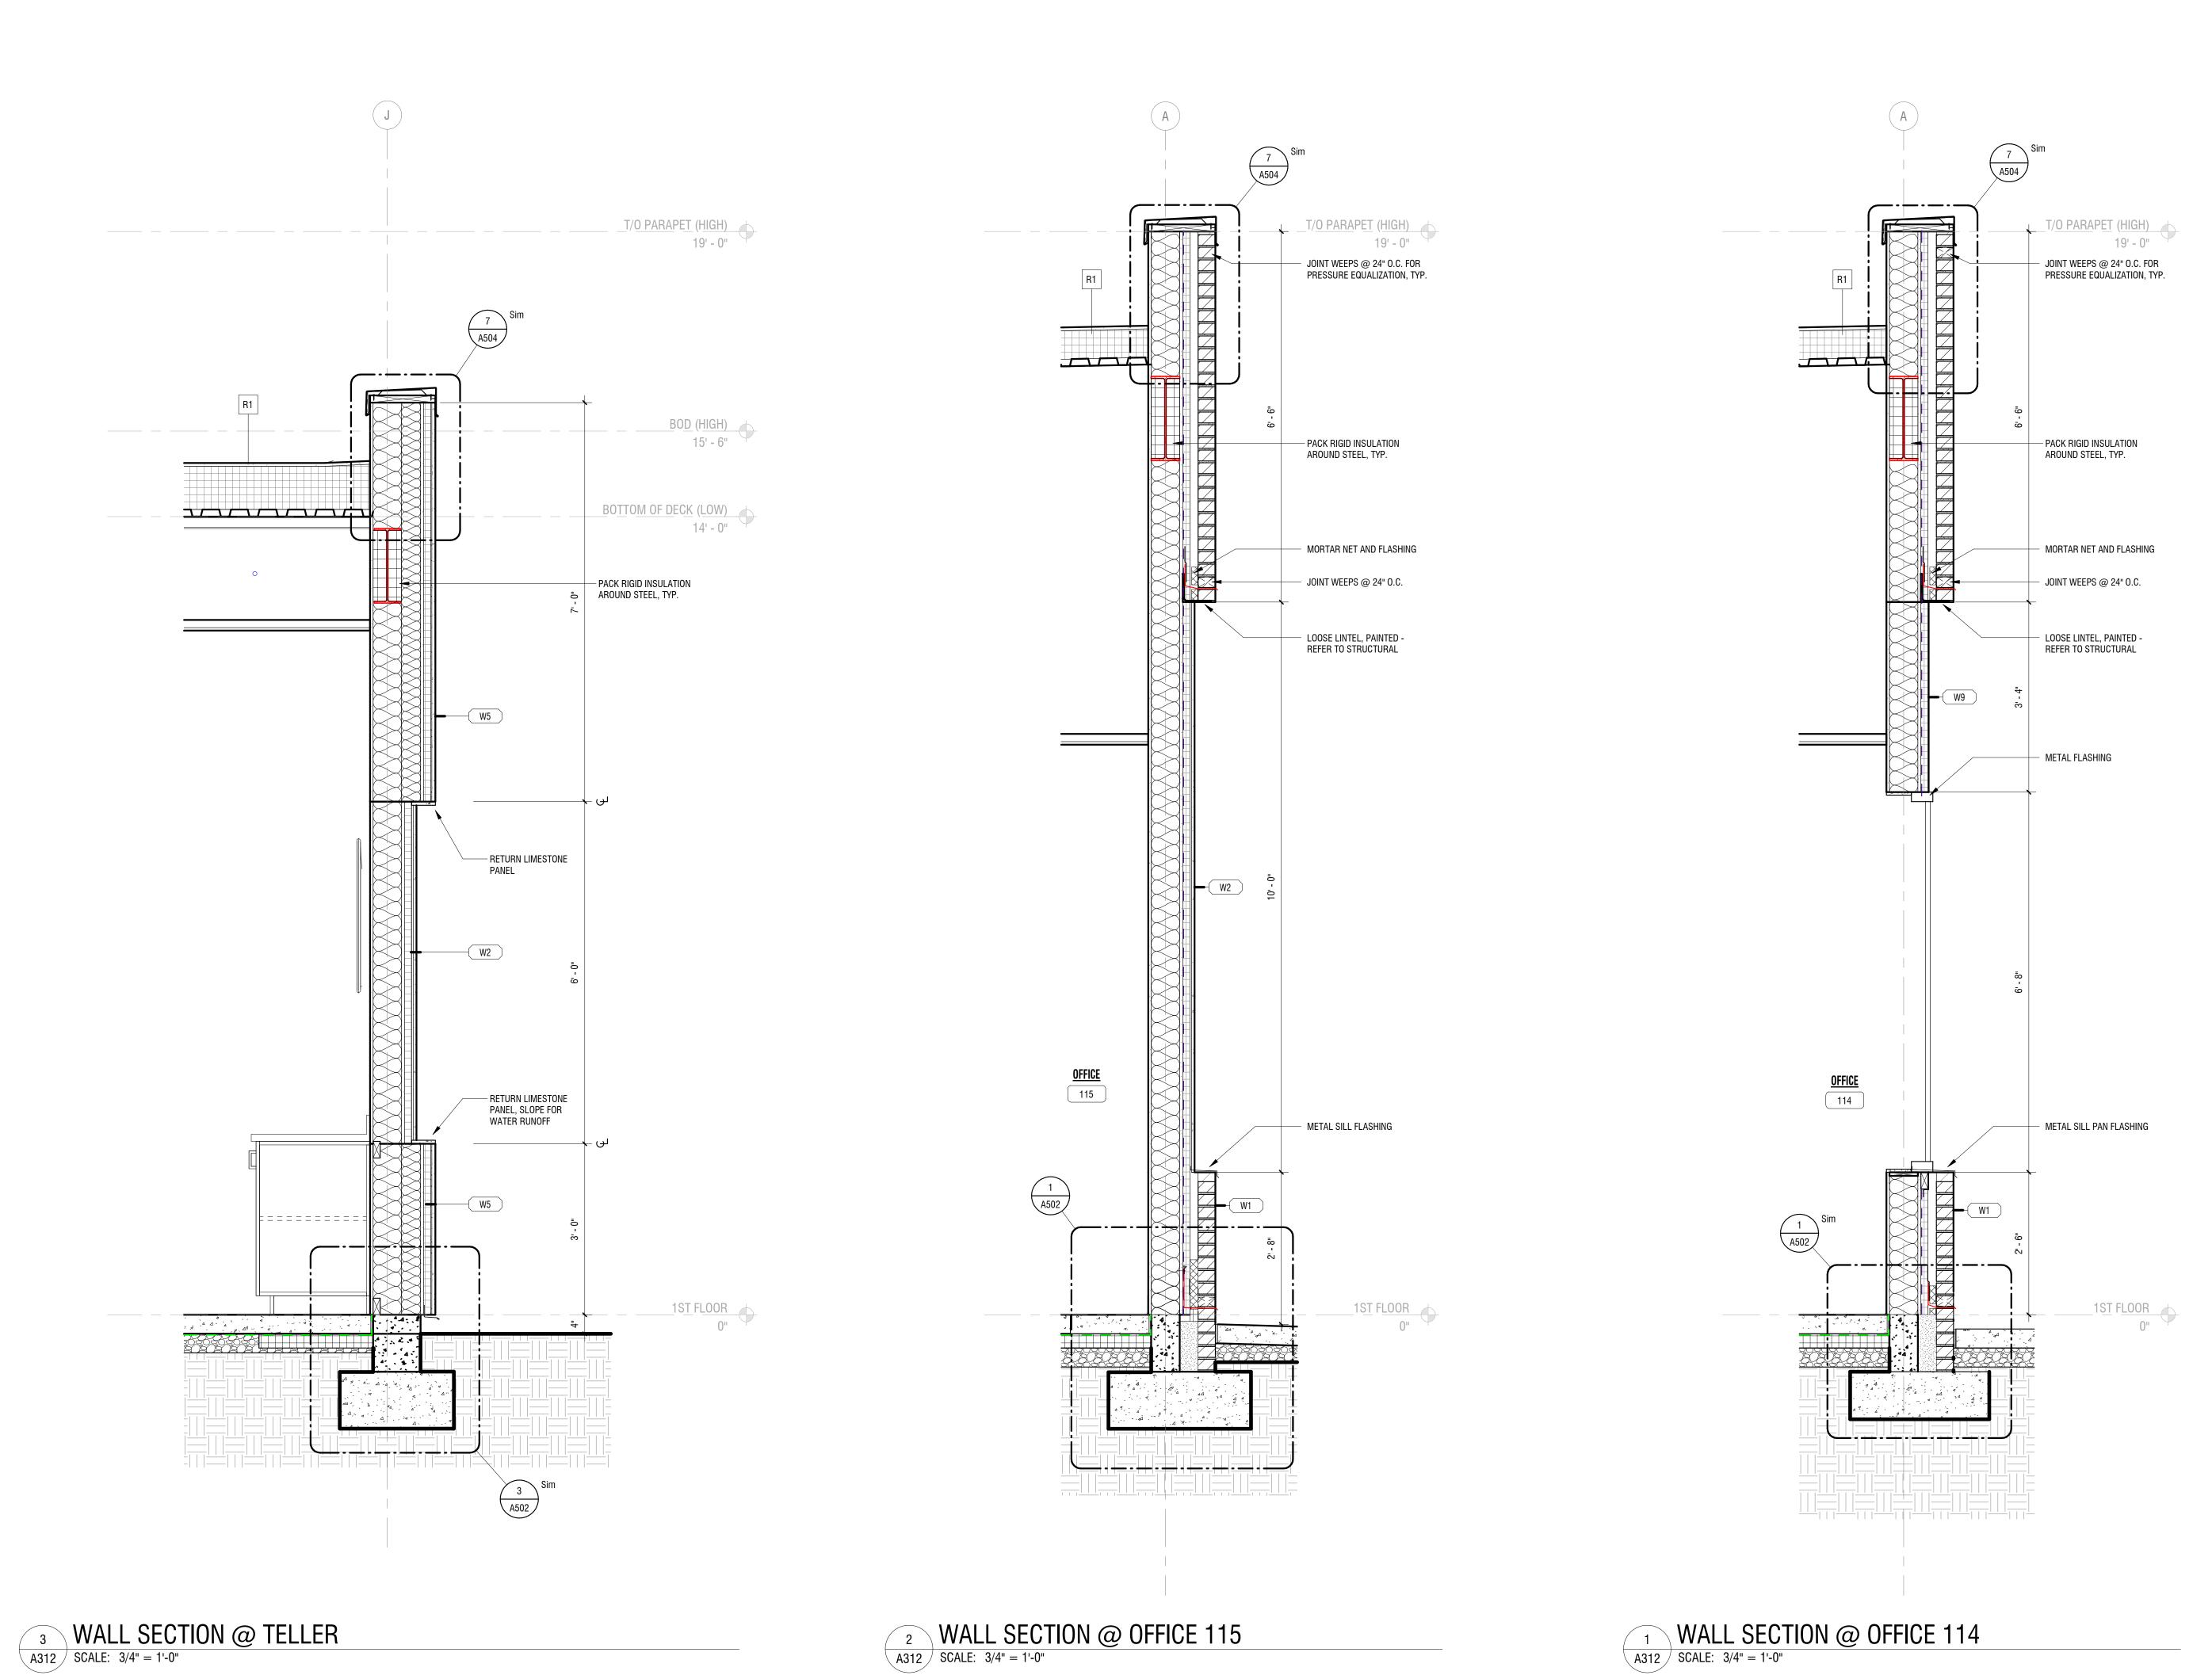


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DRAWING	NAME:		

WALL SECTIONS

DRAWING NUMBER:







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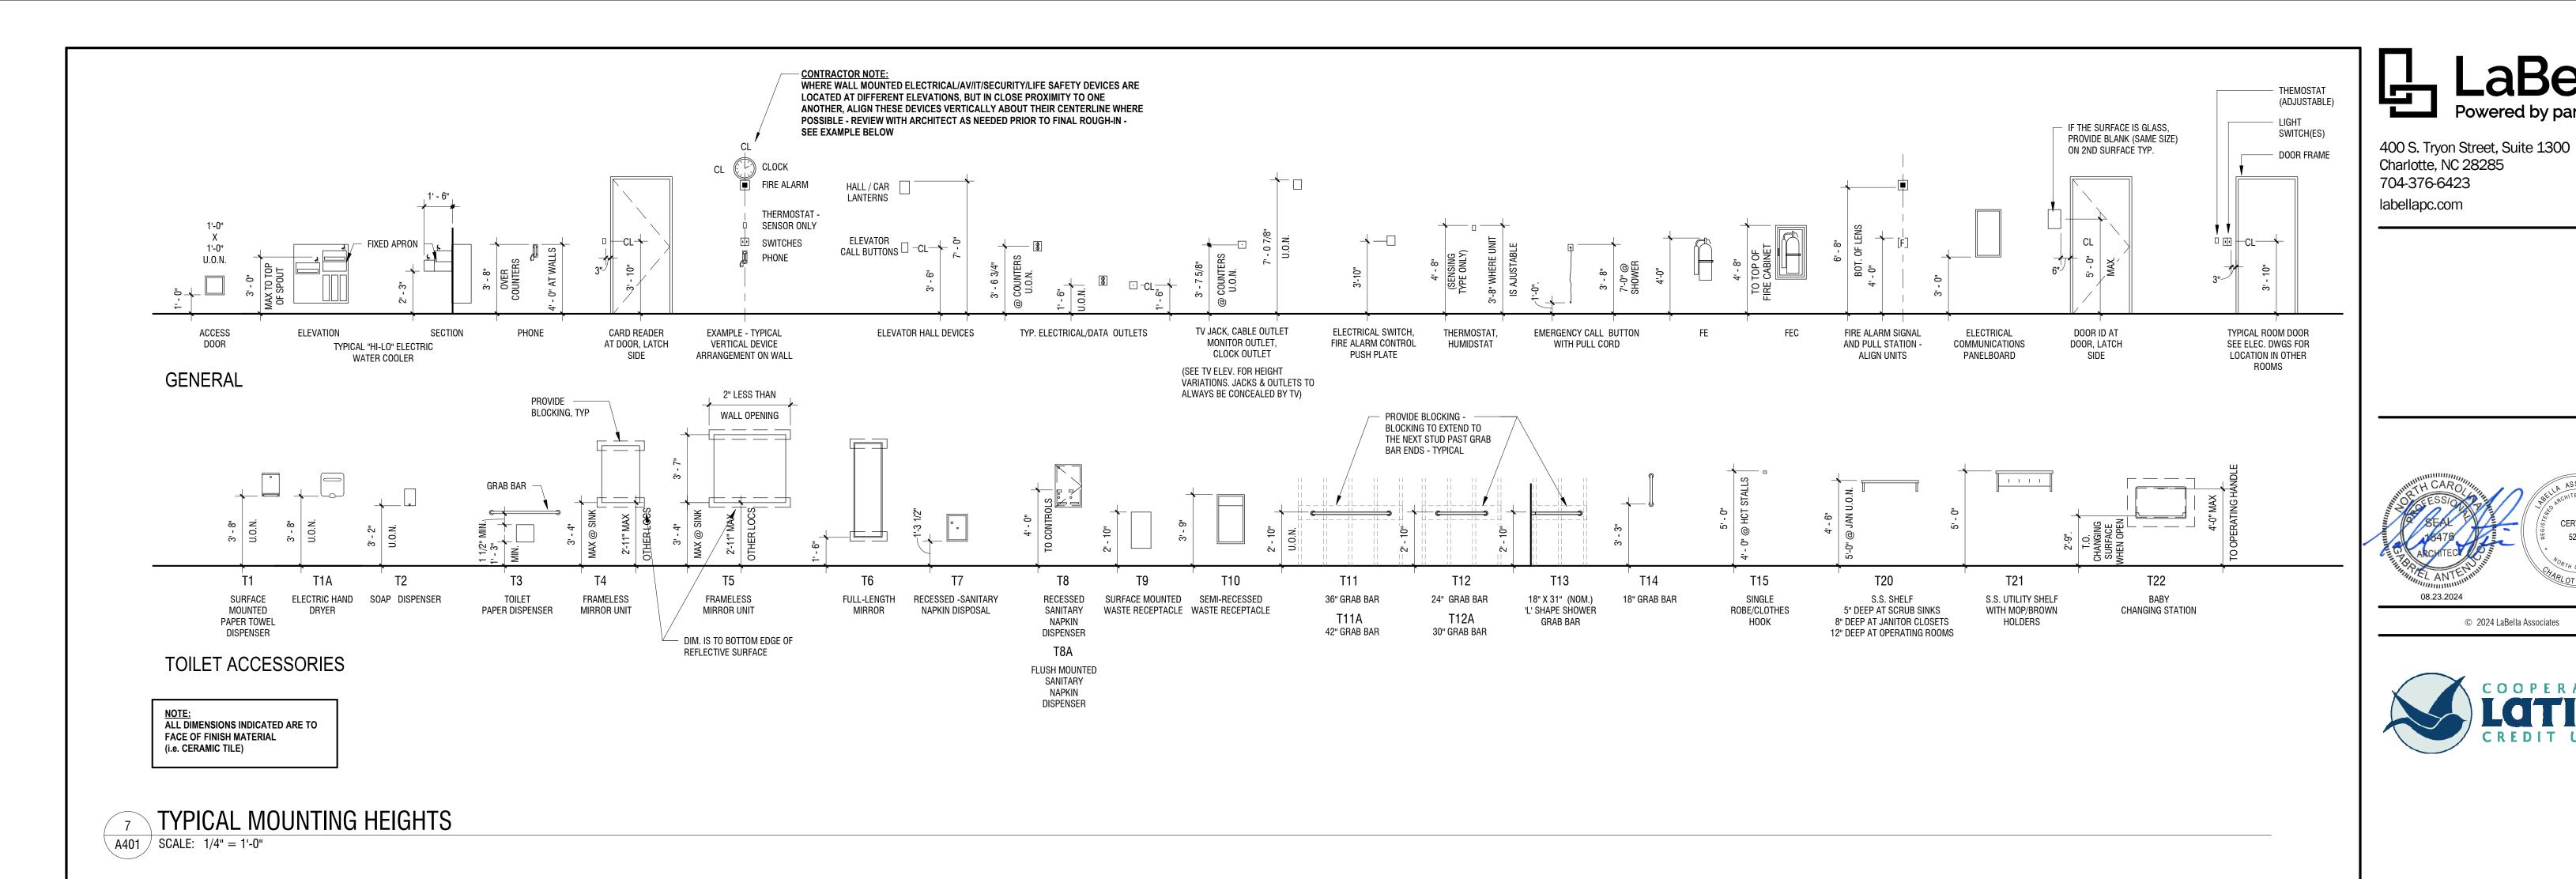



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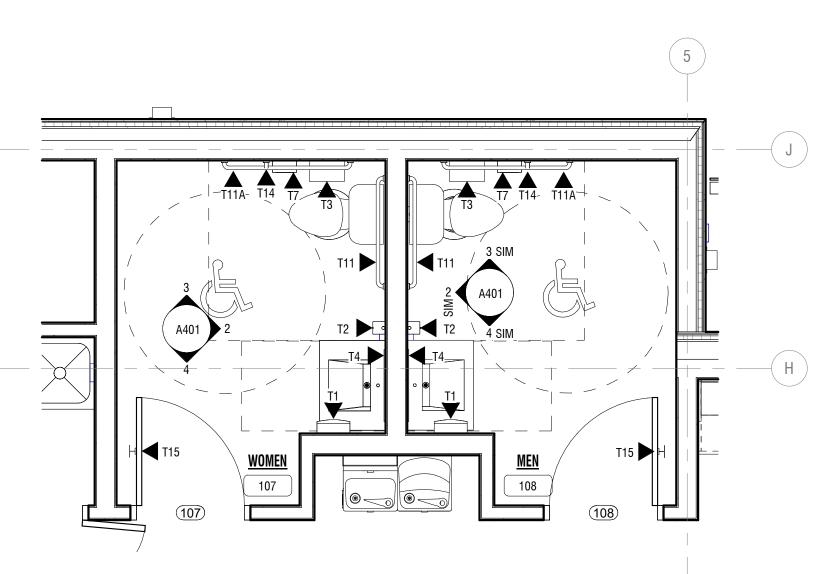
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		GGA					
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WALL SECTIONS

DRAWING NUMBER:





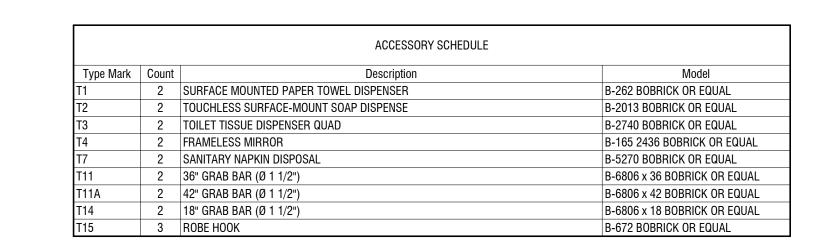

ENLARGED PLAN @ RESTROOMS


A401 SCALE: 3/8" = 1'-0"

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DRAWING	NAME:		

ENLARGED TOILET PLANS, ELEVATIONS AND TYPICAL MOUNTING HEIGHTS

DRAWING NUMBER:



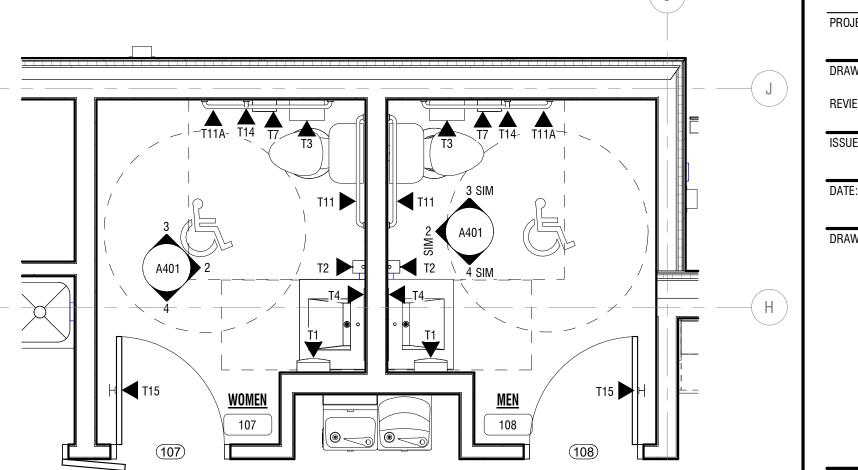

1/2" SOLID SURFACE COUNTERTOP

- BUILT- UP SOLID SURFACE EDGE,

3/4" PARTICLEBOARD SUBSTRATE W/

1/2" THICK SOLID SURFACE SIDE SPLASH,

1-1/4" BUILT- UP SOLID SURFACE COUNTERTOP WITH INTEGRAL SINK. COORD WITH PLUMBING CONTRACTOR

SHROUD WITH HPL ON ALL

EXPOSED SURFACES.

1x WOOD BLOCKING AS REQUIRED FOR FASTENING OF SHROUD

3/4" PARTICLE BOARD WITH HPL REMOVABLE ACCESS

HEAVY DUTY STEEL COUNTER

SUPPORT BRACKET, RE:

SPECIFICATION

COMPONANTS

EASED EDGES

A401

1/8" RADIUS EASED EDGE

LAPPED JOINERY

6 TYPICAL SSR COUNTERTOP EDGE DETAIL

1/2" SOLID SURFACE FIELD- APPLIED BACKSPLASH, EASED EDGES

CONTINUOUS SEALANT AS

COORDINATE WITH

PLUMBING CONTRACTOR

JUNCTURE OF BACK AND SIDE SPLASHES WITH COUNTERTOP

A401 SCALE: 3" = 1'-0"

6" MAX.

- 1/8" RADIUS EASED EDGE


WHITE LINER UNDERSIDE

CASEWORK DETAIL A401 SCALE: 1 1/2" = 1'-0"

1' - 4"

INTERIOR ELEVATION @ D00R A401 SCALE: 1/4" = 1'-0"

107

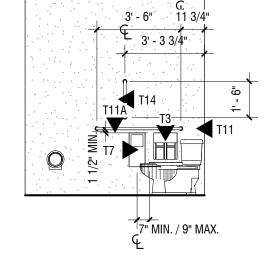

INTERIOR ELEVATION @ GRAB BAR A401 SCALE: 1/4" = 1'-0"

@ WATER CLOSET A401 SCALE: 1/4" = 1'-0"

INTERIOR ELEVATION

1. COORDINATE HEIGHT OF WATER CLOSET FLUSHOMETER

WITH MOUNTING HEIGHT OF REAR GRAB BAR TO PROVIDE


REMOVAL OF GRAB BAR.

1' - 0"- 2' - 0"

CLEARANCE FOR SERVING OF VALVES WITHOUT REQUIRING

2. FLUSH LEVER TO BE ON OPEN FLOOR SIDE TOWARDS SINK.

ALL MILLWORK BY OWNER INCLUDING BREAKROOM AND BATHROOM

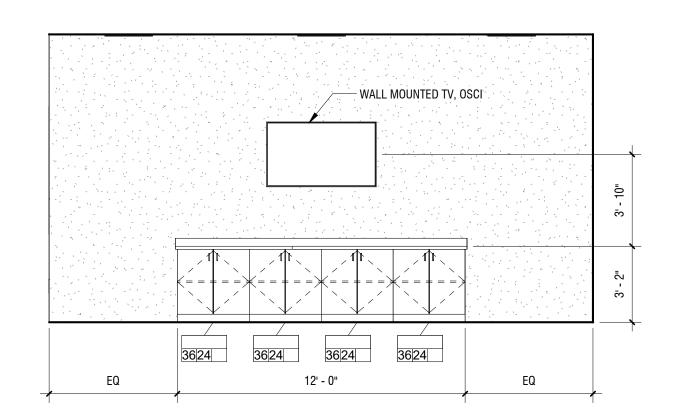





3612 3612 1212

1 | 24 | 36 | 24 | 36 | 24 | 12 | 24 |


5 BREAKROOM
SCALE: 1/4" = 1'-0"

INTERIOR ELEVATION

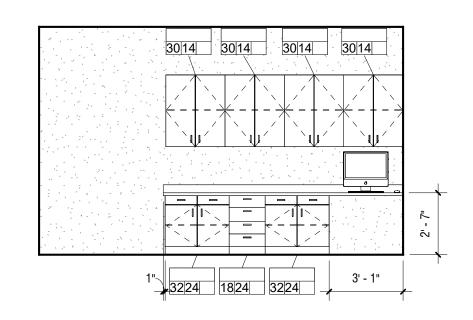


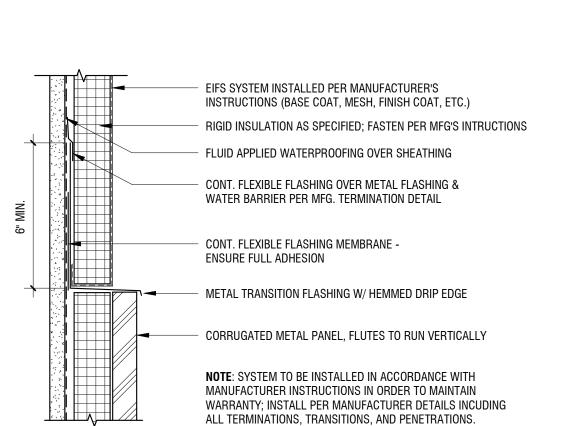




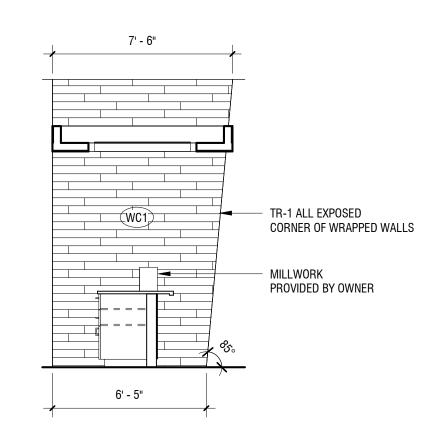



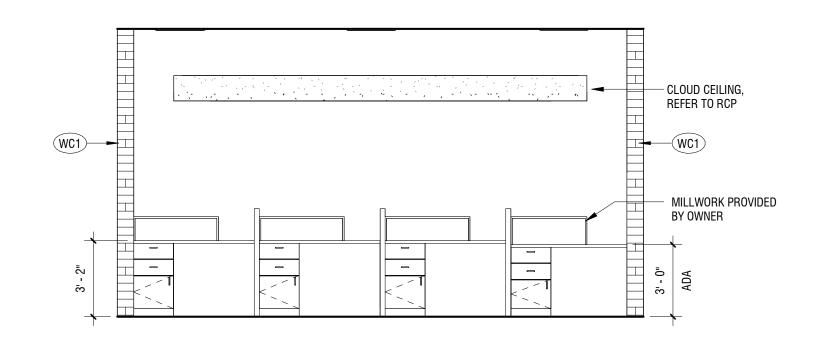

3 INTERIOR ELEVATION @ TELLER LINE SCALE: 1/4" = 1'-0"

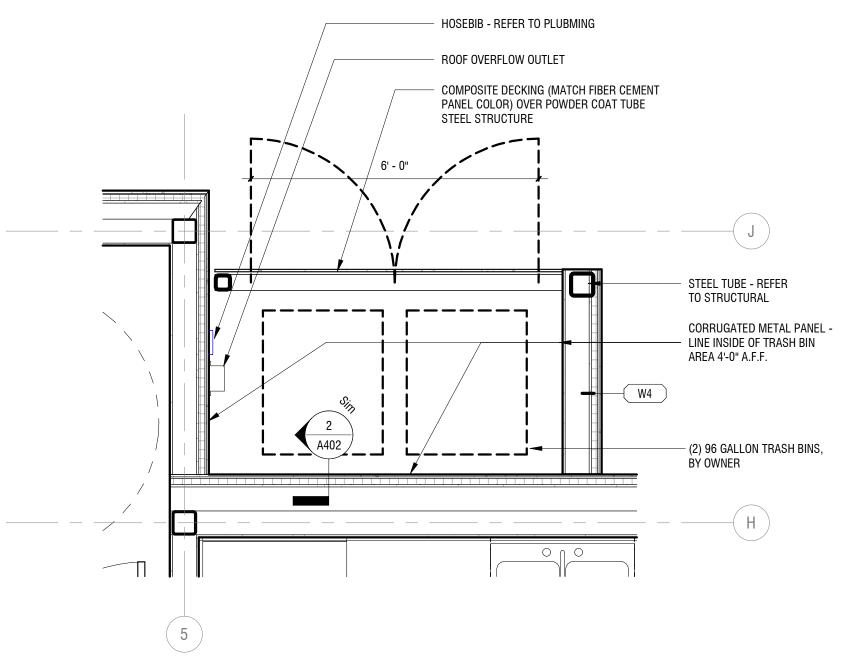

1 ENLARGED PLAN @ DUMPSTER ENCLOSURE

SCALE: 1/2" = 1'-0"



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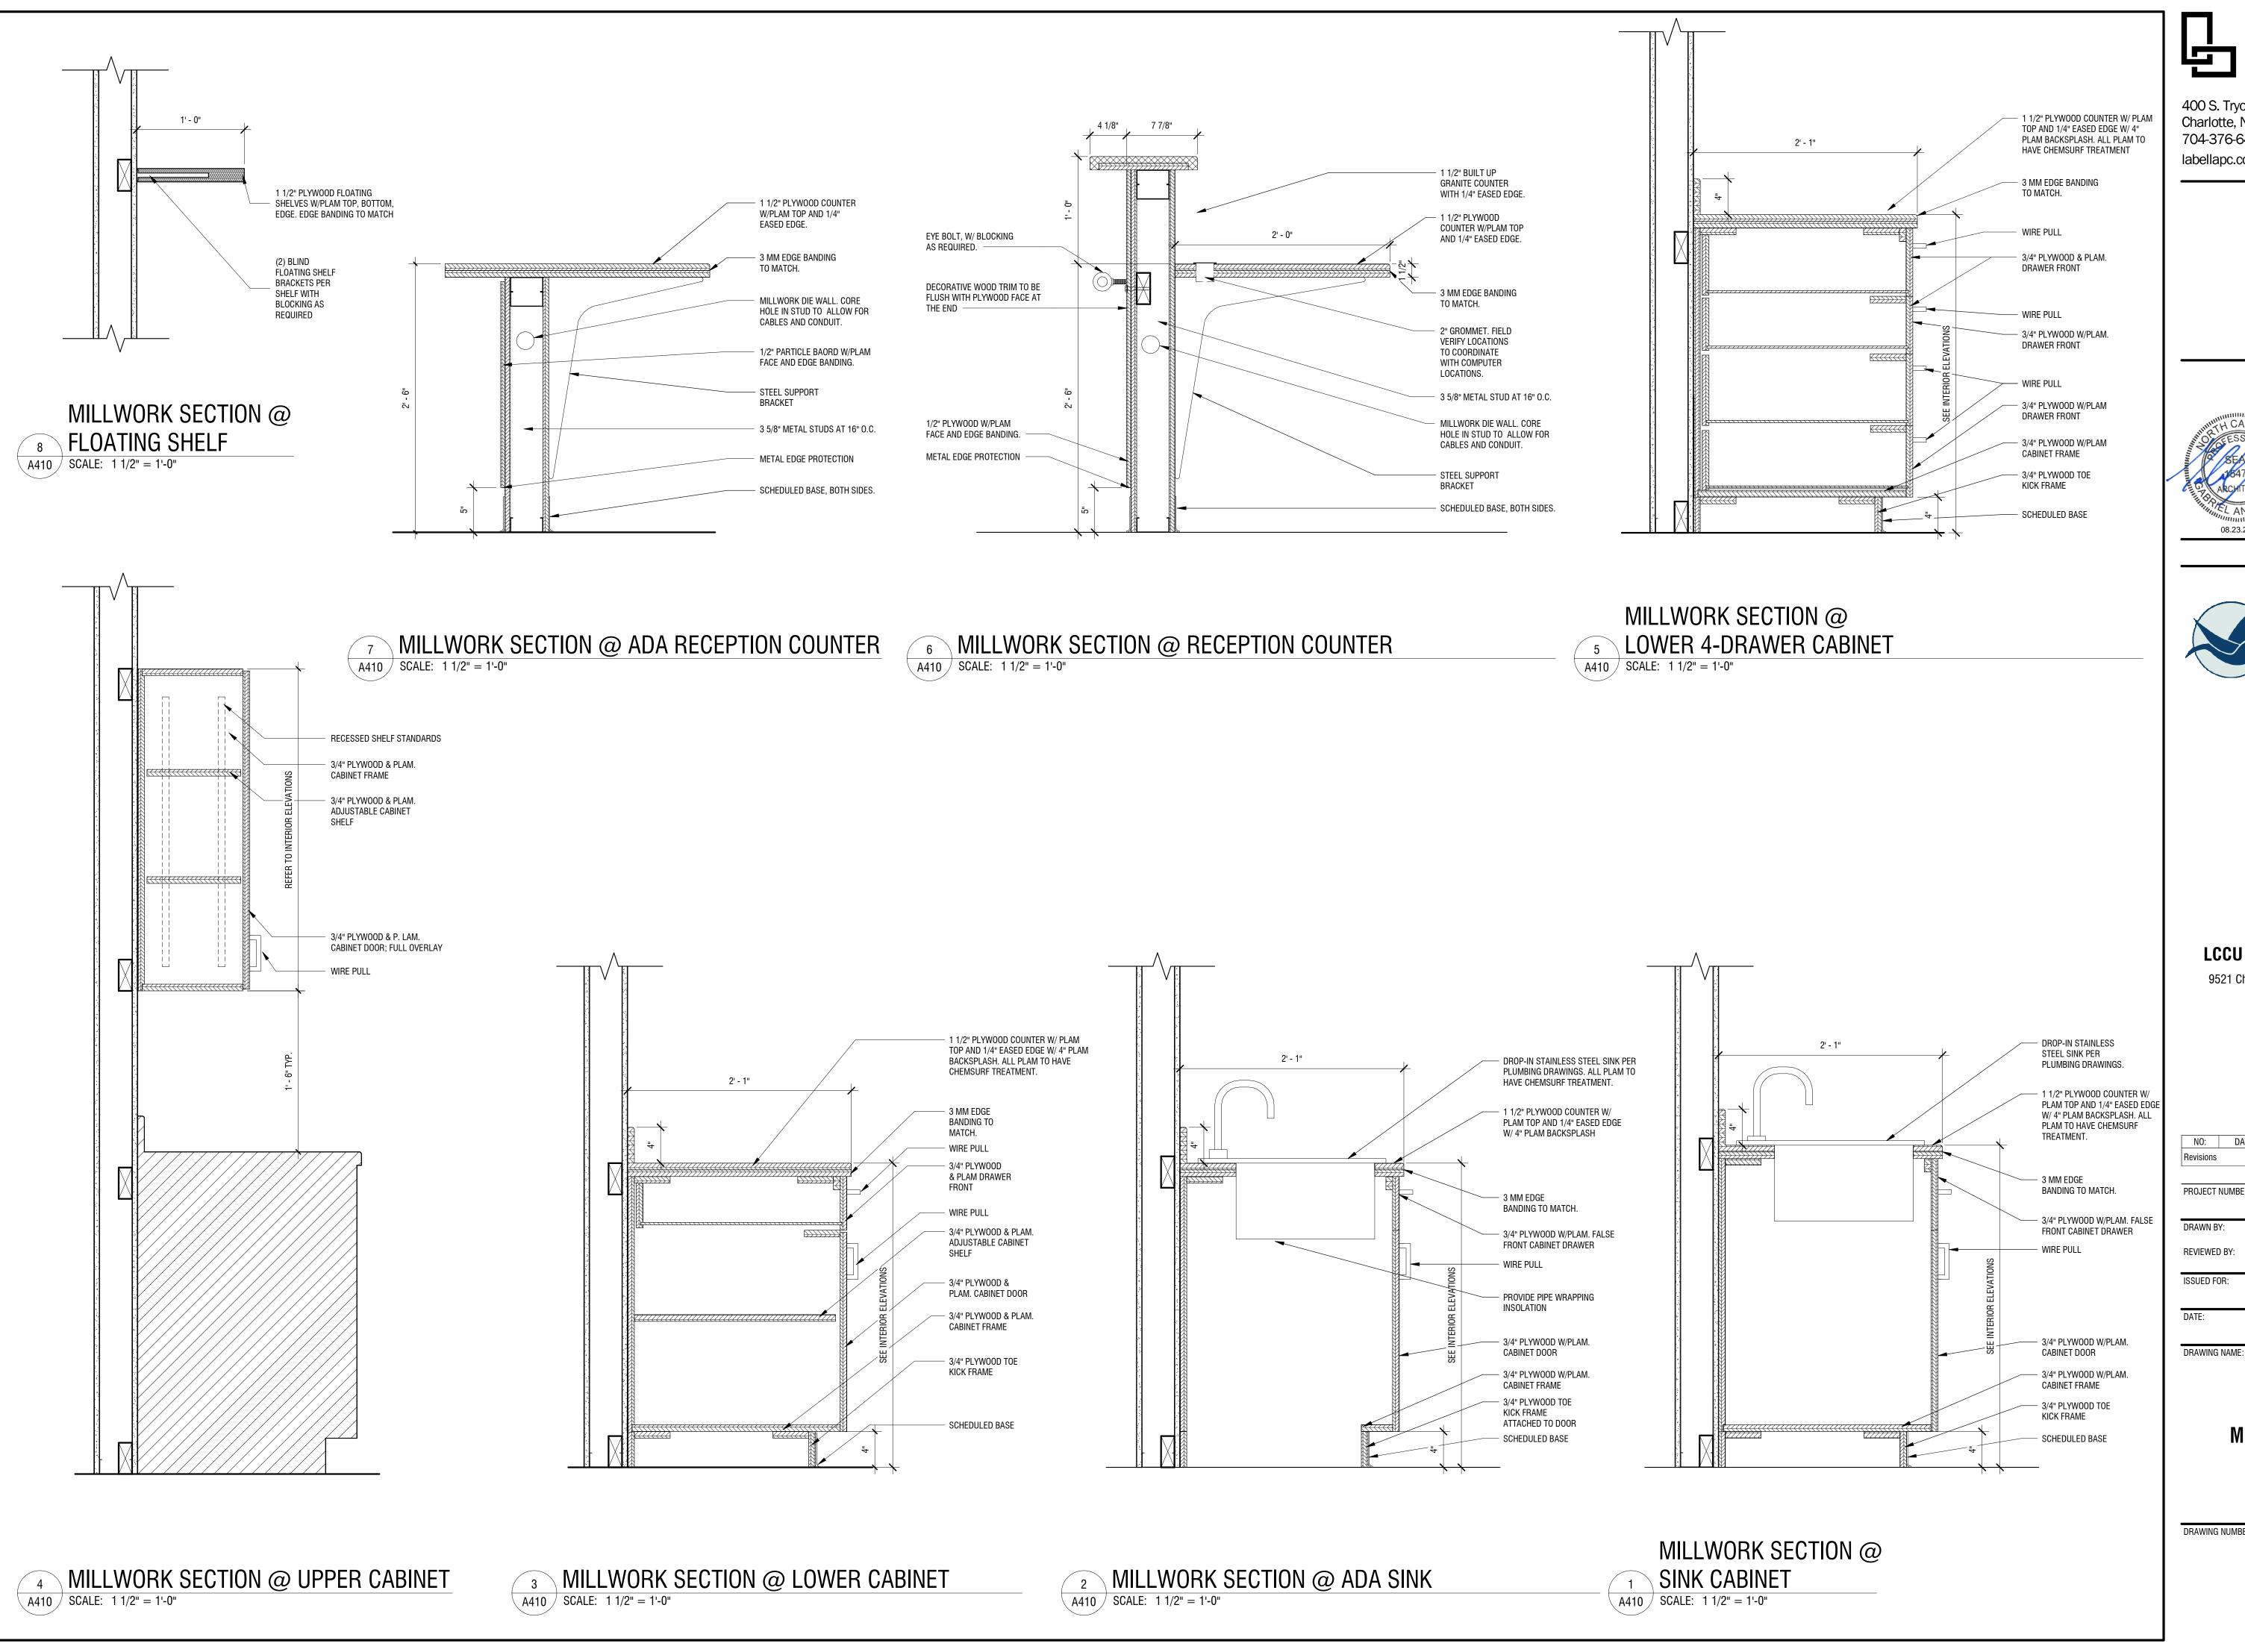
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ENLARGED PLANS AND INTERIOR ELEVATIONS

DRAWING NUMBER:

DRAWING NAME:







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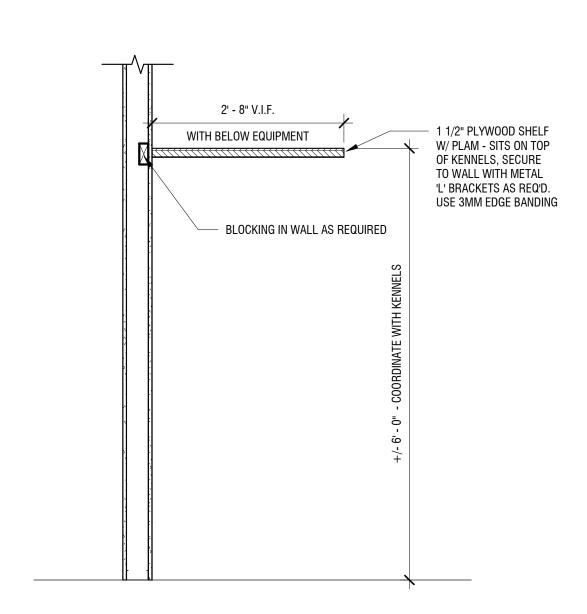


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MILLWORK DETAILS

DRAWING NUMBER:




4 MILLWORK SECTION @ DOG RECOVERY


A411 SCALE: 3/4" = 1'-0"

1 1/2" PLYWOOD SHELF W/PLAM; SUPPORTED BY PARTITIONS BETWEEN DOG RUNS


- BLOCKING IN WALL AS REQUIRED 5' - 3"

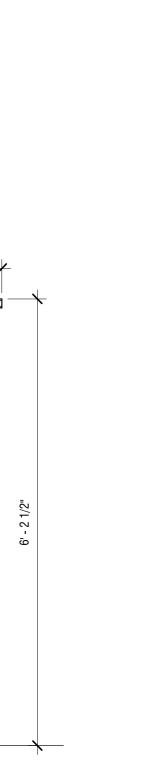

8 MILLWORK SECTION @ DOG RUNS
A411 SCALE: 3/4" = 1'-0"

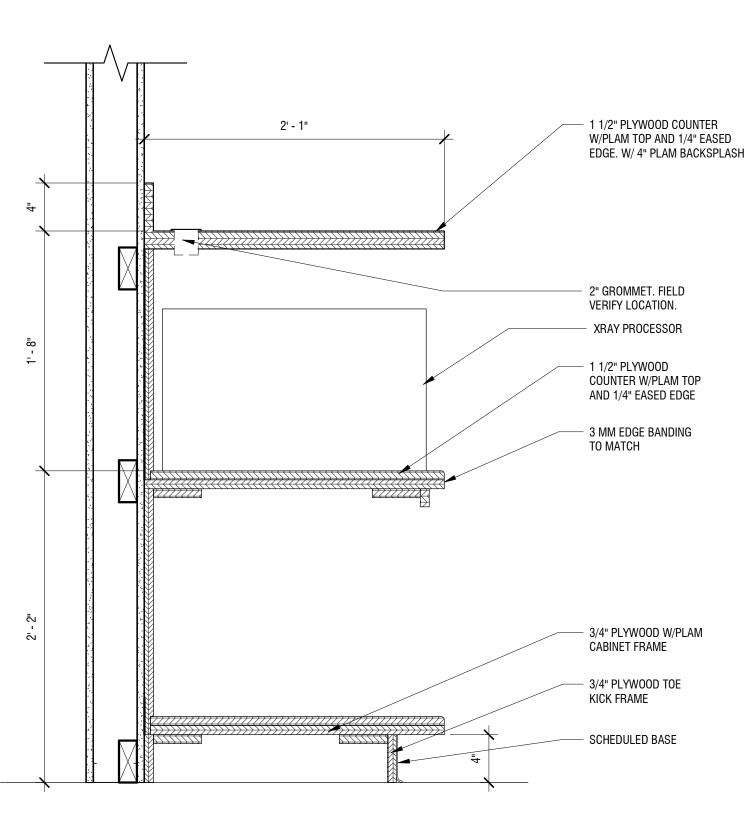


3 MILLWORK SECTION @ RADIOLOGY
A411 SCALE: 1 1/2" = 1'-0"

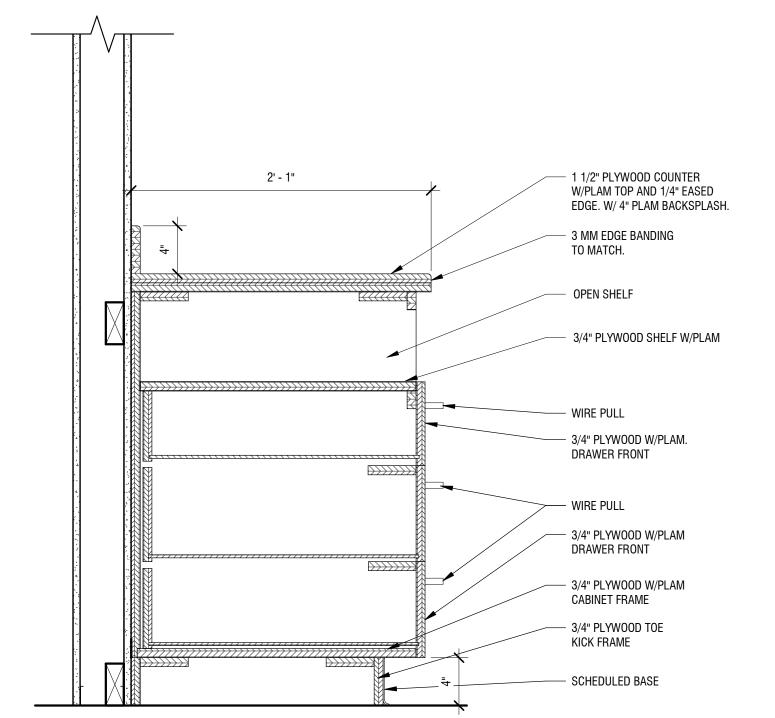


2 MILLWORK SECTION @ EXAM ROOM CABINET

A411 SCALE: 1 1/2" = 1'-0"

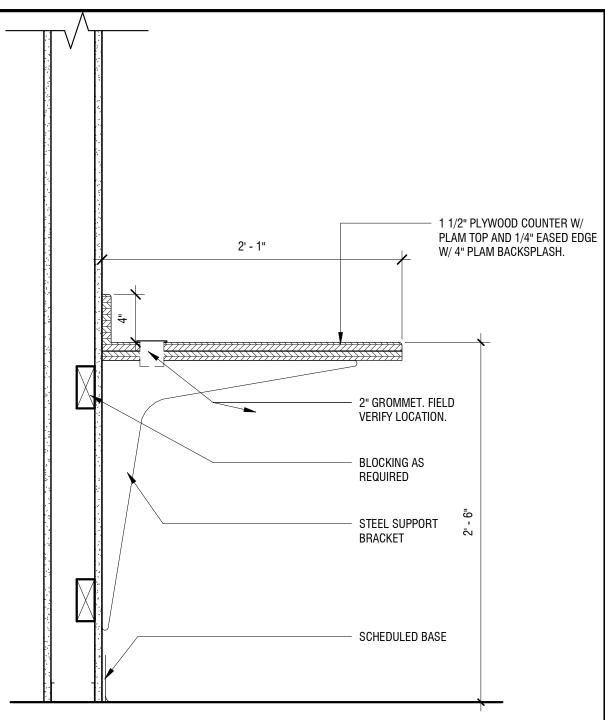

MILLWORK SECTION @ WORK SURFACE

SCALE: 1 1/2" = 1'-0"

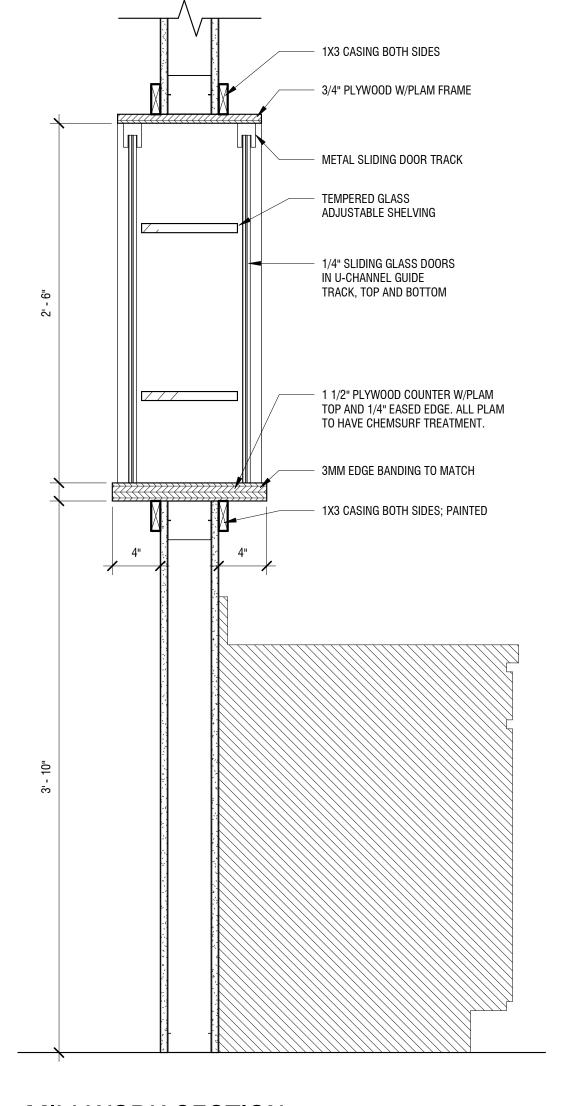

MILLWORK SECTION @

SURGERY PASS THROUGH

SCALE: 1 1/2" = 1'-0"



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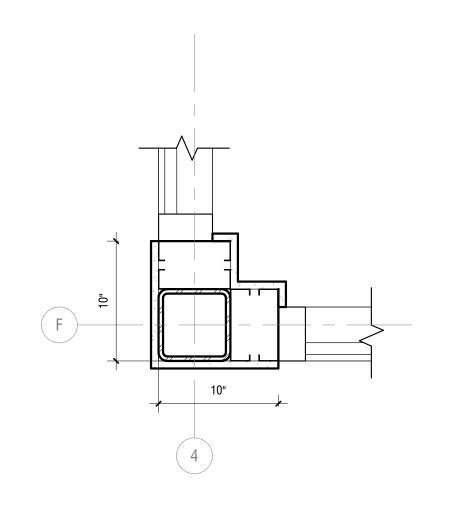


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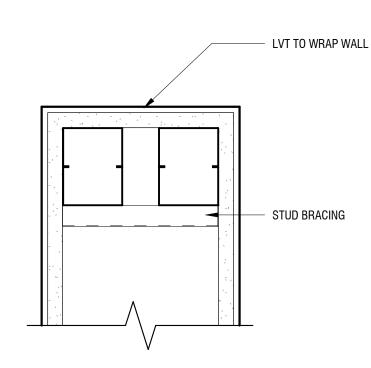
MILLWORK DETAILS

DRAWING NUMBER:



PLAN DETAIL @ INTERIOR STOREFRONT CORNER

A501 SCALE: 1 1/2" = 1'-0"



PLAN DETAIL @ 6 TELLER WALL A501 | SCALE: 3" = 1'-0"

A501 SCALE: 1 1/2" = 1'-0"




LINE OF BULKHEAD ABOVE

 LVT WALL COVERING TO WRAP WALL. CAULK JOINT W/ COLOR TO MATCH WALL


COVERING

8 1/4"



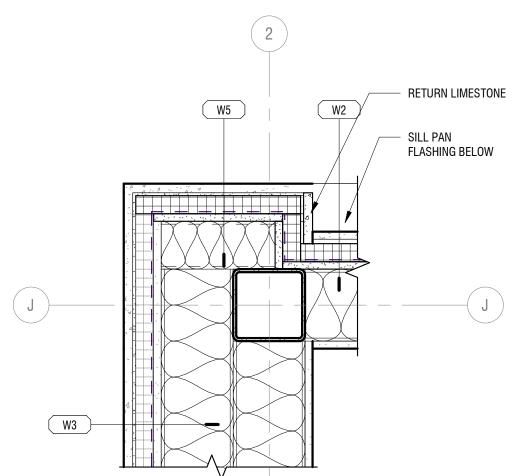

3 PLAN DETAIL @ EXTERIOR WING WALL

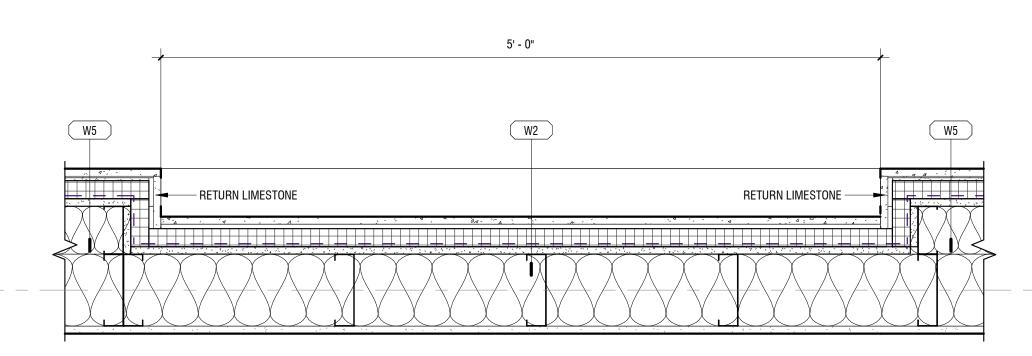

THIS CONCEPTUAL DETAIL IS A GUIDE FOR INSTALLATION OF NICHIHA PRODUCTS.

ADD STUD, BLOCKING OR STUD EXTENDER AS REQUIRED FOR FURRING AND CLIP

BEST PRACTICES AND LOCAL BUILDING CODES.

OTHER NICHIHA PRODUCT THICKNESSES.

MANAGE LOADING REQUIREMENTS.

ATTACHMENT/FASTENING.

ADJUST ACCORDINGLY.

FRAMING MEMBERS

SHEATHING

- INSIDE CORNER

A501 SCALE: 1 1/2" = 1'-0"

SCALE: 1 1/2" = 1'-0"

WEATHER RESISTANT BARRIER

NICHIHA PLAN DETAILS

ARCHITECTS/ENGINEERS/CONTRACTORS ARE RESPONSIBLE FOR SUCCESSFUL APPLICATION

NICHIHA PANEL REPRESENTED HERE IS 5/8" NICHIHA PRODUCT, ADJUST ACCORDINGLY FOR

A CODE APPROVED WEATHER/WATER RESISTANT BARRIER IS REQUIRED. PLACE PER LOCAL

REFER TO THE CONTINUOUS INSULATION SECTION OF THE NICHIHA INSTALLATION GUIDE -HORIZONTAL AWP. CONSULT A STRUCTURAL ENGINEER TO DESIGN THE FURRING SYSTEM TO


NICHIHA - HORIZONTAL AWP - CONTINUOUS INSULATION WITH FURRING

SHEATHING REPRESENTED HERE IS 1/2" PLYWOOD OR 7/16" OSB. IF USING OTHER THICKNESSES

WHICH DEPENDS UPON SUBSTRATE DESIGN AND CONSTRUCTION BUILT IN ACCORDANCE WITH

² PLAN DETAIL @ WINDOW RECESS SCALE: 1 1/2" = 1'-0"

THIS DETAIL SHOWS TYPICAL ANCHORAGE, REINFORCING AND MASONRY VENEER EXPANSION JOINT INFO. FOR ALL SIMILAR PLAN DETAILS. IF MASONRY VENEER TIE OCCURS AT EXPANSION JOINT CUT ONE SIDE OF TIE AND INSTALL JOINT STABILIZATION ANCHOR IN MASONRY VENEER ACROSS EXPANSION JOINT ALSO INSTALL JOINT STABILIZATION ANCHOR IF TIES OCCUR MORE THAN 8"

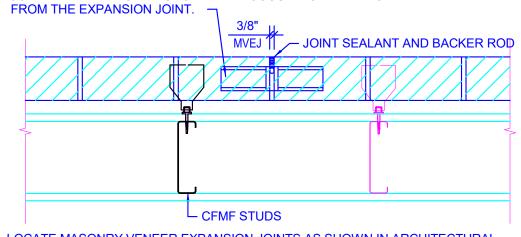

LOCATE MASONRY VENEER EXPANSION JOINTS AS SHOWN IN ARCHITECTURAL BUILDING ELEVATION DRAWINGS. PROVIDE ADDITIONAL JOINTS (COORD W/ ARCH) AS REQUIRED TO COMPLY WITH THE FOLLOWING:

1. AT ALL ABRUPT CHANGES IN WALL HEIGHT.

2. MAXIMUM HORIZONTAL SPACING OF 30'

3. WITHIN 10' FROM A CORNER

8 MASONRY EXPANSION JOINT @ MTL STUD SCALE: 1 1/2" = 1'-0"

CONTINUOUS INSULATION


>1" THICKNESS

SEALANT OVER SINGLE FLANGE SEALANT BACKER

NICHIHA CLIP FASTENED TO MIN. 18 GA FURRING


SECURE FURRING TO STRUCTURE

- THIS CONCEPTUAL DETAIL IS A GUIDE FOR INSTALLATION OF NICHIHA PRODUCTS. ARCHITECTS/ENGINEERS/CONTRACTORS ARE RESPONSIBLE FOR SUCCESSFUL APPLICATION WHICH DEPENDS UPON SUBSTRATE DESIGN AND CONSTRUCTION BUILT IN ACCORDANCE WITH BEST PRACTICES AND LOCAL BUILDING CODES.
- NICHIHA PANEL REPRESENTED HERE IS 5/8" NICHIHA PRODUCT, ADJUST ACCORDINGLY FOR OTHER NICHIHA PRODUCT THICKNESSES.
- SHEATHING REPRESENTED HERE IS 5/8" EXTERIOR GYP. IF USING OTHER THICKNESSES ADJUST ACCORDINGLY. A CODE APPROVED WRB IS REQUIRED. PLACE PER LOCAL CODE.
- REFER TO THE CONTINUOUS INSULATION SECTION IN THE NICHIHA INSTALLATION GUIDE -HORIZONTAL AWP. CONSULT A STRUCTURAL ENGINEER TO DESIGN THE FURRING SYSTEM TO MANAGE LOADING REQUIREMENTS.

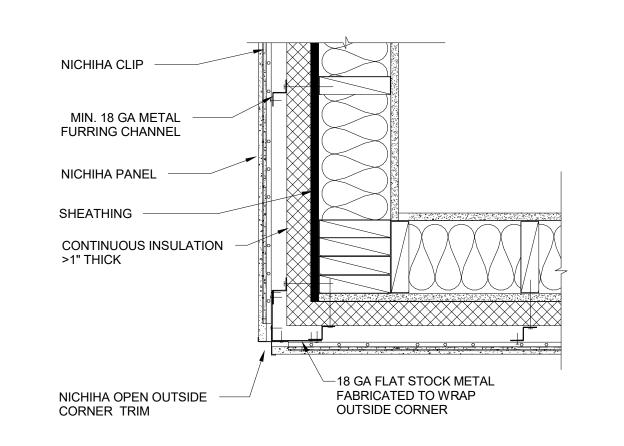

NICHIHA - HORIZONTAL AWP - CONTINUOUS INSULATION WITH FURRING OUTSIDE CORNER - OPEN OUTSIDE CORNER TRIM

ALUM. STOREFRONT REFER TO PLAN CFMF STUD TO ATTACH RETURN GWB TO FRAME,

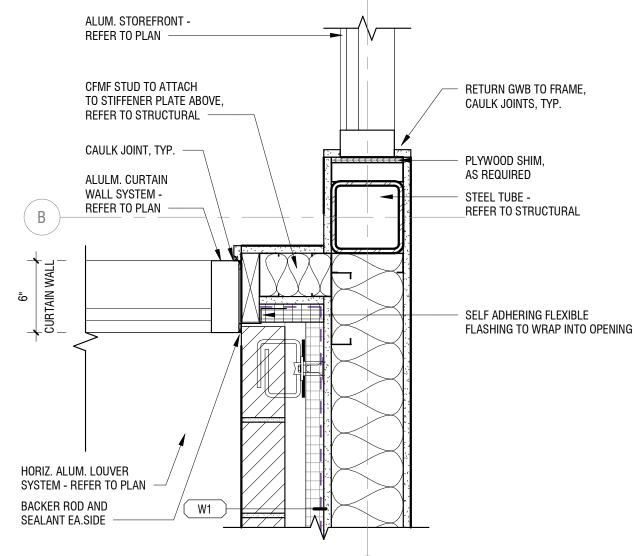

PLAN DETAIL @ LOBBY STOREFRONT AND BRICK A501 | SCALE: 1 1/2" = 1'-0"

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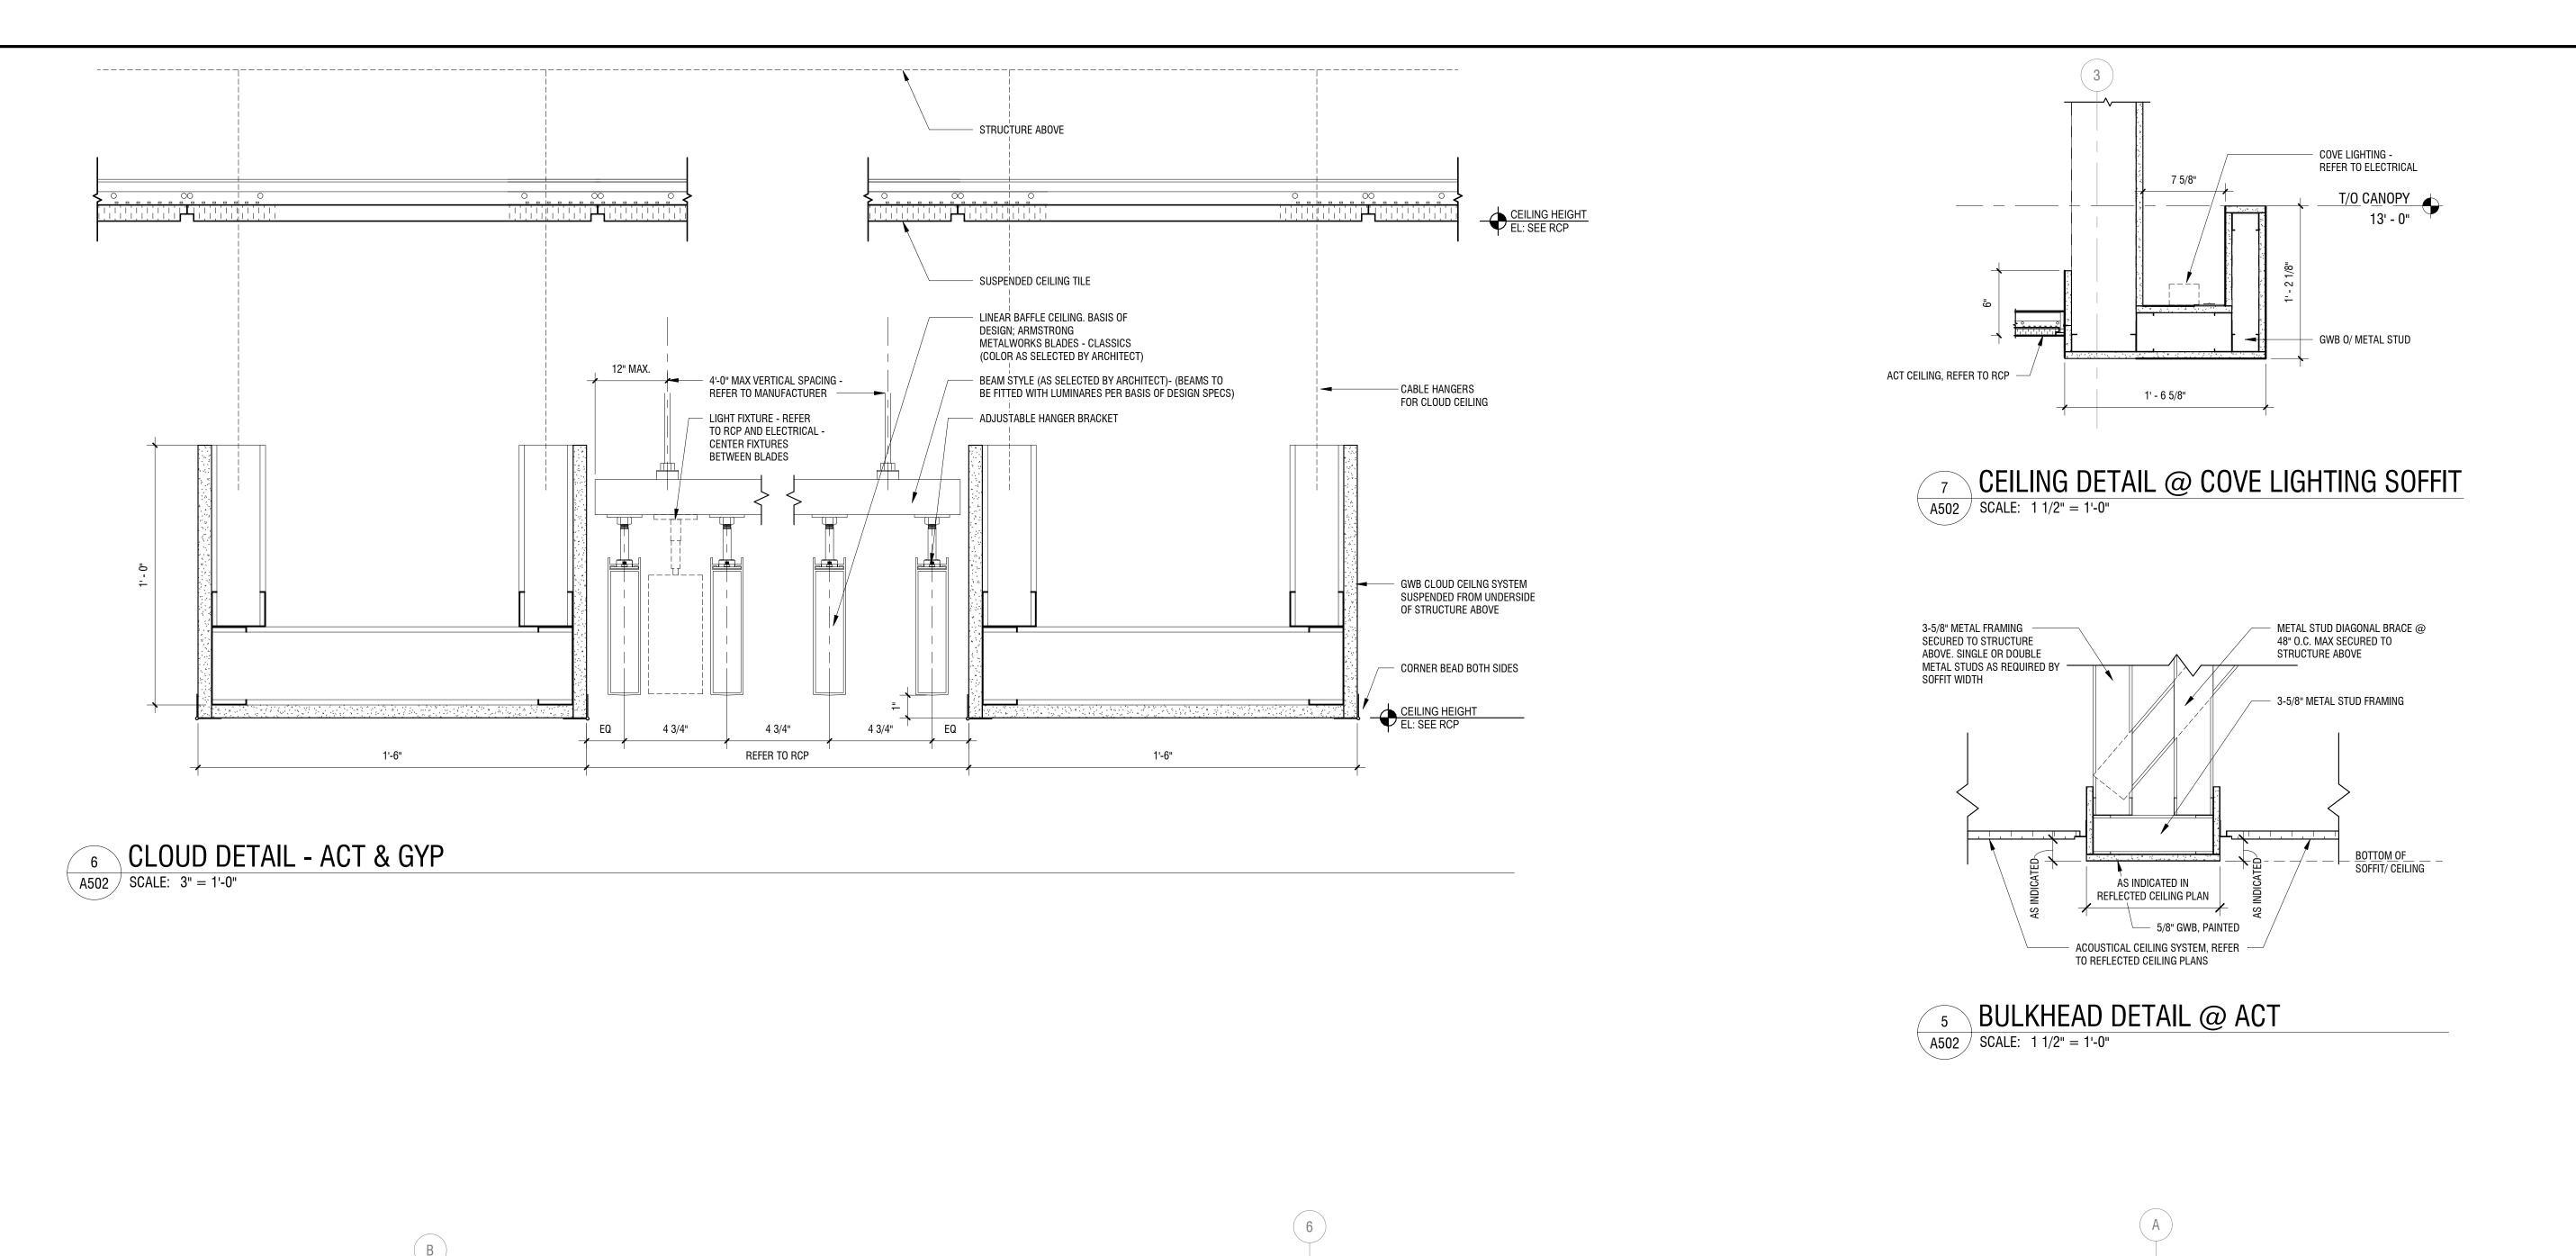


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NO: DATE: DESCRIPTION: PROJECT NUMBER: 2230150 DRAWN BY: BAW REVIEWED BY: ISSUED FOR: **BID SET** DATE: 08.23.2024 DRAWING NAME:

PLAN DETAILS

DRAWING NUMBER:



SELF-ADHERING

FLEXIBLE FLASHING

- PARGE COAT, COLOR

STARTER FLASHING,

REFER TO MANUF.

- CONCRETE SIDEWALK - SLOPE

ALUM. DOOR - REFER TO DOOR SCHEDULE

REINFORCED CONCRETE SLAB

ON GRADE - SEE STRUCTURAL -

2" RIGID INSULATION 24"

15 MIL. VAPOR BARRIER O/ 6" COMPACTED GRAVEL —

REINFORCED CONCRETE FOOTING -

A502 | SCALE: 1 1/2" = 1'-0"

TYPICAL FOUNDATION DETAIL @ STOREFRONT

SEE STRUCTURAL

AROUND PERIMTER -

AWAY FROM BUILDING - SEE CIVIL

ALUM. LOUVER SYSTEM -

REFER TO STOREFRONT TYPES

1ST FLOOR

- 1/2" FIBER EXPANSION JOINT

SCHEDULED BASE

REINFORCED CONCRETE SLAB

ON GRADE - SEE STRUCTURAL

2" RIGID INSULATION 24"

15 MIL. VAPOR BARRIER O/ 6" COMPACTED GRAVEL

REINFORCED CONCRETE STEM

REINFORCED CONCRETE FOOTING -


FOUNDATION DETAIL @ THIN MASONRY

SCALE: 1 1/2" = 1'-0"

WALL FOUNDATION -SEE STRUCTURAL —

SEE STRUCTURAL

AROUND PERIMTER -

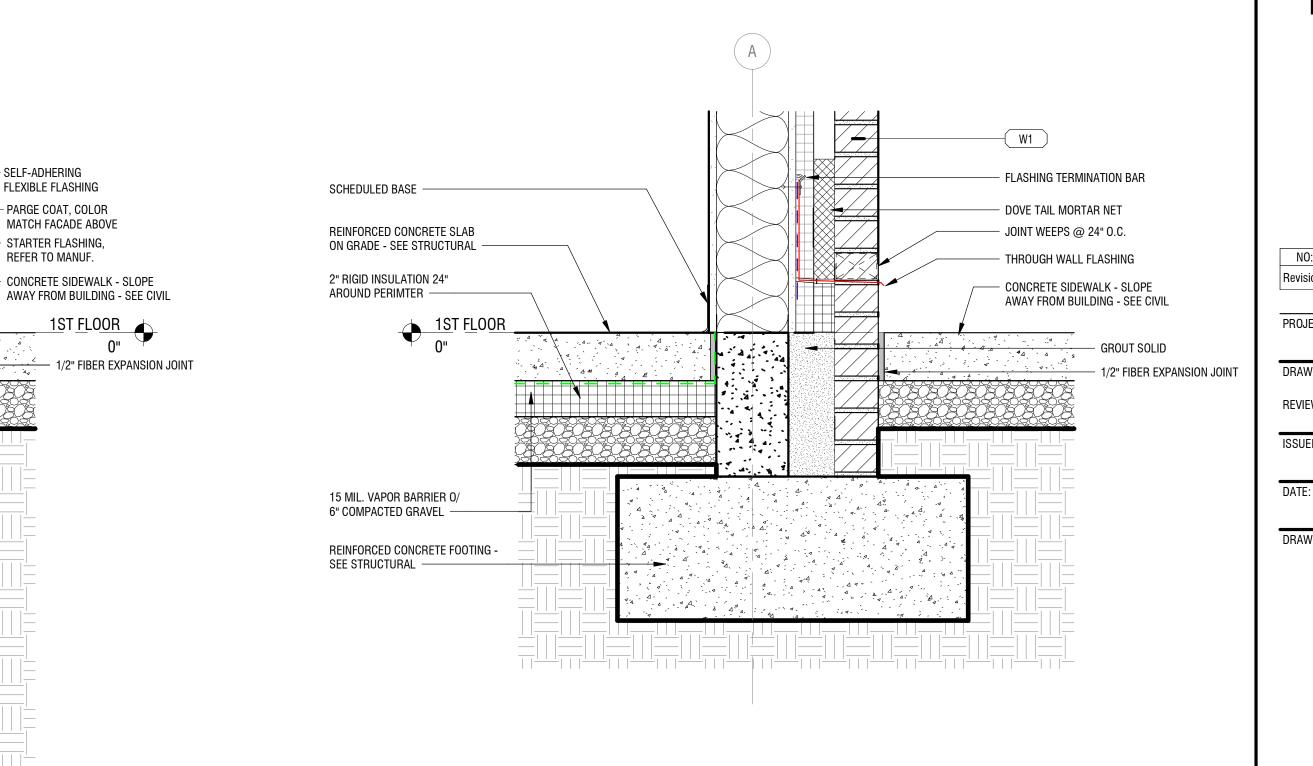

TYPICAL FOUNDATION DETAIL @ BRICK

A502 | SCALE: 1 1/2" = 1'-0"



SECTION AND CEILING

DRAWING NUMBER:

NO: DATE:

PROJECT NUMBER:

DRAWN BY:

REVIEWED BY:

ISSUED FOR:

DRAWING NAME:



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BAW

BID SET


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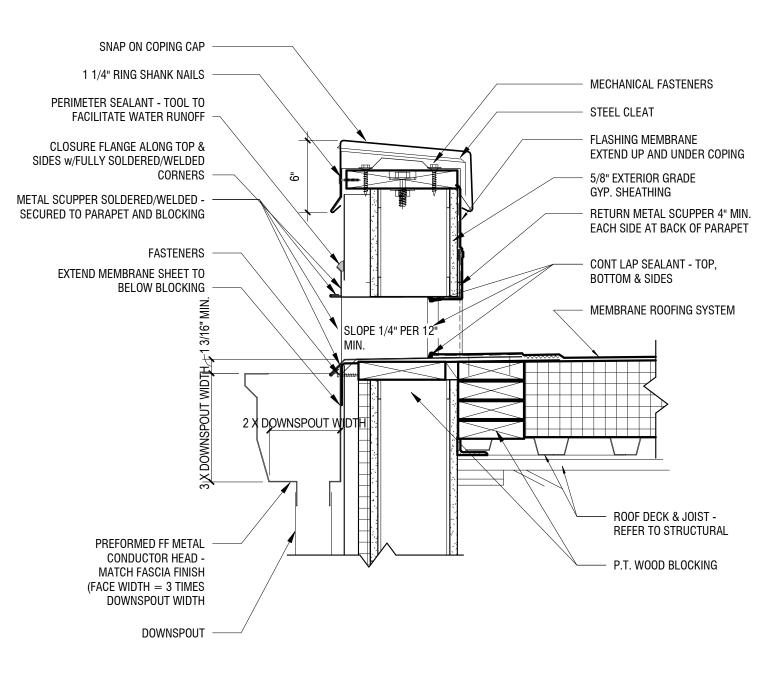





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TE:		08.23.2024	
VWING	NAME:		

PARAPET AND ROOF

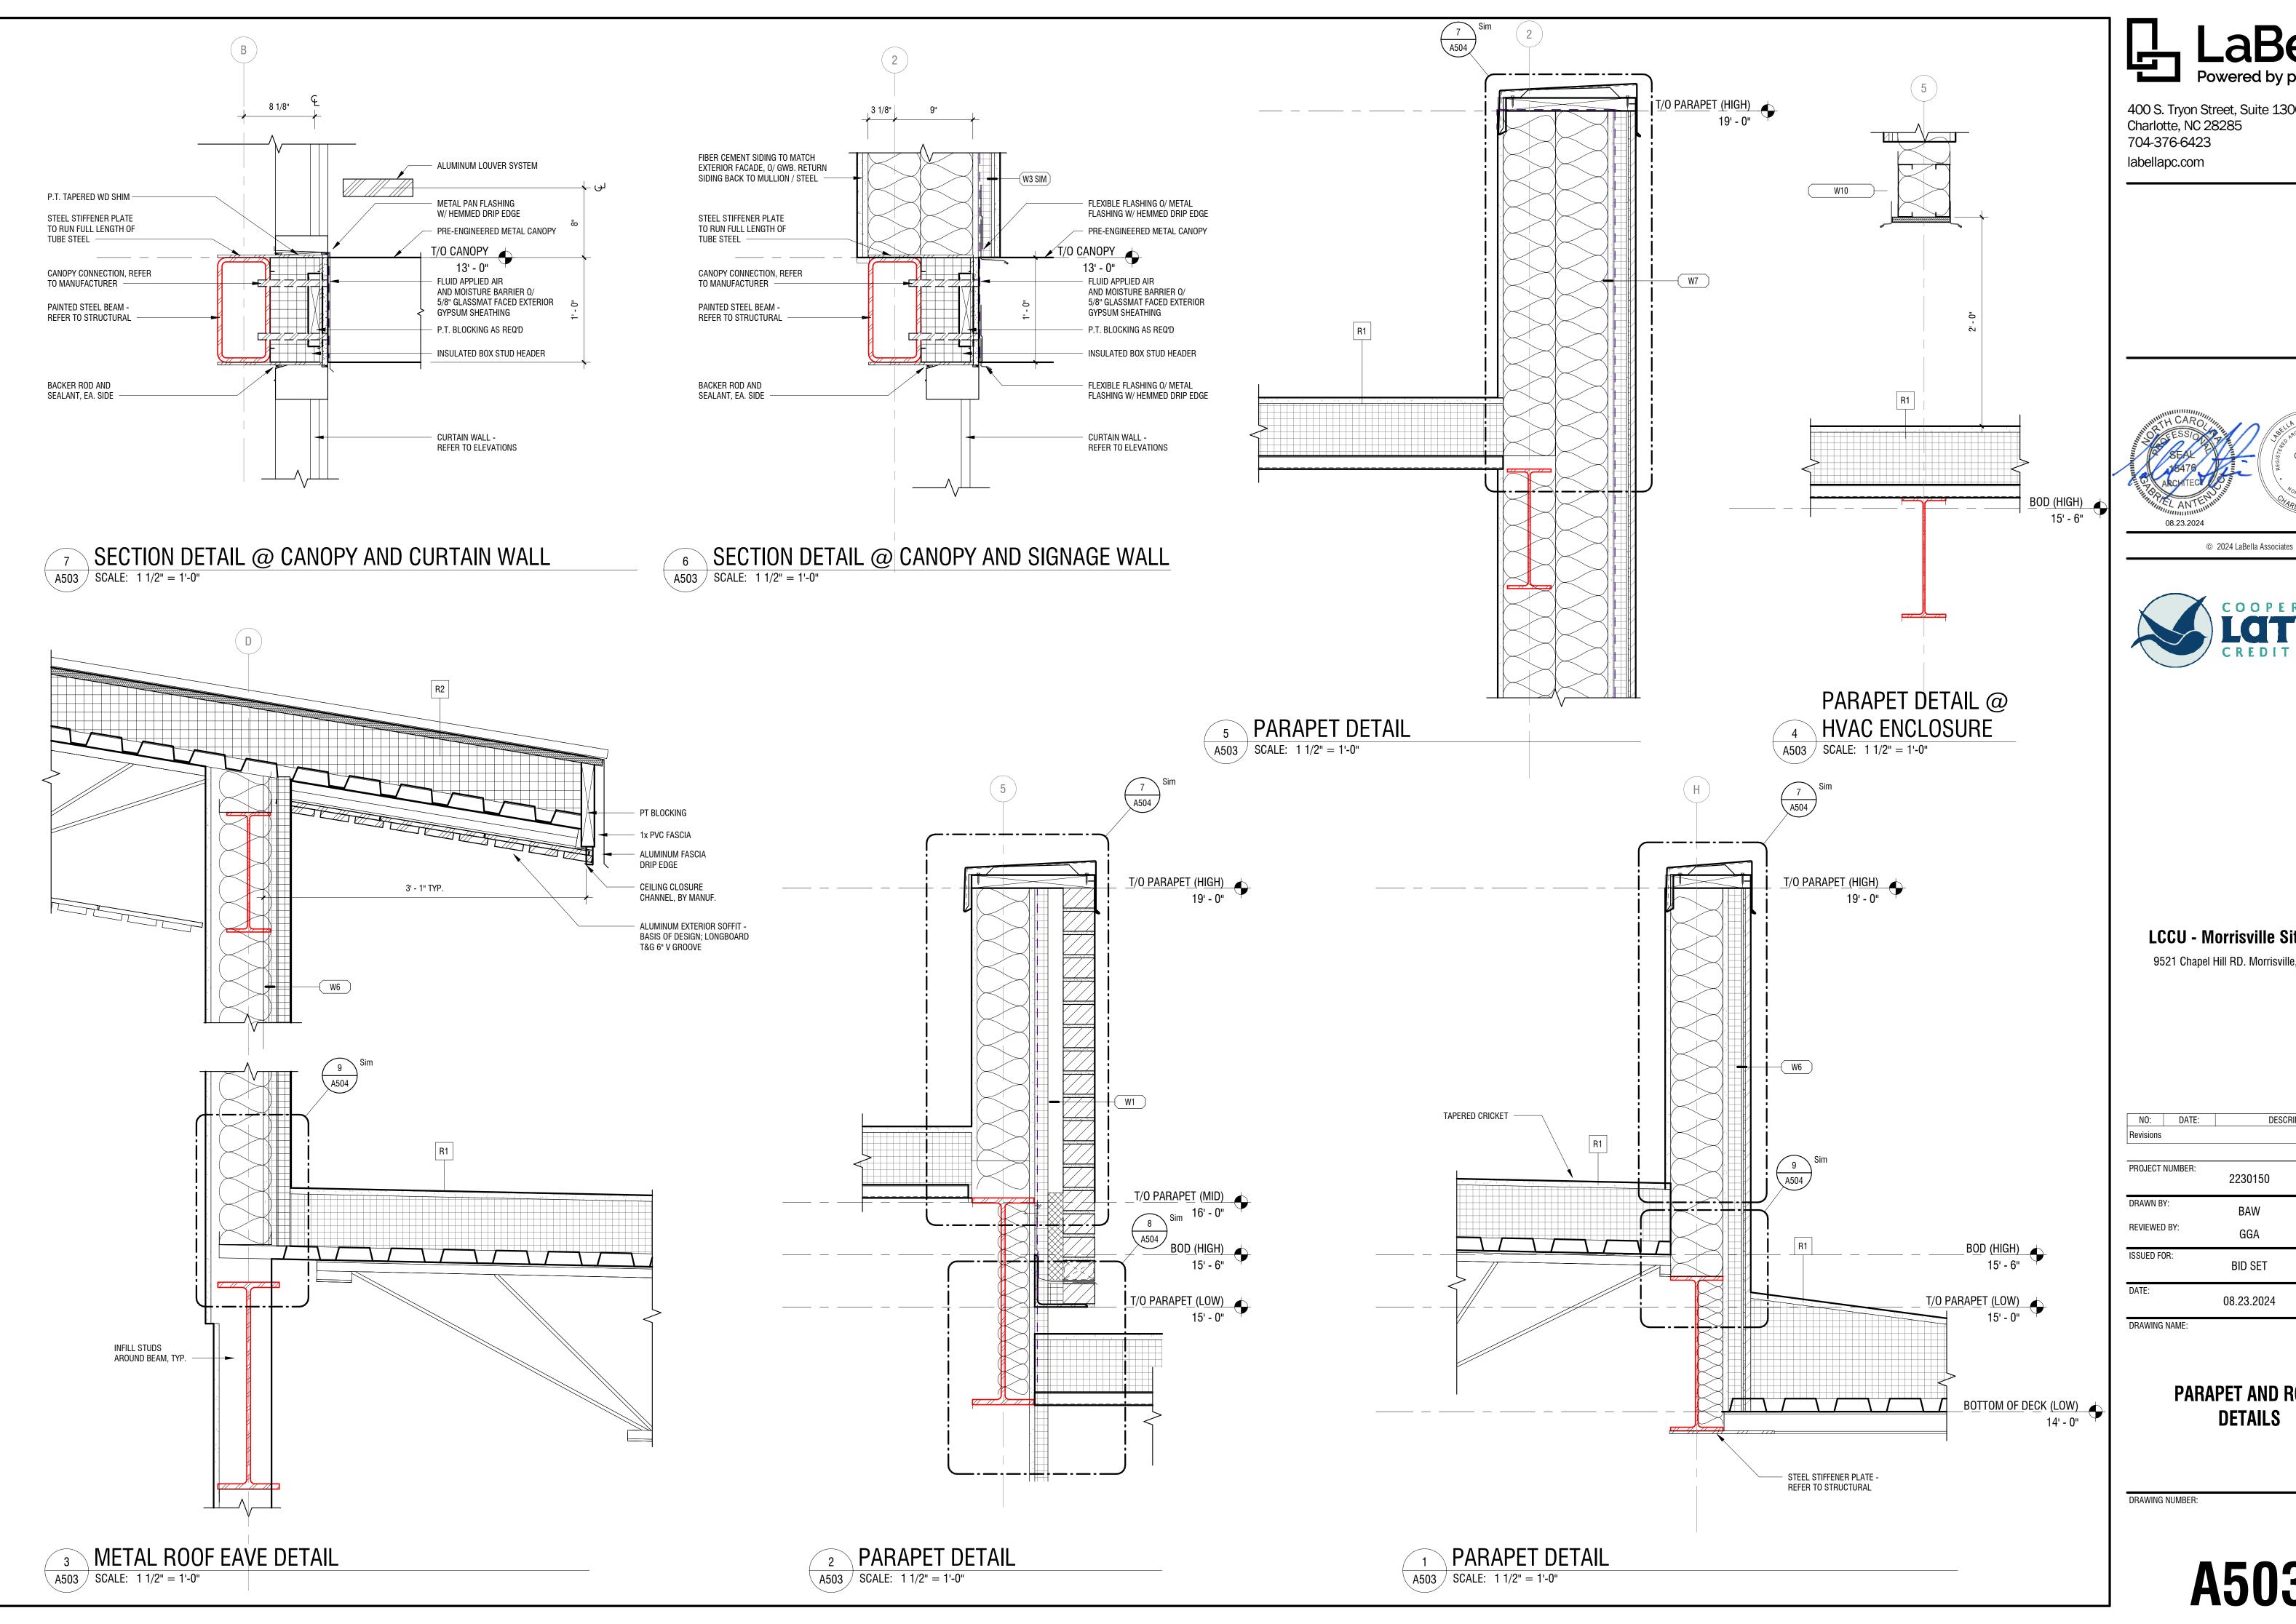


TYPICAL THRU-WALL SCUPPER DETAIL

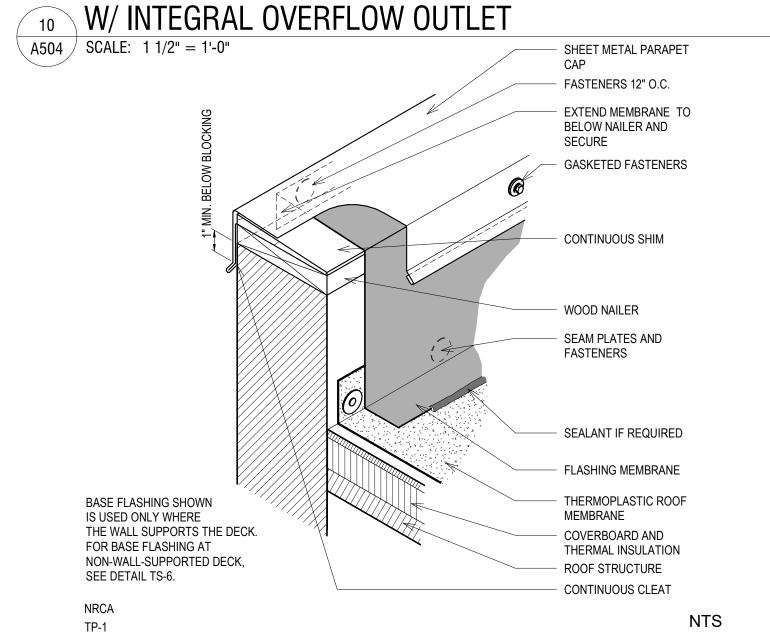


7 COPING AND BASE FLASHING

A504 SCALE: 3" = 1'-0"

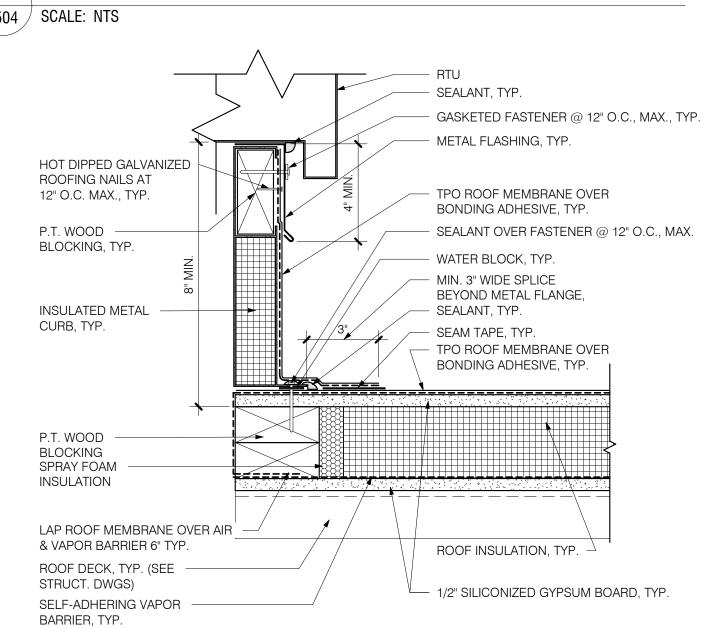




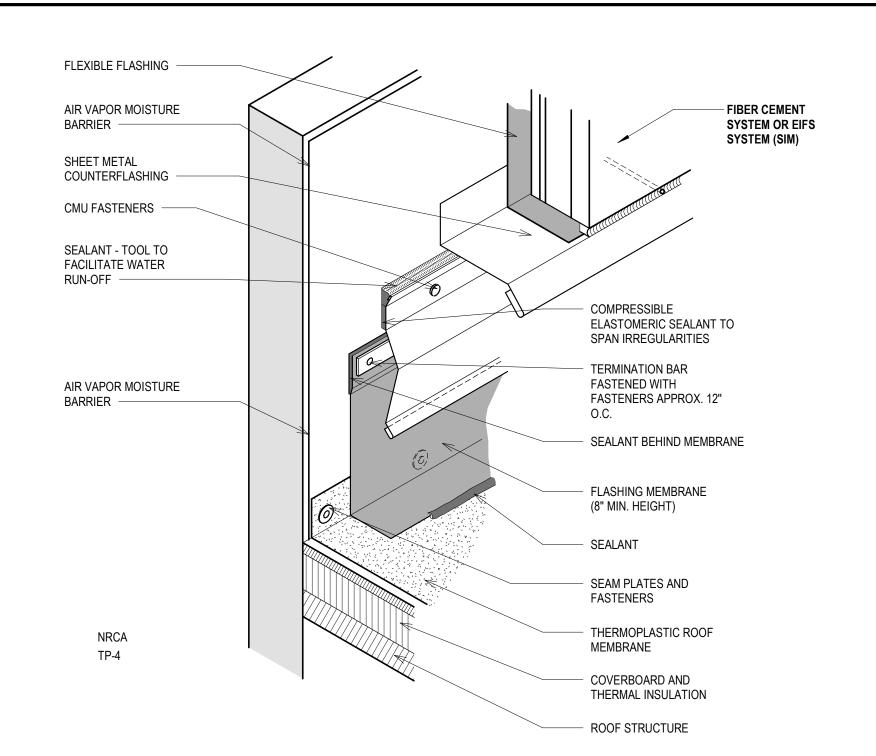


9 COUNTERFLASHING AT FIBER CEMENT (EIFS SIM) A504 SCALE: NTS

COPING AS SCHEDULED

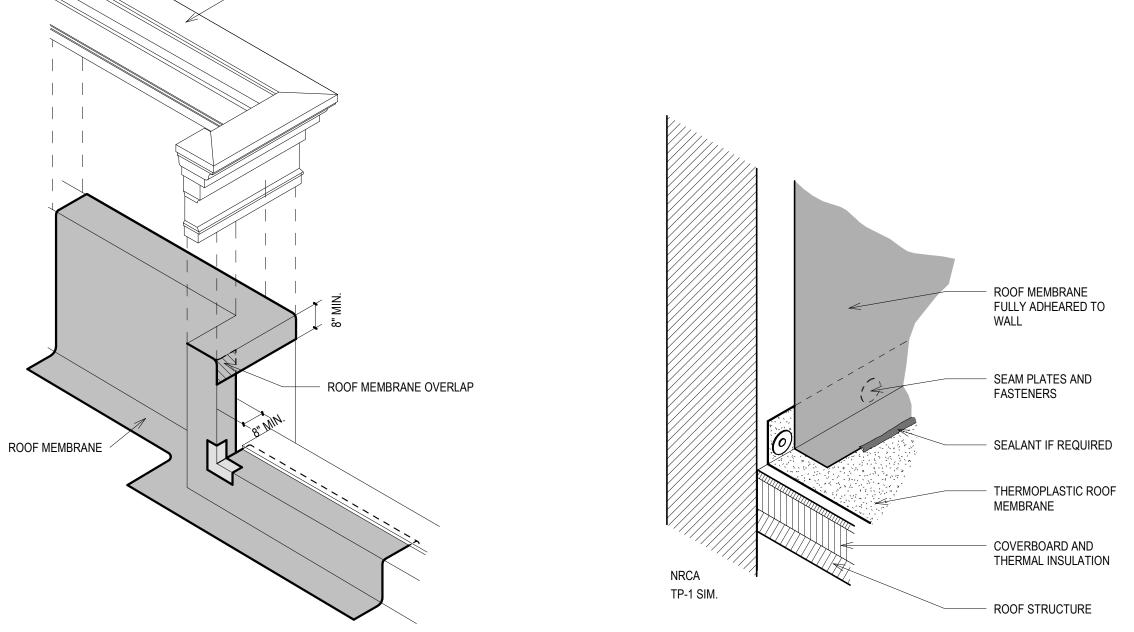

6 CORNER PARAPET FLASHING DETAIL 5 MEMBRANE BASE FLASHING A504 SCALE: NTS

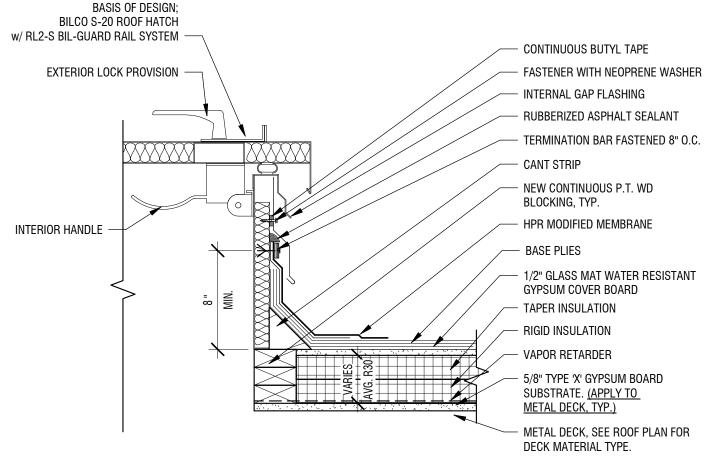

2 TYP ROOF HATCH DETAIL A504 SCALE: 1 1/2" = 1'-0"

NOTES:

1. ALL BOLTS OR CLAMPS MUST BE IN PLACE TO PROVIDE CONSTANT COMPRESSION ON WATER CUT-OFF MASTIC.

2. CUT ROOF MEMBRANE SO IT EXTENDS MIN. 1/2* FROM ATTACHMENT POINTS OF DRAIN CLAMPING RING.

3. HOLE IN MEMBRANE MUST EXCEED DRAIN PIPE SIZE.

4. INSULATION TAPER SHALL NOT BE STEEPER THAN 6 INCHES (VERTICAL) IN 12 INCHES (HORIZONTAL).

5. REFER TO STRUCTURAL DRAWINGS FOR ROOF DECK TYPE AND SIZE.

6. OVERFLOW DRAIN SHALL HAVE BUILT-IN WEIR WHICH PREVENTS RAINWATER FROM IMMEDIATELY ENTERING SYSTEM. WEIR ELEVATION TO BE MAINTAINED AT 4* ABOVE SPILLWAY FOR PRIMARY ROOF DRAIN.

FLEXIBLE FLASHING

AIR VAPOR MOISTURE

BARRIER

SHEET METAL

COUNTERFLASHING

CMU FASTENERS

SEALANT - TOOL TO

FACILITATE WATER

AIR VAPOR MOISTURE

NRCA

COUNTERFLASHING AT BRICK

SEALANT, TYP.

FIELD FABRICATED

METAL HOOD, TYP.

PRE-MOLDED PIPE FLASHING, TYP.

BONDING

ADHESIVE, TYP.

PRIMER, TYP.

ROOF INSULATION, TYP.

P.T. WOOD

BLOCKING

PIPE PENETRATION

TPO ROOF PIPE BOOT

CLAMPING RING

WATER CUT-OFF MASTIC

MEMBRANE FLASHING

ROOF DECK, TYP. (SEE

STRUCT. DWGS)

 \land A504 \nearrow SCALE: 3" = 1'-0"

ZIVATA

TP-4

A504 SCALE: NTS

RUN-OFF -

BARRIER

TYPICAL ROOF DRAIN - MEMBRANE ROOFING SYSTEM

SCALE: 3" = 1'-0"

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COMPRESSIBLE

ELASTOMERIC SEALANT TO

SPAN IRREGULARITIES

FASTENERS APPROX. 12"

FLASHING MEMBRANE

(8" MIN. HEIGHT)

SEAM PLATES AND

THERMOPLASTIC ROOF

COVERBOARD AND

ROOF STRUCTURE

CONT. BEAD OF LAP

S.S. CLAMPING RING, TYP.

TPO MEMBRANE OVER BONDING ADHESIVE,

CONT. BEAD OF LAP

SEALANT (SEAM EDGE TREATMENT),

- SELF-ADHERING

- HOT AIR WELD

- PROTECTION BOARD

BONDING ADHESIVE

- MEMBRANE ROOFING OVER

VAPOR BARRIER,

TYP. 1/2" SILICONIZED GYPSUM

LAP ROOF MEMBRANE OVER AIR & VAPOR BARRIER 6", TYP.

SEALANT, TYP.

SPRAY FOAM INSULATION

THERMAL INSULATION

FASTENERS

MEMBRANE

SEALANT

SEALANT BEHIND MEMBRANE

TERMINATION BAR

FASTENED WITH



COOPERATIVA

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NO:	DATE:	DESCRIPT	ION:
Revisions			
PROJECT NUMBER:		2230150	
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REVIEWED	BY:	GGA	
		GGA	
ISSUED FO	DR:	BID SET	
DATE:		08.23.2024	
DRAWING	NΔME·		

ROOF DETAILS

DRAWING NUMBER:

GENERAL DOOR NOTES AND GLAZING NOTES

- 1. ALL LOCK SET HANDLES TO BE LEVEL TYPE AND MEET THE ADA REQUIREMENTS
- 2. ALL DOOR HARDWARE HEIGHT SHALL COMPLY WITH IBC 1008.1.9
- 3. ALL DOOR HARDWARE SHALL MEET IBC CHAPTERS 10 AND 11 4. SEALANTS TO MATCH ADJACENT SURFACE. TAPE ON STOREFRONT 1/4" FOR STRAIGHT LINE. 5. KEYING ALL LOCKS TO BE KEYED BY HARDWARE SUPPLIER. ORDER ALL LOCKS "0" BITTED.
- ALL CYLINDERS TO BE "LB" KEYWAY. COORDINATE FINAL KEYING WITH OWNER. 6. MANUFACTURER TO ADJUST OVERALL FRAME SIZES TO ACCOMODATE PERIMETER SEALANT JOINT SIZE.

GLAZING LEGEND

- GL-1 = 1" TEMPERED INSULATED LOW-E GL-2 = 1" ANNEALED INSULATED LOW-E GL-3 = 1/4" TEMPERED
- GL-4 = 1/4" ANNEALED GL-5 = 1" ANNEALED INSULATED LOW-E SPANDREL (COLOR MATCH TO CURTAIN WALL)

	DOOR SCHEDULE																
	D00R								FRAME								
				PANEL	SIZE		DOOR			FRAME		DET	AIL		HARDWARE		
MARK	TO: ROOM NAME	DOOR TYPE	PANEL WIDTH A	PANEL WIDTH B	HEIGHT	THICKNESS	MATERIAL	DOOR FINISH	FRAME TYPE	MATERIAL	FRAME FINISH	HEAD DETAIL	JAMB DETAIL	GLAZING	SET	COMMENTS	MARK
102	SERVER	F	3' - 0"		7' - 0"	1 3/4"	WOOD	STN-1	S	НМ	PNT	12/A603	11/A603	-	8		102
104	TELLER	F	3' - 0"		7' - 0"	1 3/4"	WOOD	STN-1	S	НМ	PNT	12/A603	11/A603	-	9		104
105	STORAGE	F	3' - 0"		7' - 0"	1 3/4"	WOOD	STN-1	S	НМ	PNT	12/A603	11/A603	-	6		105
106	PASSAGE	F	3' - 0"		7' - 0"	1 3/4"	WOOD	STN-1	S	НМ	PNT	12/A603	11/A603	-	4		106
107	WOMEN	F	3' - 0"		7' - 0"	1 3/4"	WOOD	STN-1	S	НМ	PNT	12/A603	11/A603	-	3		107
108	MEN	F	3' - 0"		7' - 0"	1 3/4"	WOOD	STN-1	S	НМ	PNT	12/A603	11/A603	-	3		108
109	JANITOR	F	1' - 9"	1' - 9"	7' - 0"	1 3/4"	WOOD	STN-1	S	НМ	PNT	12/A603	11/A603	-	10		109
110	PASSAGE	F	3' - 0"		7' - 0"	1 3/4"	WOOD	STN-1	S	НМ	PNT	12/A603	11/A603	-	5		110
111A	BREAK ROOM	F	3' - 0"		7' - 0"	1 3/4"	WOOD	STN-1	N	ALUM	FACT	8/A603	4/A603	-	9		111A
111B		F	3' - 0"		7' - 0"	1 3/4"	ALUM	FACT	F	ALUM	FACT			-	1		111B
112	WAITING	FG1	3' - 0"		7' - 0"	1 3/4"	WOOD	STN-1	L	ALUM	FACT	8/A603	4/A603	GL-3	5		112
113	OFFICE	FG1	3' - 0"		7' - 0"	1 3/4"	WOOD	STN-1	L	ALUM	FACT	8/A603	4/A603	GL-3	5		113
114	OFFICE	FG1	3' - 0"		7' - 0"	1 3/4"	WOOD	STN-1	L	ALUM	FACT	8/A603	4/A603	GL-3	5		114
115	OFFICE	FG1	3' - 0"		7' - 0"	1 3/4"	WOOD	STN-1	L	ALUM	FACT	8/A603	4/A603	GL-3	5		115
116	OFFICE	FG1	3' - 0"		7' - 0"	1 3/4"	WOOD	STN-1	L	ALUM	FACT	8/A603	4/A603	GL-3	5		116
117	WAITING	FG1	3' - 0"		7' - 0"	1 3/4"	WOOD	STN-1	L	ALUM	FACT	8/A603	4/A603	GL-3	5		117
118	WAITING	FG1	3' - 0"		7' - 0"	1 3/4"	WOOD	STN-1	L	ALUM	FACT	8/A603	4/A603	GL-3	5		118
119	WAITING	FG1	3' - 0"		7' - 0"	1 3/4"	WOOD	STN-1	L	ALUM	FACT	8/A603	4/A603	GL-3	5		119
120																	120
121	STORAGE	F	3' - 0"		7' - 0"	1 3/4"	WOOD	STN-1	S	НМ	PNT	12/A603	11/A603	-	6		121
122	OFFICE	FG1	3' - 0"		7' - 0"	1 3/4"	WOOD	STN-1	L	ALUM	FACT	8/A603	4/A603	GL-3	5		122




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26D McKinney M 626 Schleage. Gray Rockwood 32D Rockwood

McKinney Mfg. Co.

5' - 0"

17' - 3 1/2"

3' - 0"

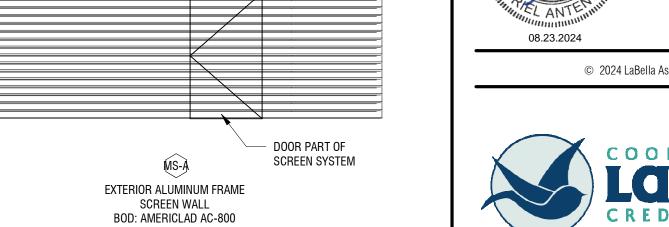9' - 3 1/2"

1 MECHANICAL SCREEN TYPE A


A601 SCALE: 1/4" = 1'-0"



16' - 9"

EXTERIOR ALUMINUM FRAME SCREEN WALL

BOD: AMERICLAD AC-800

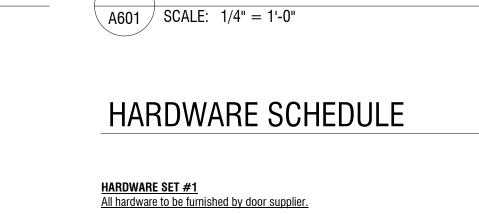

MS-B

EXTERIOR ALUMINUM FRAME

SCREEN WALL

BOD: AMERICLAD AC-800

² MECHANICAL SCREEN TYPE B

	ARE SET #1			HARDWARE SET #6(storeroom set-storage)				
All Hardw	vare to be furnished by door supplier.			3	Ea	Hinge - TA2714 4.5x4.5		
1	Sets Offset pivots top, bottom, and intermediate			1	Ea	Storeroom Set - AL80PD SAT		
1	Ea Surface mounted closers			3	Ea	Silencer - 608		
1	Ea MS 1850A lock		Adams-Rite	1	Ea	Wall Stop - 409		
1	Ea Aluminum threshold					•		
1	Set Weatherstrip			HARDWARE SET #7 (atm)				
1	Ea Push/Pull - CO9/CP		Kawneer					
1	Set Door sweep			3	Ea	Hinge - T4A3786 4.5x4.5 NRP		
1	Ea Cylinder 1E72, CMK, MK,	27	Best Lock Corp.	1	Ea	Flush bolt - 555		
1	Ea Cylinder Construction Core		Best Lock Corp.	1	Ea	Deadbolt - 83T KL STK		
•	Eu Symnusi Contanuonion Coro		Book Eook Gorpi	1	Fa	Closer - 351 PS		
HARDWA	ARE SET #2			1	Ea	Lockguard - LG10		
	vare to be furnished by door supplier.			1	Fa	Threshold - 613		
7 til Haraw	varo to be fulfilled by addr supplier.			1	Fa	Viewer - 698		
2	Sets Offset pivots top, bottom, and intermediate			1	Set			
2	Ea Surface mounted closers			1	Ea	Door sweep - 102VA		
4			Adama Dita	1		•		
1	Ea MS 1850A lock		Adams-Rite	ı	Ea	Door closer Coordinator		
2	Ea Aluminum threshold			HADDW		FT "0 ()		
2	Set Weatherstrip			<u>HAKDW</u>	AKE S	ET #8 (storeroom set w/ card reader - coord. w/		
2	Fa Duch/Dull COO/CD		Kawnoor					

2 1 2	Ea	Surface mounted closers MS 1850A lock Aluminum threshold		Adams-Rite
2 2		Weatherstrip Push/Pull - CO9/CP		Kawneer
2		Door sweep		
1		Cylinder 1E72, CMK, MK,	27	Best Lock Corp.
1	Ea	Cylinder Construction Core		Best Lock Corp.
<u>HARDW</u>	ARE S	ET #3 (restroom)		
3	Ea	Hinge - TA2714 4.5x4.5	26D	McKinney Mfg. Co.
1	Ea	,	26D	Schlage
1		Closer - 351 PS	EN	Sargent
2		Kick plate - K1038 8"x34"x.038" SA	32D	Rockwood
1		Wall Stop - 409	26D	Rockwood
3		Silencer - 608	Gray	Rockwood
1	Łа	Tactile Pictogram Sign w/ Braille - BFM687 "Men" or Tactile Pictogram Sign w/ Braille - BFM688 "Women"	Black Black	Rockwood Rockwood
HARDW.	ARE S	ET #4 (Mother's Rm)		
3	Ea	Hinge - TA2714 4.5x4.5	26D	McKinney Mfg. Co.
1	Ea	Privacy Set - AL40S SAT	26D	Schlage
1	Ea	Closer - 351 PS	EN	Sargent
3	Ea	Silencer - 608	Gray	Rockwood
1	Ea	Wall Stop - 409	32D	Rockwood
HARDW.	ARE S	ET #5 (passage/offices)		
3	Ea	Hinge - TA2714 4.5x4.5	26D	McKinney Mfg. Co.
1	Ea	Passage Set - AL10S SAT	626	Schalge
3	Ea	Silencer - 608	Gray	Rockwood
1	Ea	Wall Stop - 409	32D	Rockwood

3 1 1 1 1 1 1 1 1	Ea Ea Ea Ea Ea Set Ea	Threshold - 613 Viewer - 698 Weatherstrip - 156V Door sweep - 102VA	ALUM	PO 26D 26D EN USP National (B26D National (lves Guard
<u>HARDW</u>	ARE S	ET #8 (storeroom set w/ card reader - coord. w/ s	ecurity ve	<u>ıdor)</u>	
3 1 1 1	Ea Ea Ea	Hinge - TA2714 4.5x4.5 Storeroom Set w/ C-Lock Electric Strike - Fail Secure Exit Device		26D	McKinney Mfg. Co.
3	Ea Ea			Gray	Rockwood
1		Closer - 351 PS		EN	Sargent
1	Ea	Wall Stop - 409		32D	Rockwood
1	Ea	Viewer - 698		B26D	Ives
HARDW	ARE S	ET #9 (storeroom set-bank function)			
3	Ea	Hinge - TA2714 4.5x4.5		26D	McKinney Mfg. Co.
1	Ea	Storeroom Set - AL80PD SAT		626	Schleage.
3	Ea	Silencer - 608		Gray	Rockwood
2	Ea			EN	Sargent
1	Ea	Wall Stop - 409		32D	Rockwood
1	Ea	Viewer - 698		B26D	Ives
<u>HARDW</u>	ARE S	ET #10 (storeroom set-storage)			
6	Ea	Hinge - TA2714 4.5x4.5		26D	McKinney Mfg. Co.
2	Ea			626	Schleage.
6	Ea	Silencer - 608		Gray	Rockwood
2	Ea	Overhead stop		aruy	Hookwood
		•			
NOTE.					

HARDWARE SCHEDULE IS FOR REFERENCE ONLY. CONTRACTOR TO SUBMIT ACTUAL HARDWARE SCHEDULE FOR REVIEW AND APPROVAL BY ARCHITECT PRIOR TO PURCHASING HARDWARE.


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Revisions		
PROJECT NUMBER:		2230150
DRAWN BY:		BAW
REVIEWED BY: ISSUED FOR: DATE:		GGA
		BID SET
		08.23.2024


DOOR SCHEDULE AND DETAILS

DRAWING NUMBER:

DRAWING NAME:

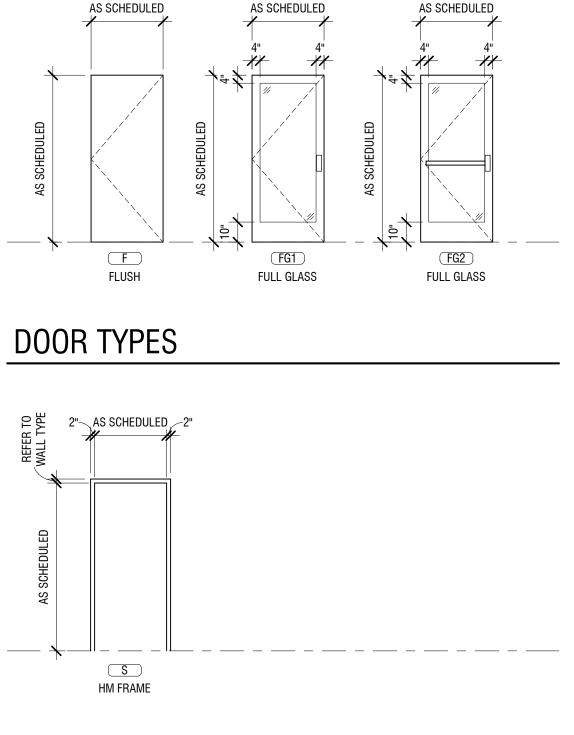

FRAME TYPES

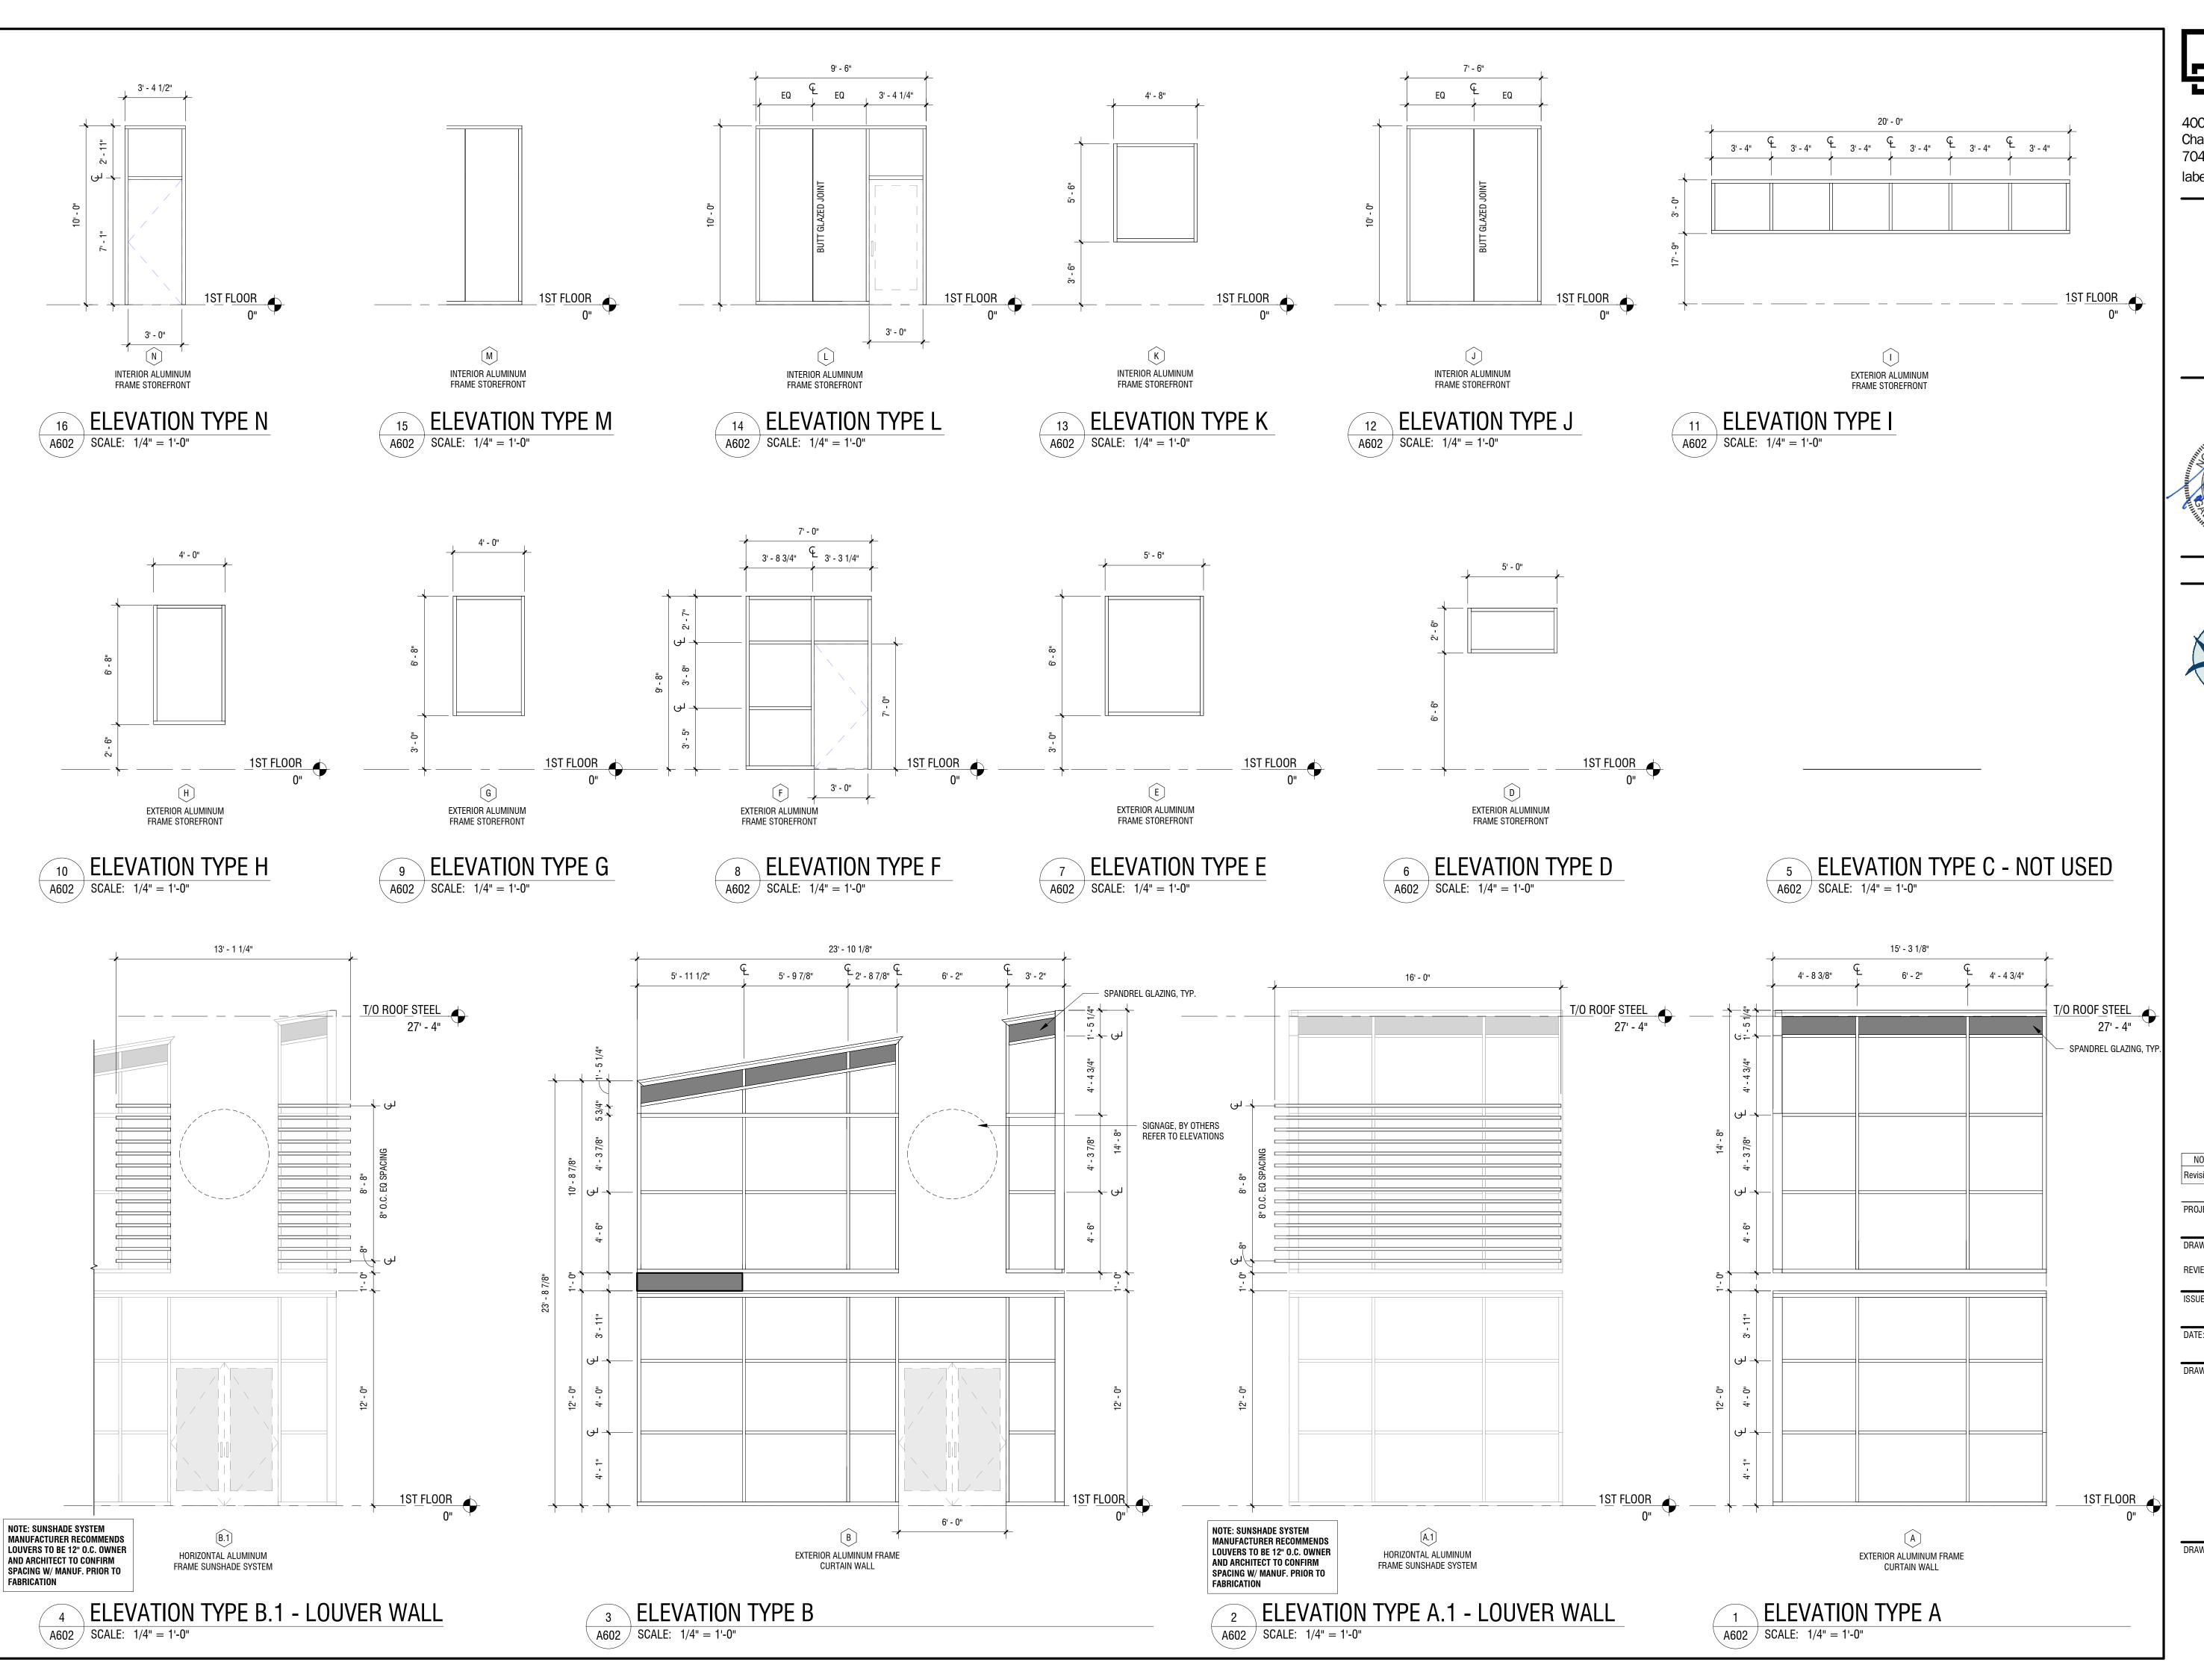





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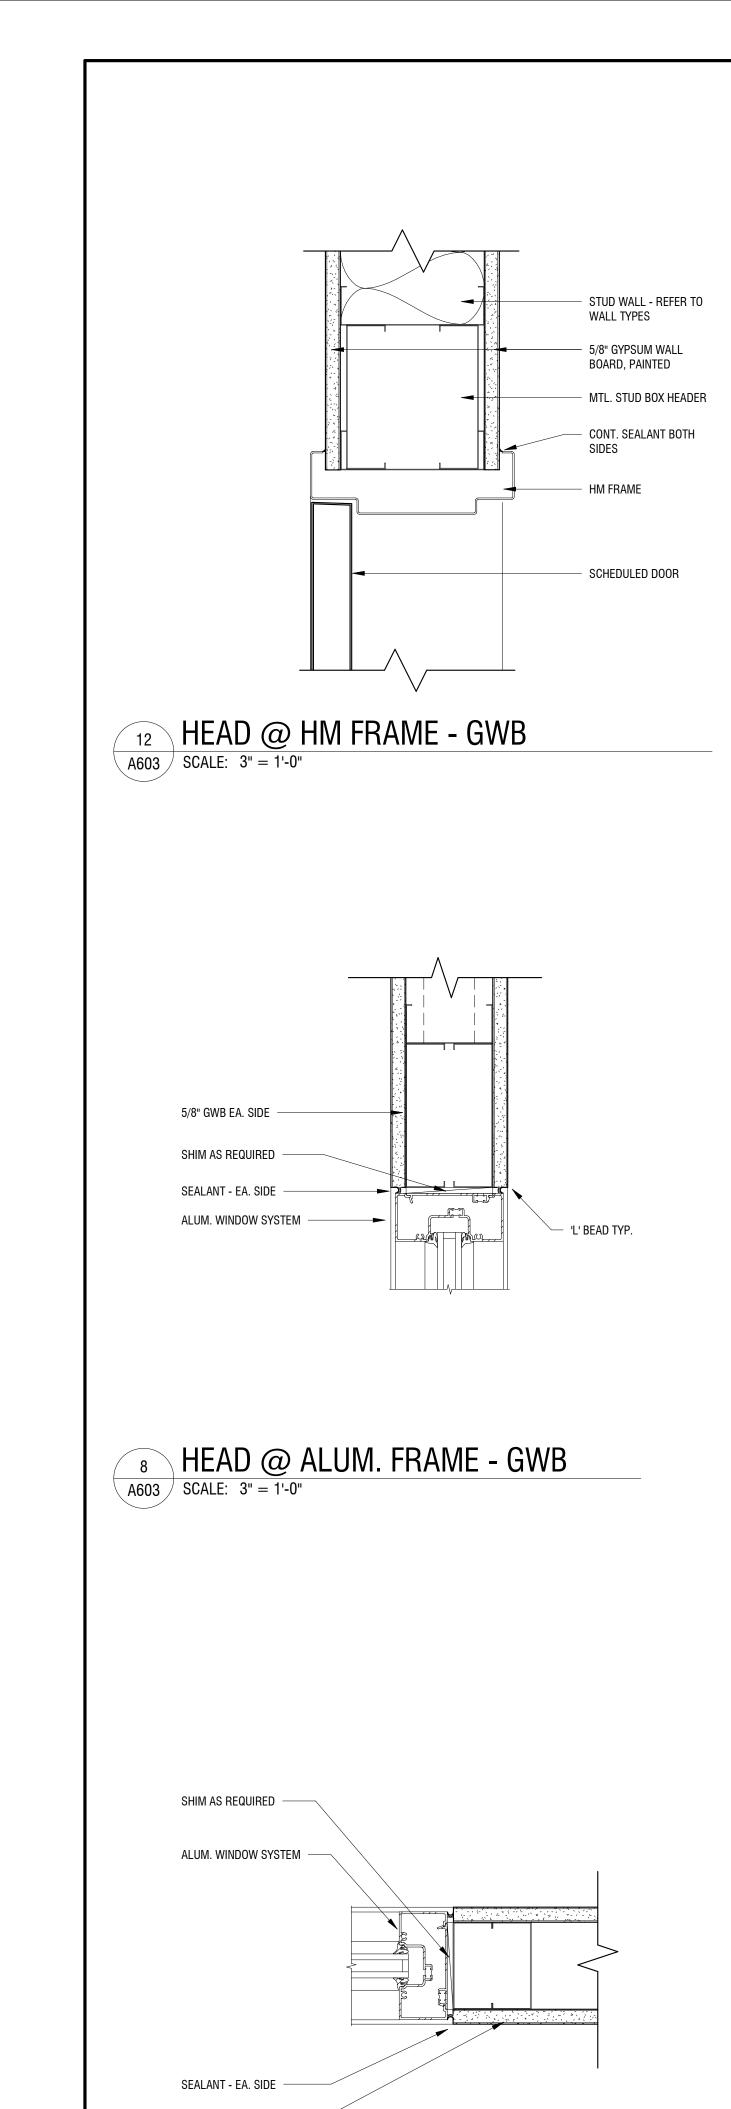


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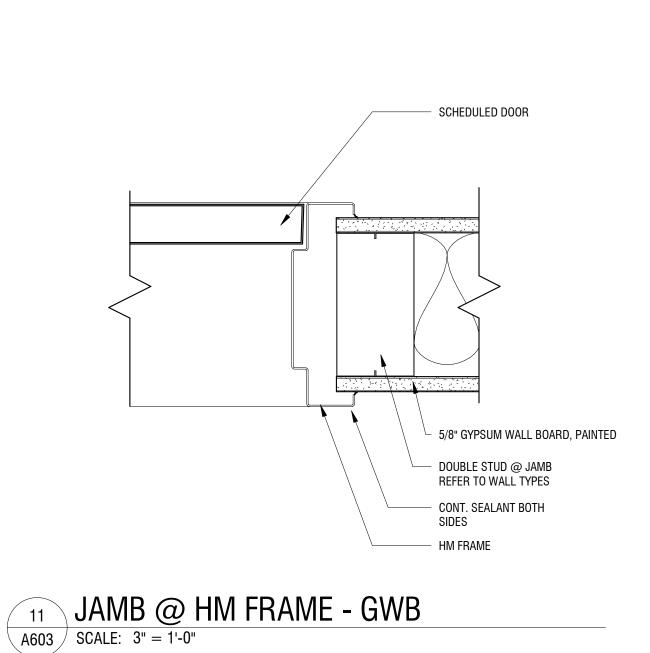
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Revisions			
PROJECT N	IUMBER:	2230150	
DRAWN BY	:	BAW	
REVIEWED	BY:	GGA	
ISSUED FO	R:	BID SET	
DATE:		08.23.2024	
DRAWING I	NAME:		


STOREFRONT TYPES

DRAWING NUMBER:




JAMB @ ALUM. FRAME - GWB




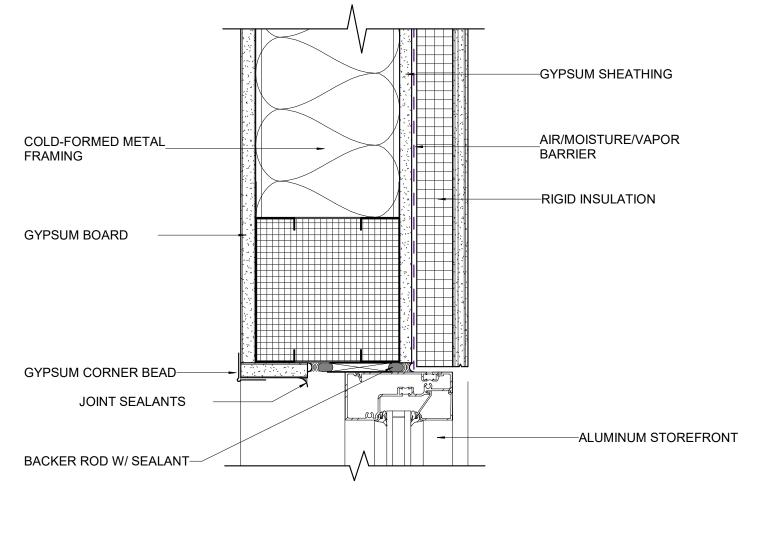

TYP. STOREFRONT HEAD DETAIL - EIFS

A603 | SCALE: 3" = 1'-0"

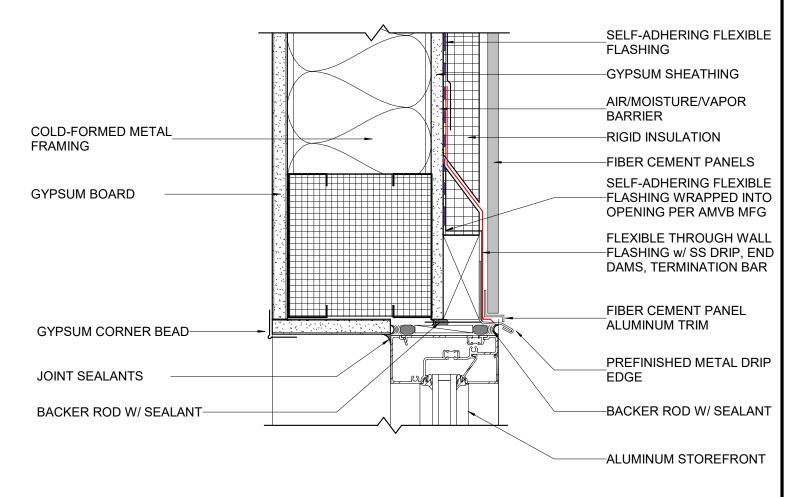

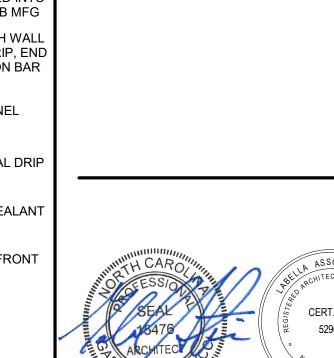

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9 TYP. STOREFRONT HEAD - FIBER CEMENT

A603 | SCALE: 3" = 1'-0"

A603 SCALE: 3" = 1'-0"


A603 SCALE: 3" = 1'-0"

—GYPSUM SHEATHING AIR/MOISTURE/VAPOR BARRIER COMPOSITE FRAMING SUPPORT SYSTEM SELF-ADHERING FLEXIBLE
—FLASHING WRAPPED INTO COLD-FORMED METAL FRAMING OPENING PER AMVB MFG -RIGID INSULATION GYPSUM BOARD FIBER CEMENT PANELS SHIM AS REQUIRED -WOOD BLOCKING FIBER CEMENT PANEL GYPSUM CORNER BEAD-ALUMINUM TRIM JOINT SEALANTS -BACKER ROD W/ SEALANT BACKER ROD W/ SEALANT-




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-ALUMINUM STOREFRONT 9521 Chapel Hill RD. Morrisville, NC 27560

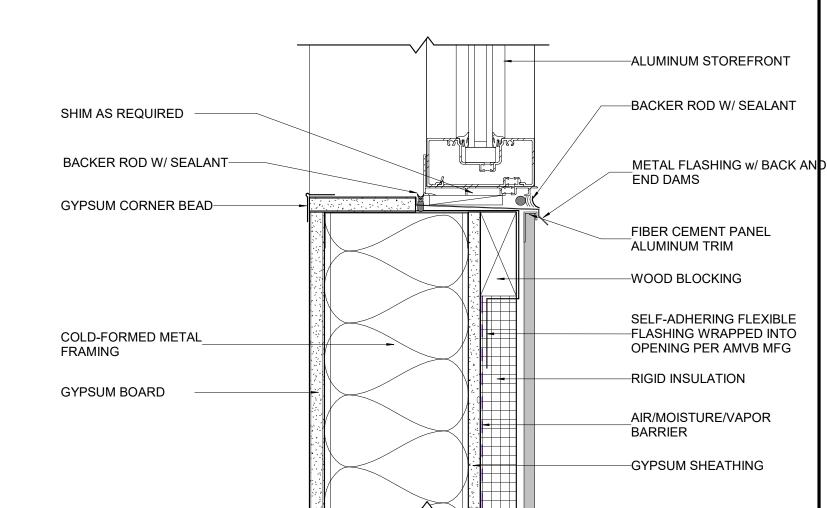

TYP. STOREFRONT JAMB - FIBER CEMENT


1 TYP. STOREFRONT SILL - FIBER CEMENT

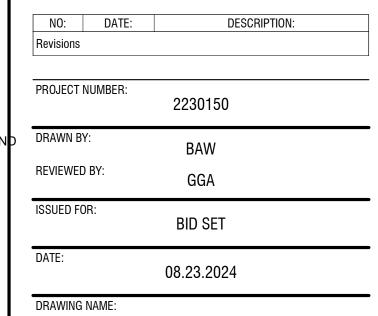

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STOREFRONT AND HM **DETAILS**

DRAWING NUMBER:

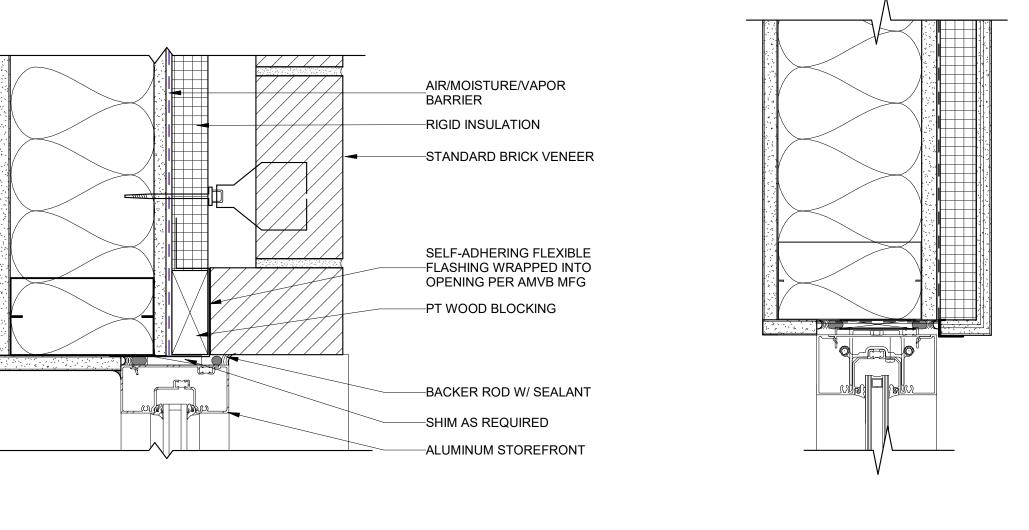



7 TYP. STOREFRONT JAMB - BRICK VENEER

3 TYP. STOREFRONT SILL @ BRICK VENEER

A603 SCALE: 3" = 1'-0"

6 TYP. STOREFRONT JAMB DETAIL- EIFS

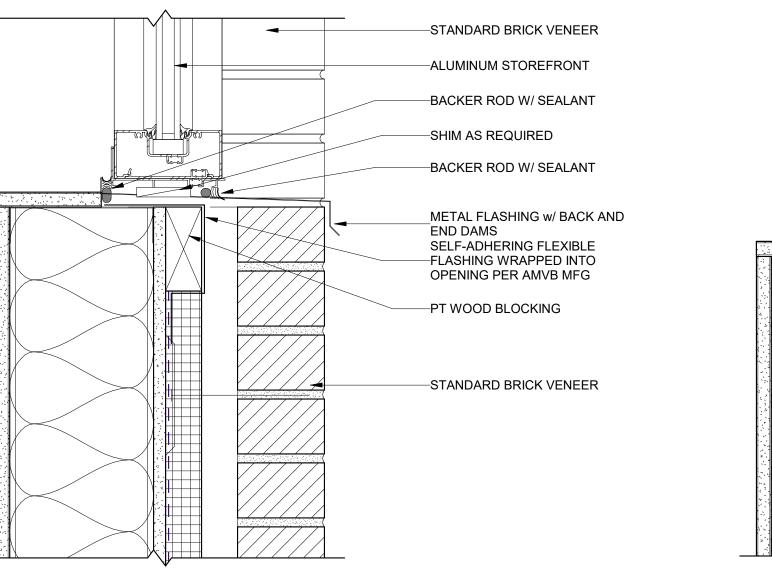


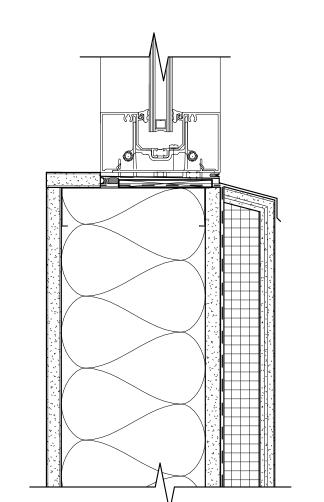


A603 | SCALE: 3" = 1'-0"

TYP. STOREFRONT SILL DETAIL- EIFS

CODE	MANUFACTURER	STYLE/PATTERN	COLOR	SIZE	ADDITIONAL REQUIREMENTS	REMARKS
COUSTIC CEIL	INC THE	-		•		
ACT-1	ARMSTRONG	CORTEGA TEGULAR 704	WHITE	24" x 24"	15/16" PRELUDE GRID, WHITE	FIELD
ACT-2	ARMSTRONG	ULTIMA HIGH NRC TEGULAR 1941	WHITE	24" x 24"	15/16" PRELUDE GRID, WHITE	OFFICES, MOTHER'S RM
7,012	7	CEMMATING PEGGETATION	W2	LI XLI	is, is Therebe and, with	3111020, III01112110 1IIII
ARPET	MOHAWK	LIMPTEEN DTEOA CWITCHCODE	DDAVO	0.411 -> 0.411	COORD FINAL DATTERN & LAVOUT W/ OWNER	MEDIUM CDAY FIELD
CPT-1 CPT-2	MOHAWK	UMPTEEN BT594 - SWITCHCODE UMPTEEN BT594 - SWITCHCODE	BRAVO ALPHA	24" x 24" 24" x 24"	COORD. FINAL PATTERN & LAYOUT W/ OWNER COORD. FINAL PATTERN & LAYOUT W/ OWNER	MEDIUM GRAY FIELD DARK GRAY FIELD
CPT-3	MOHAWK	UMPTEEN BT594 - SWITCHCODE	CHARLIE	24 x 24 24" x 24"	COORD. FINAL PATTERN & LAYOUT W/ OWNER	LIGHT GRAY FIELD
UP 1-3	WUTAWK	UMPTEEN B1394 - SWITCHCODE	UNANLIE	Z4 X Z4	COUND. FINAL PATTERN & LATOUT W/ OWNER	LIGHT GRAT FIELD
EILING BLADE				T 4::		
CB-1	ARMSTRONG	METALWORKS BLADES - CLASSICS	EFFECTS CLASSICS - CHERRY	4" x REFER 10 RC	P PROVIDE SHOP DRAWING LAYOUT FOR REVIEW	
ERAMIC/PORC	CELAIN TILE			_		
CT-1	DALTILE	VOLUME 1.0	STEREO GREY	12" x 24"	RUNNING BOND	LIGHT FLOOR TILE
CT-2	DALTILE	VOLUME 1.0	INTENSITY PEBBLE	12" x 24"	RUNNING BOND	DARK FLOOR TILE
POXY PAINT						
EPT-1	SHERWIN WILLIAMS	PRO INDUSTRIAL HIGH-PERFORMANCE EPOXY	ROMAN COLUMN SW7562	-		FIELD COLOR
IRF RFTARDAI	NT TREATED PLYWOOD					
FRT-1	-	SMOOTH FACE	-	3/4"	FULL WALL HEIGHT	
ROUT						
GRT-1	POLYBLEND	SANDED GROUT	CAPE GREY	-		FLOOR TILE CT-1
GRT-2	POLYBLEND	SANDED GROUT	WALNUT			FLOOR TILE CT-2
IGH PRESSUR HPL-1	E LAMINATE WILSONART	FINE GRAIN FINISH	ZANZIBAR - 7597k-78	-		CASEWORK
HPL-2	WILSONART	STANDARD HPL - MATTE FINISH	NAVY LEGACY - 4651-60			COUNTER (BREAK ROOM)
HPL-3	WILSONART	STANDARD HPL - MATTE FINISH	GRAPHITE NEBULA	-		BATHROOM VANITY
111 2 3	, messivari	57711571115111 E 1117111E 11111611	GIVII TITE NEBOLA			Dittinicon vinni
UXURY VINYL LVT-1	TILE ARMSTRONG	NATURAL CREATIONS	SILVER SUR	7" X 48"	PARALLEL 12	FIELD
LVII	Animornata	WHOTENE ONE MICHONO	OIL VEIT COIT	7 7 70	TAUALLE 12	TILLD
AINT	CHEDVAUNI VAULI LANGO	DDOMAD 200 7FDO VOC INTEDIOD DAINT	ODE ANALY CIAL 7040		FLAT	FIELD COLOD
PNT-1 PNT-2	SHERWIN WILLIAMS SHERWIN WILLIAMS	PROMAR 200 ZERO VOC INTERIOR PAINT PROMAR 200 ZERO VOC INTERIOR PAINT	CREAMY SW 7012 ANTIQUITY 6402	-	FLAT FLAT	FIELD COLOR ACCENT COLOR
PNT-3	SHERWIN WILLIAMS	PROMAR 200 ZERO VOC INTERIOR PAINT PROMAR 200 ZERO VOC INTERIOR PAINT	SERAPE 6656	-	FLAT	ACCENT COLOR
PNT-4	SHERWIN WILLIAMS	PROMAR 200 ZERO VOC INTERIOR PAINT	TBD BY OWNER	-	GLOSS	DOOR AND GLAZING TRIM
PNT-5	SHERWIN WILLIAMS	PROMAR 200 ZERO VOC INTERIOR PAINT	CEILING BRIGHT WHITE SW7007	-	FLAT	CEILING FIELD COLOR
	_					
SOLID SURFAC SS-1	E WILSONART	SOLID SURFACE	FROSTY WHITE MIRAGE			BATHROOM VANITY COUNTER
STAIN ST-1	MASONITE	FACTORY FINISHED STAIN ON NATURAL BIRCH	CANE		PROVIDE SAMPLE	WOOD DOORS
31-1	WASONITE	FACTORY FINISHED STAIN ON NATURAL BINOR	CANE		FNOVIDE SAWIFLE	พบบบ บบบกง
RANSITION ST		F 1991 991/425 229511 2 1 229 4	ETOLIED ALLINOVIO	F/0.0:	17F34 # 4000CC	400FNT11411 005115-1
TS-1 TS-2	POWERHOLD SCHLUTER	5/32" SQUARE PROFILE LVT904 SCHIENE	ETCHED ALUMINUM ANODIZED ALUMINUM	5/32'	ITEM #403263	ACCENT WALL CORNERS CT TO CPT TRANSITIONS
/ALL BASE						
RB-1	ROPPE	700 SERIES WALL BASE	123 CHARCOAL	4" HIGH		WALL BASE
VALL COVEDIN						
WC-1	SHAW CONTRACT	GRAIN + PIGMENT	HONEY, 64240			ACCENT WALLS
			113.12., 0.2.10	1		

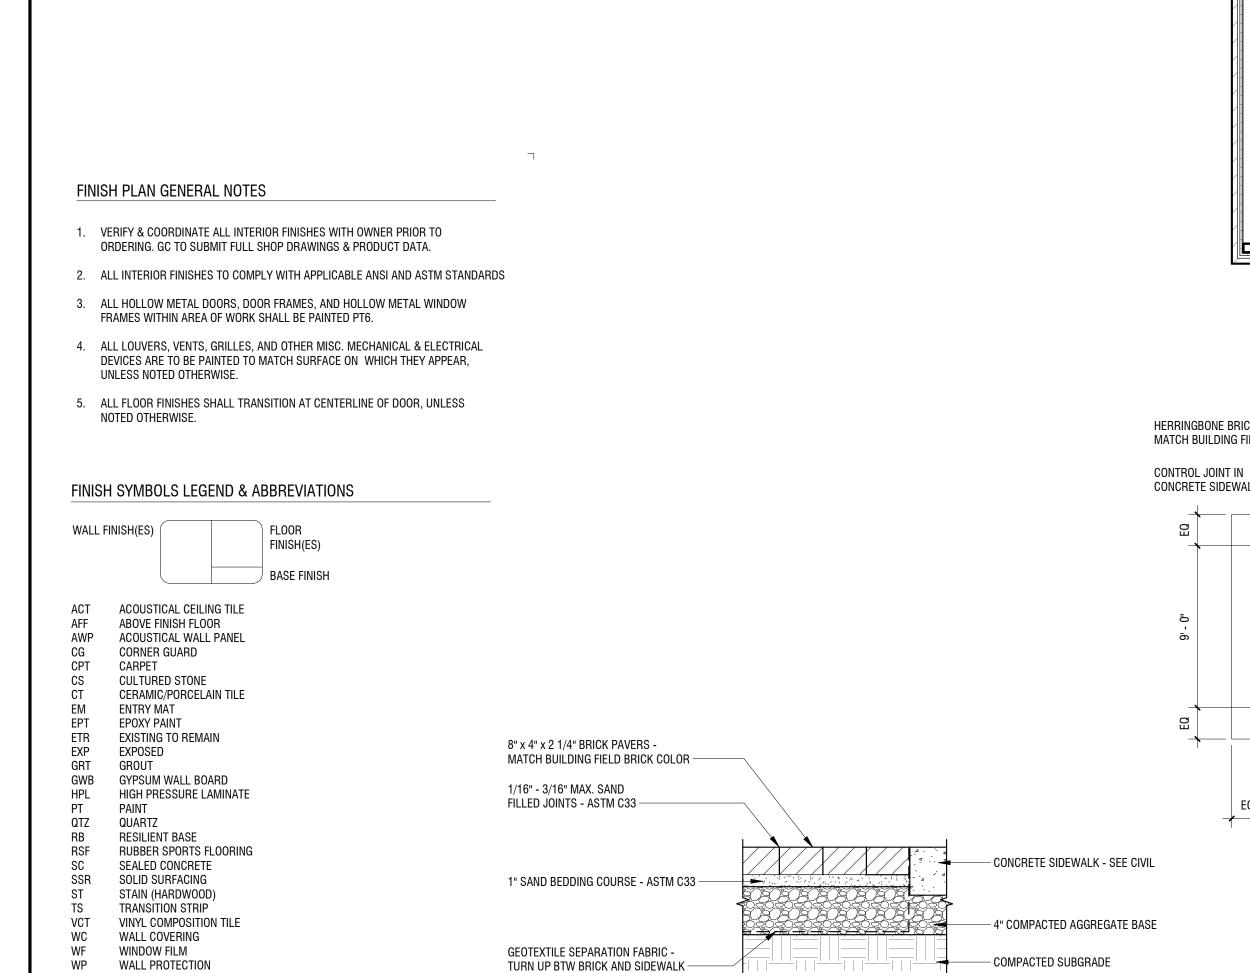

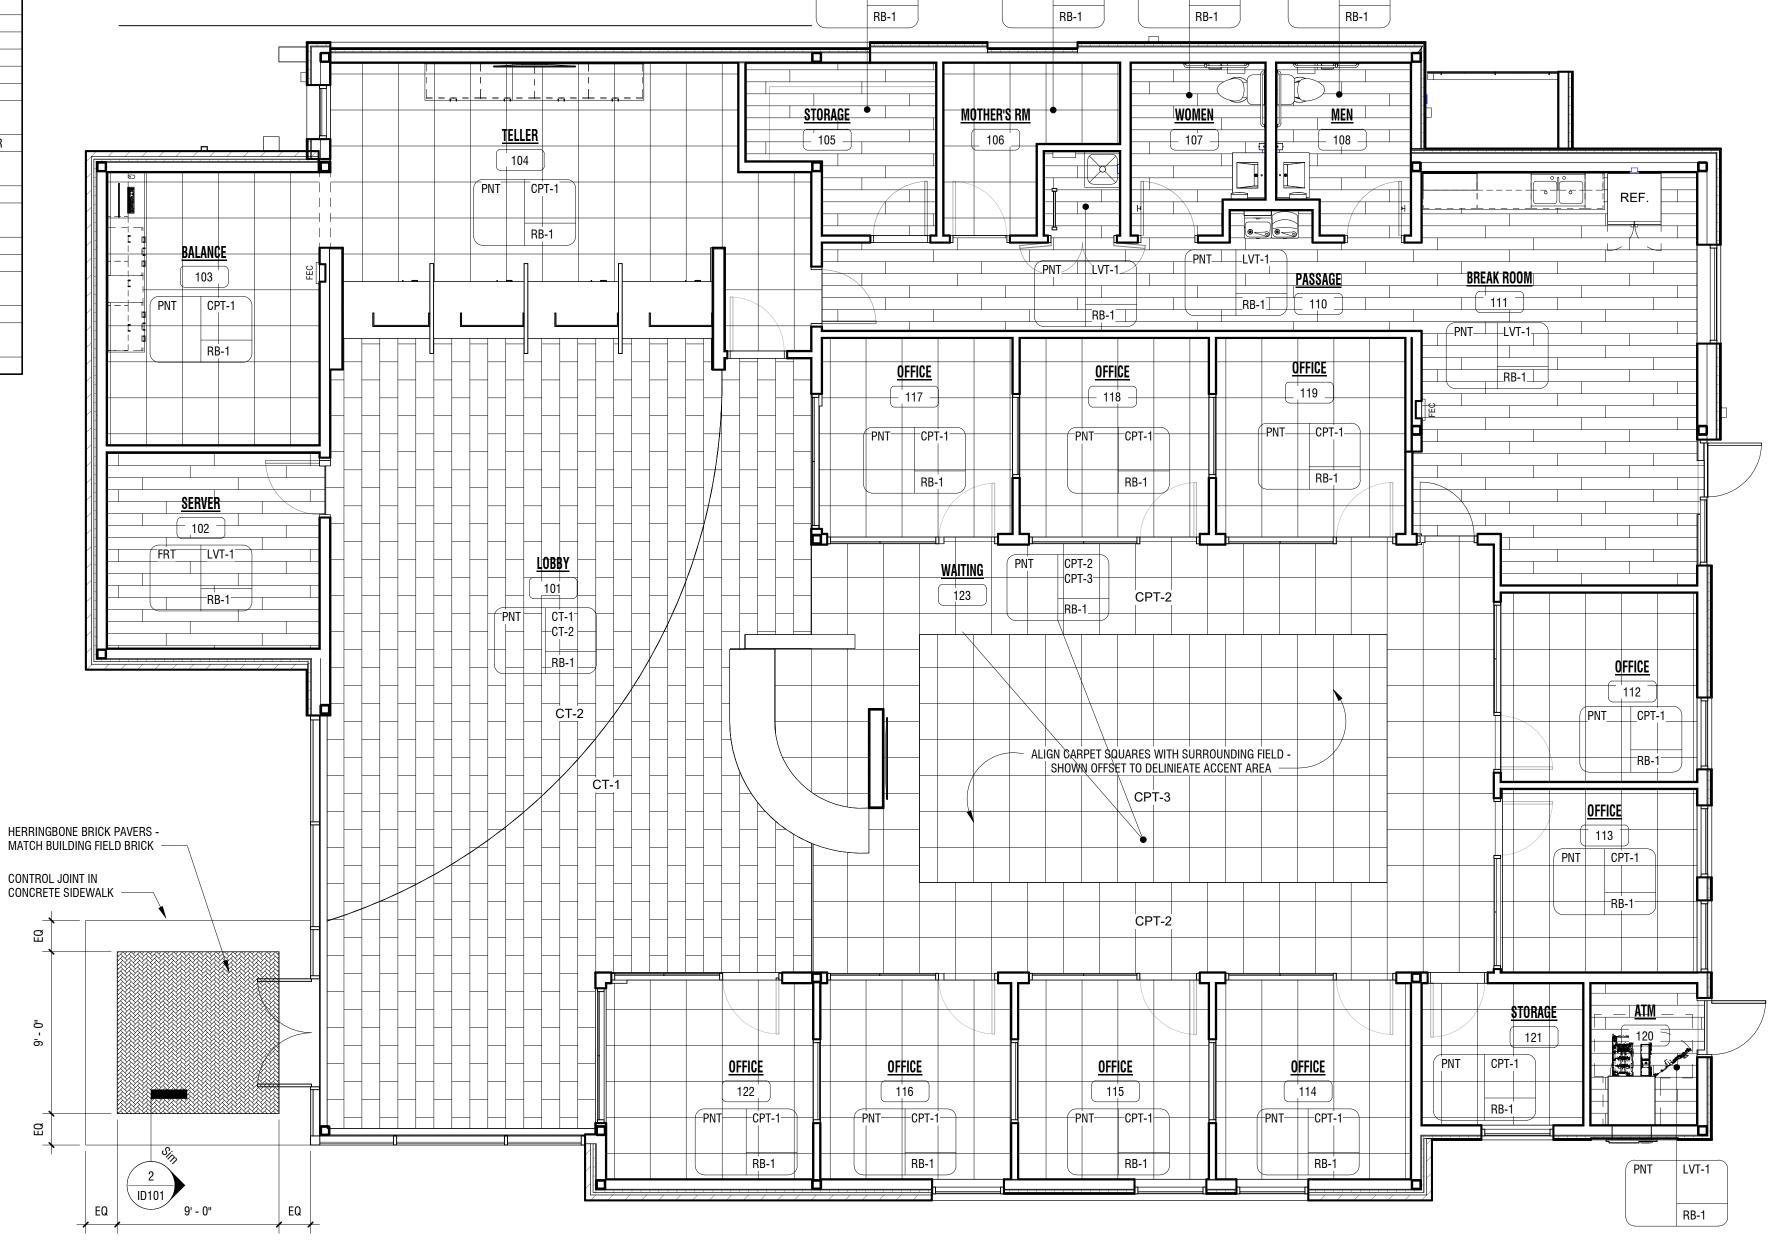

PNT LVT-1



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Revisions			
PROJECT	NUMBER:	2230150	
DRAWN B	Y:	BAW	
REVIEWED) BY:	GGA	
ISSUED FO	DR:	BID SET	
DATE:		08.23.2024	
DRAWING	NAME:		

FIRST FLOOR FINISH PLAN

DRAWING NUMBER:

ID101

1 FIRST FLOOR FINISH PLAN SCALE: 3/16" = 1'-0"

024 2:37:01 PM

WINDOW TREATMENT


ACCENT WALL FINISH DESIGNATION

EXTENTS OF WALL PROTECTION

² BRICK PAVER DETAIL

2 DNION FAVEN DETAIL

ID101 SCALE: 1 1/2" = 1'-0"

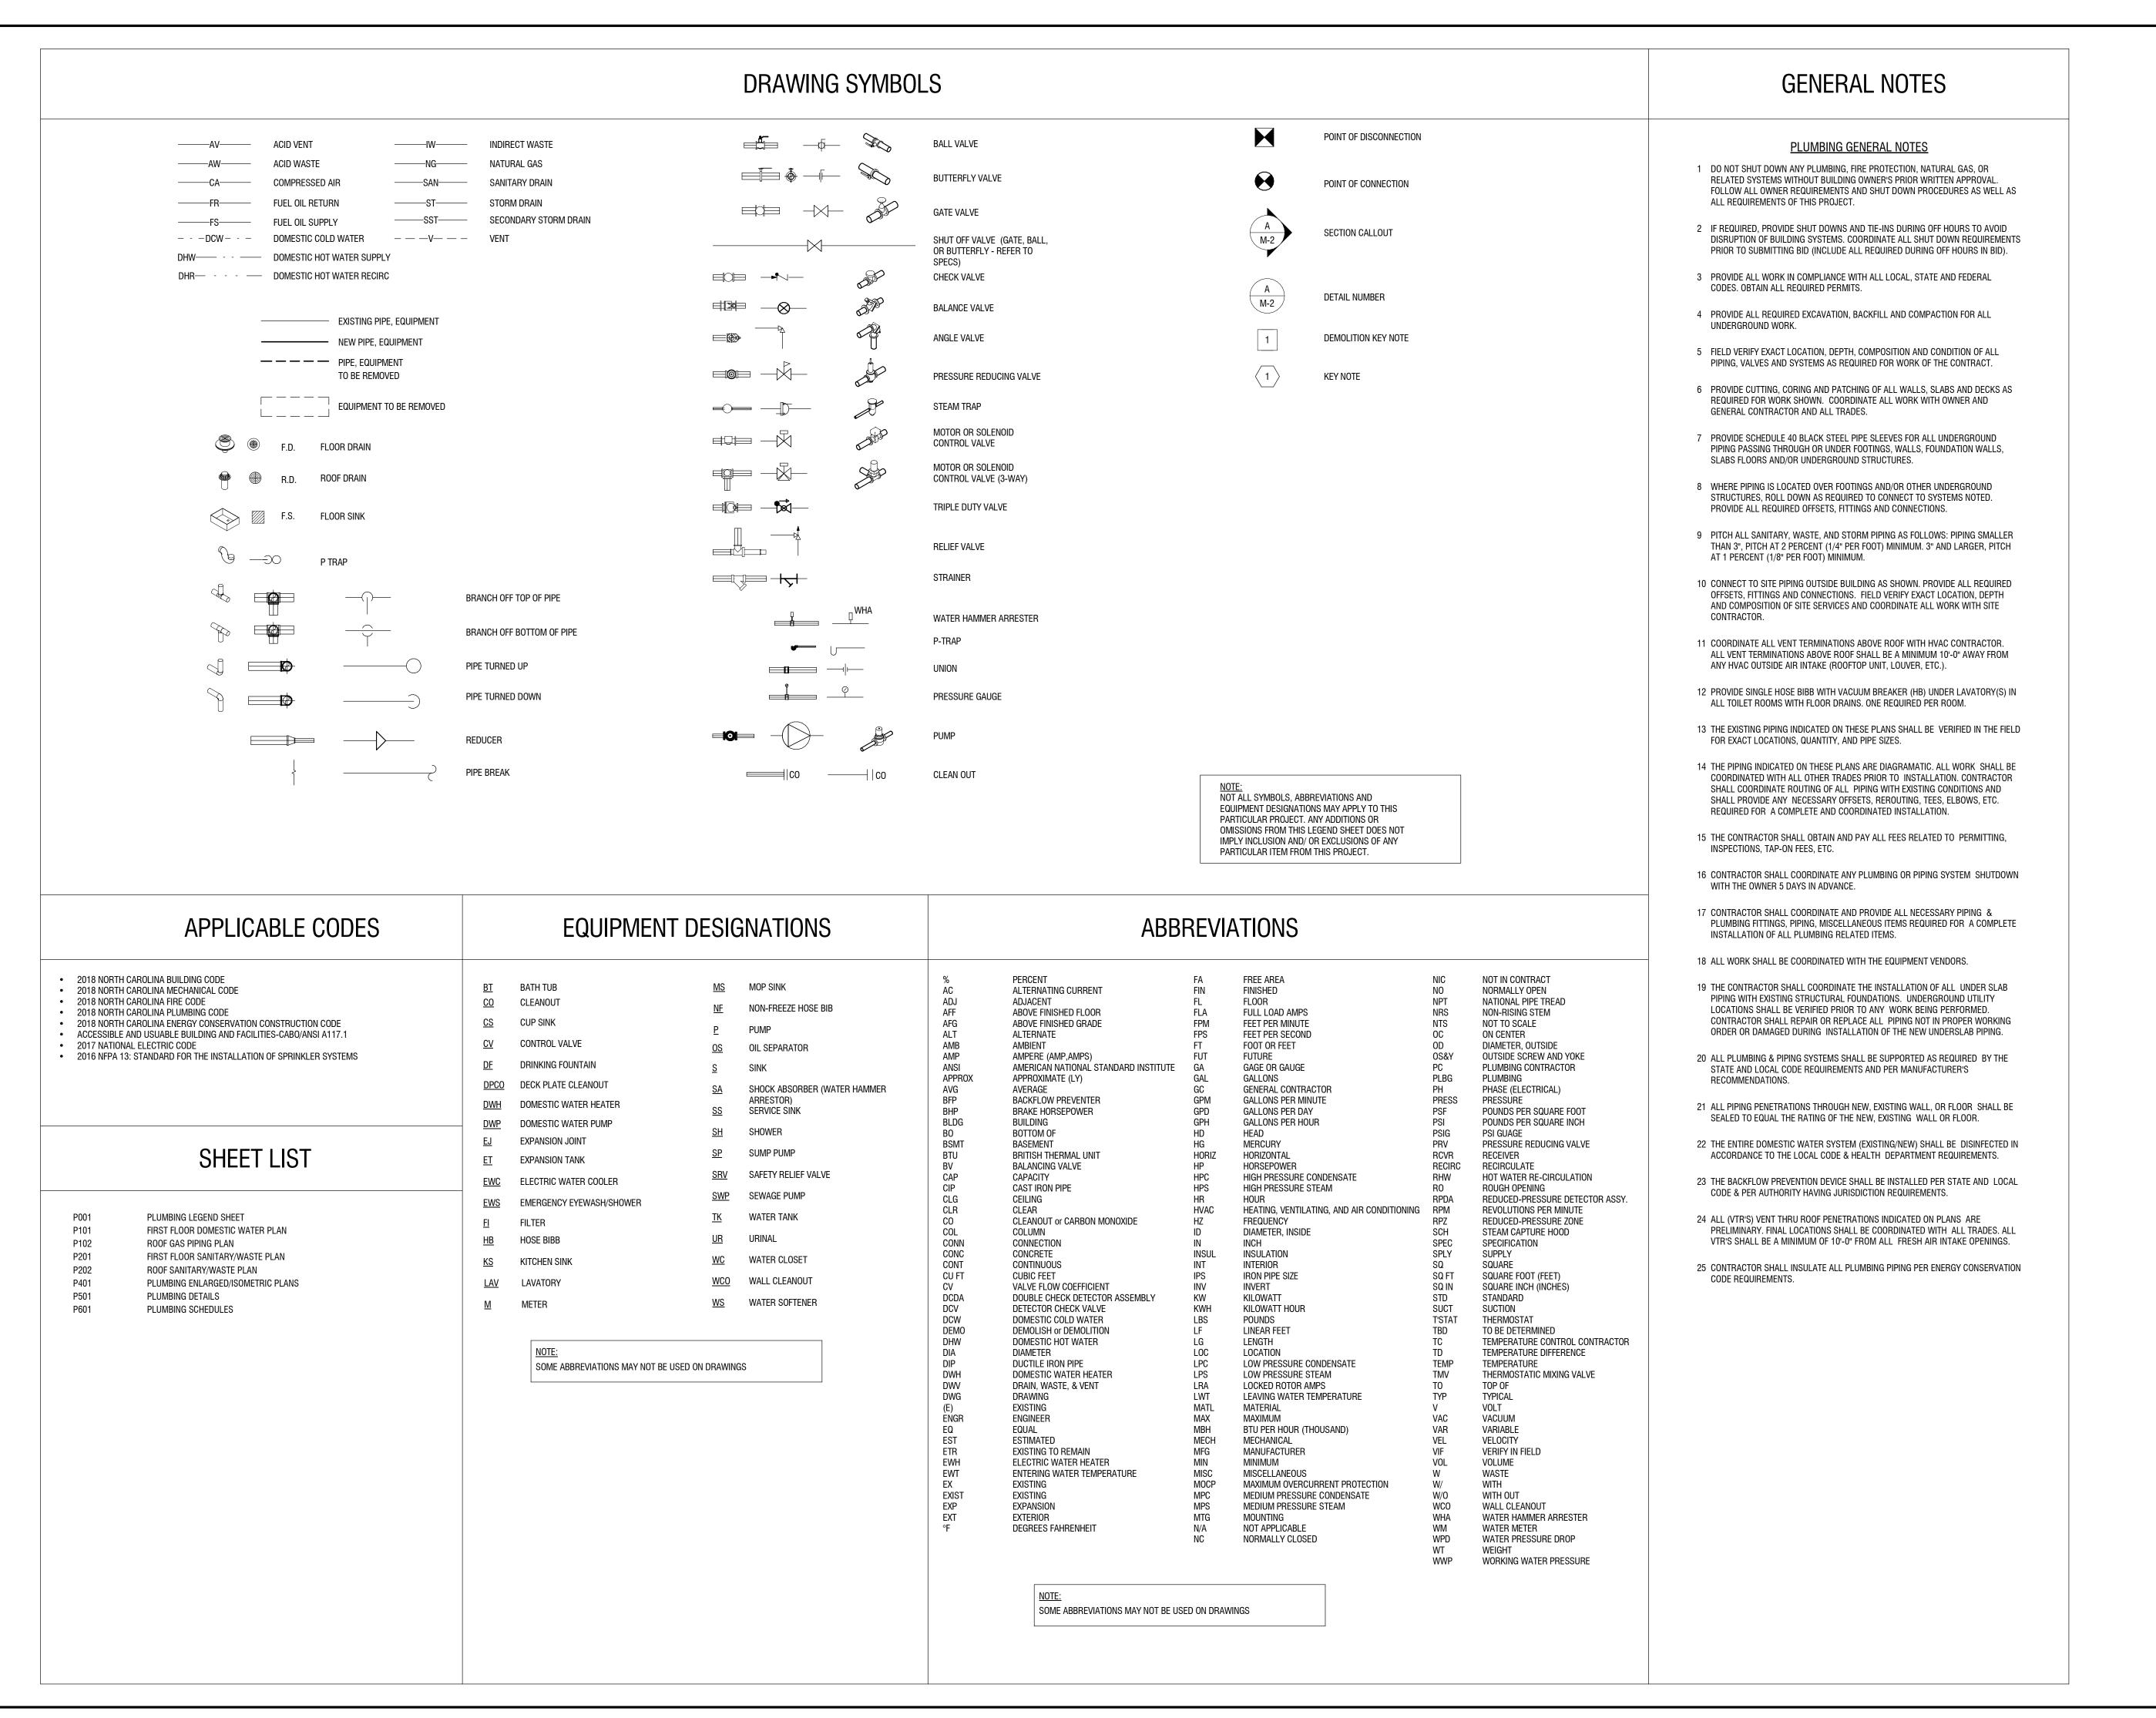

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CHARLOTTE

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NO: DATE: DESCRIPTION:

Revisions

PROJECT NUMBER: 2230150

DRAWN BY: MG / MM

REVIEWED BY: MG

ISSUED FOR: BID SET

DATE: 08.23.2024

PLUMBING LEGEND SHEET

DRAWING NUMBER:


DRAWING NAME:

GENERAL NOTES:

- SEE SHEET P601 FOR FIXTURE SCHEDULES & CONNECTION SIZES.
- 2. ALL WATER SUPPLY LINE IN AN EXTERIOR WALL SHALL BE RUN ON NITERIOR SIDE OF WALL INSULATION.
- 3. ALL DOMESTIC PIPING SHALL BE ROUTED IN CONCEALED LOCATIONS, WHERE POSSIBLE.
- 4. BEFORE BEGINNING WORK, VERIFY LOCATION OF ALL POINTS OF CONNECTION AND PIPE SIZES. NOTIFY ENGINEER IN ANY DISCREPANCIES.

KEY NOTES:


- SEE UTILITY PLAN FOR CONTINUATION OF DOMESTIC SERVICE MAIN ON SITE. COORDINATE SIZE, LOCATION AND ALL CONNECTION REQUIREMENTS, INCLUDING BACKFLOW PREVENTION WITH CIVIL.
- SEE UTILITY PLAN FOR CONTINUATION OF NATURAL GAS MAIN ON SITE. COORDINATE SIZE, LOCATION AND ALL CONNECTION REQUIREMENTS, INCLUDING GAS METER SIZING WITH UTILITY AND CIVIL.

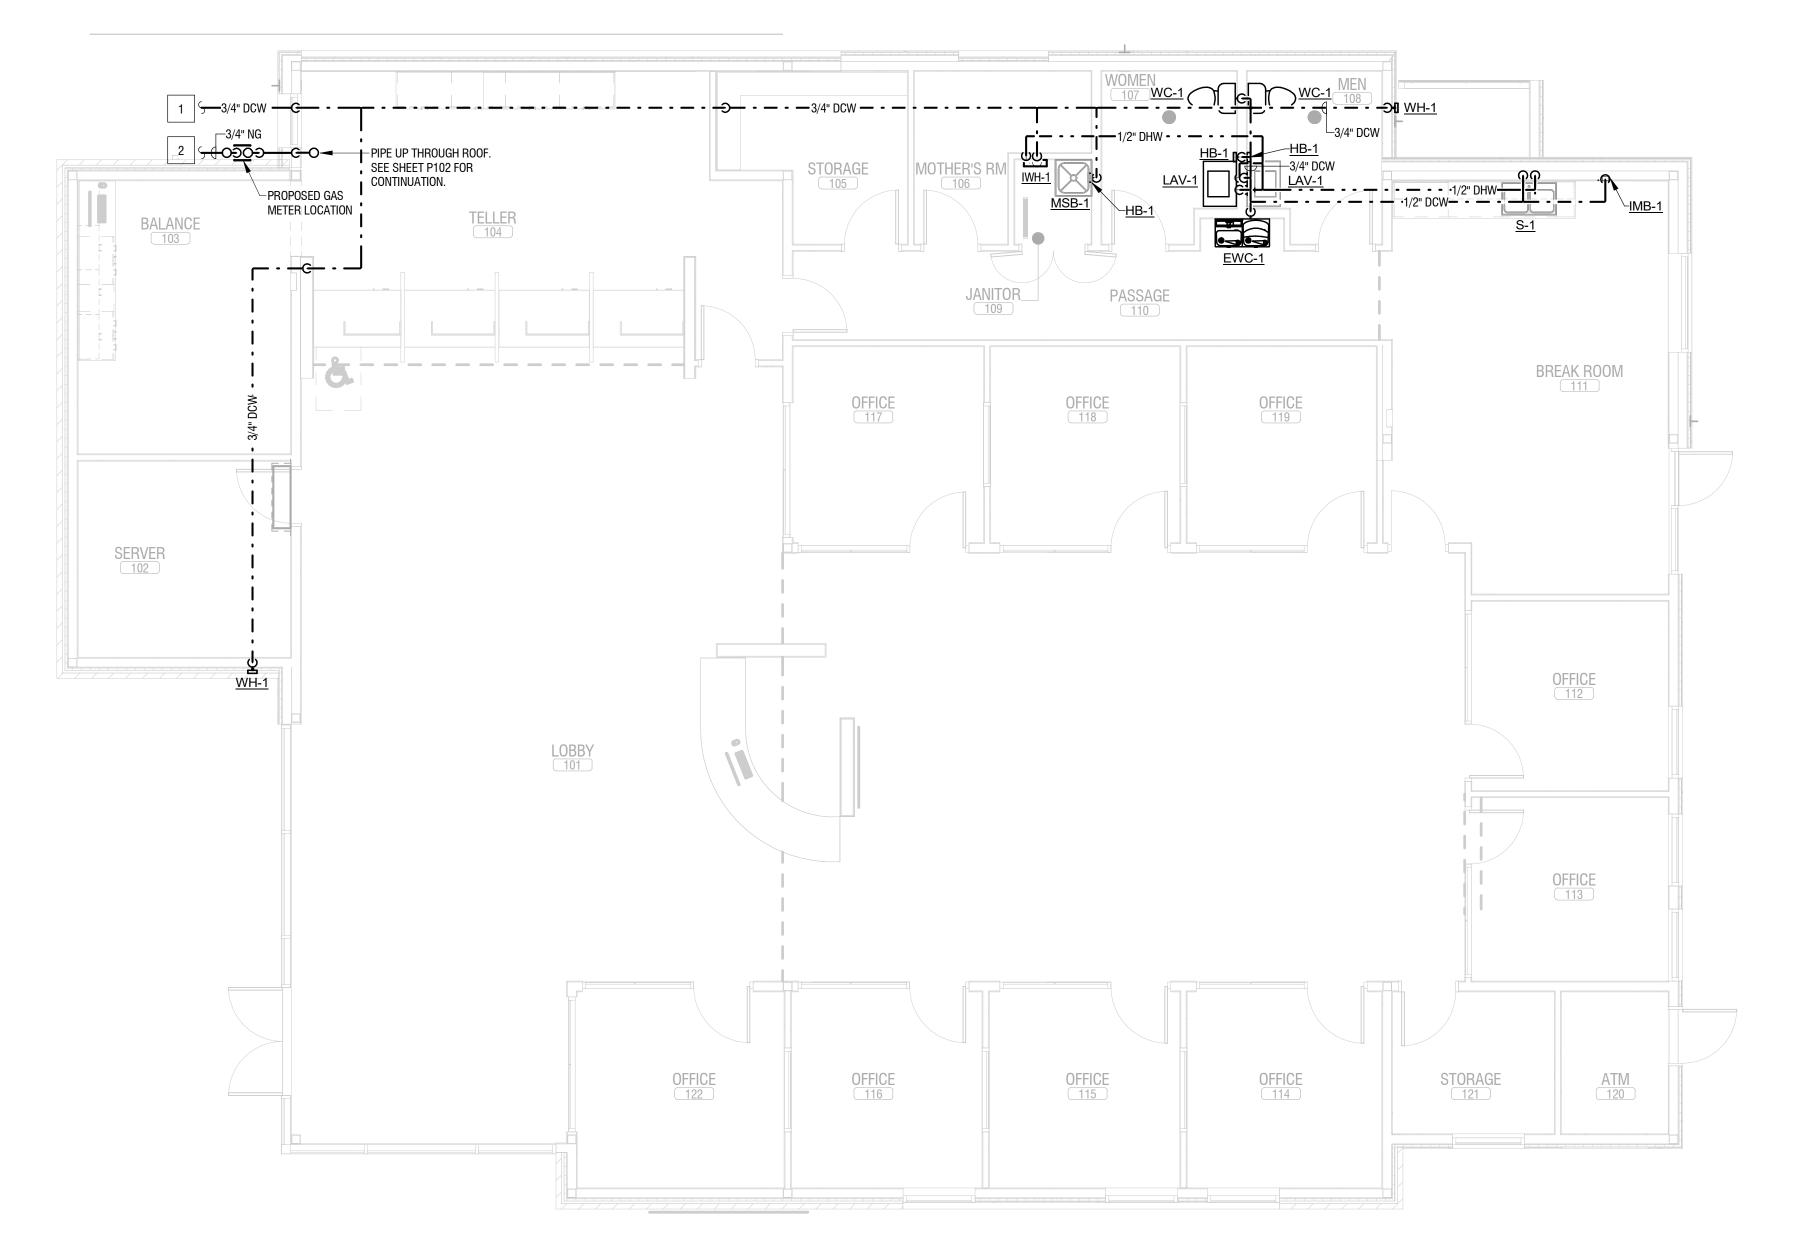

FIRST FLOOR DOMESTIC WATER PLAN
3/16" = 1'-0"



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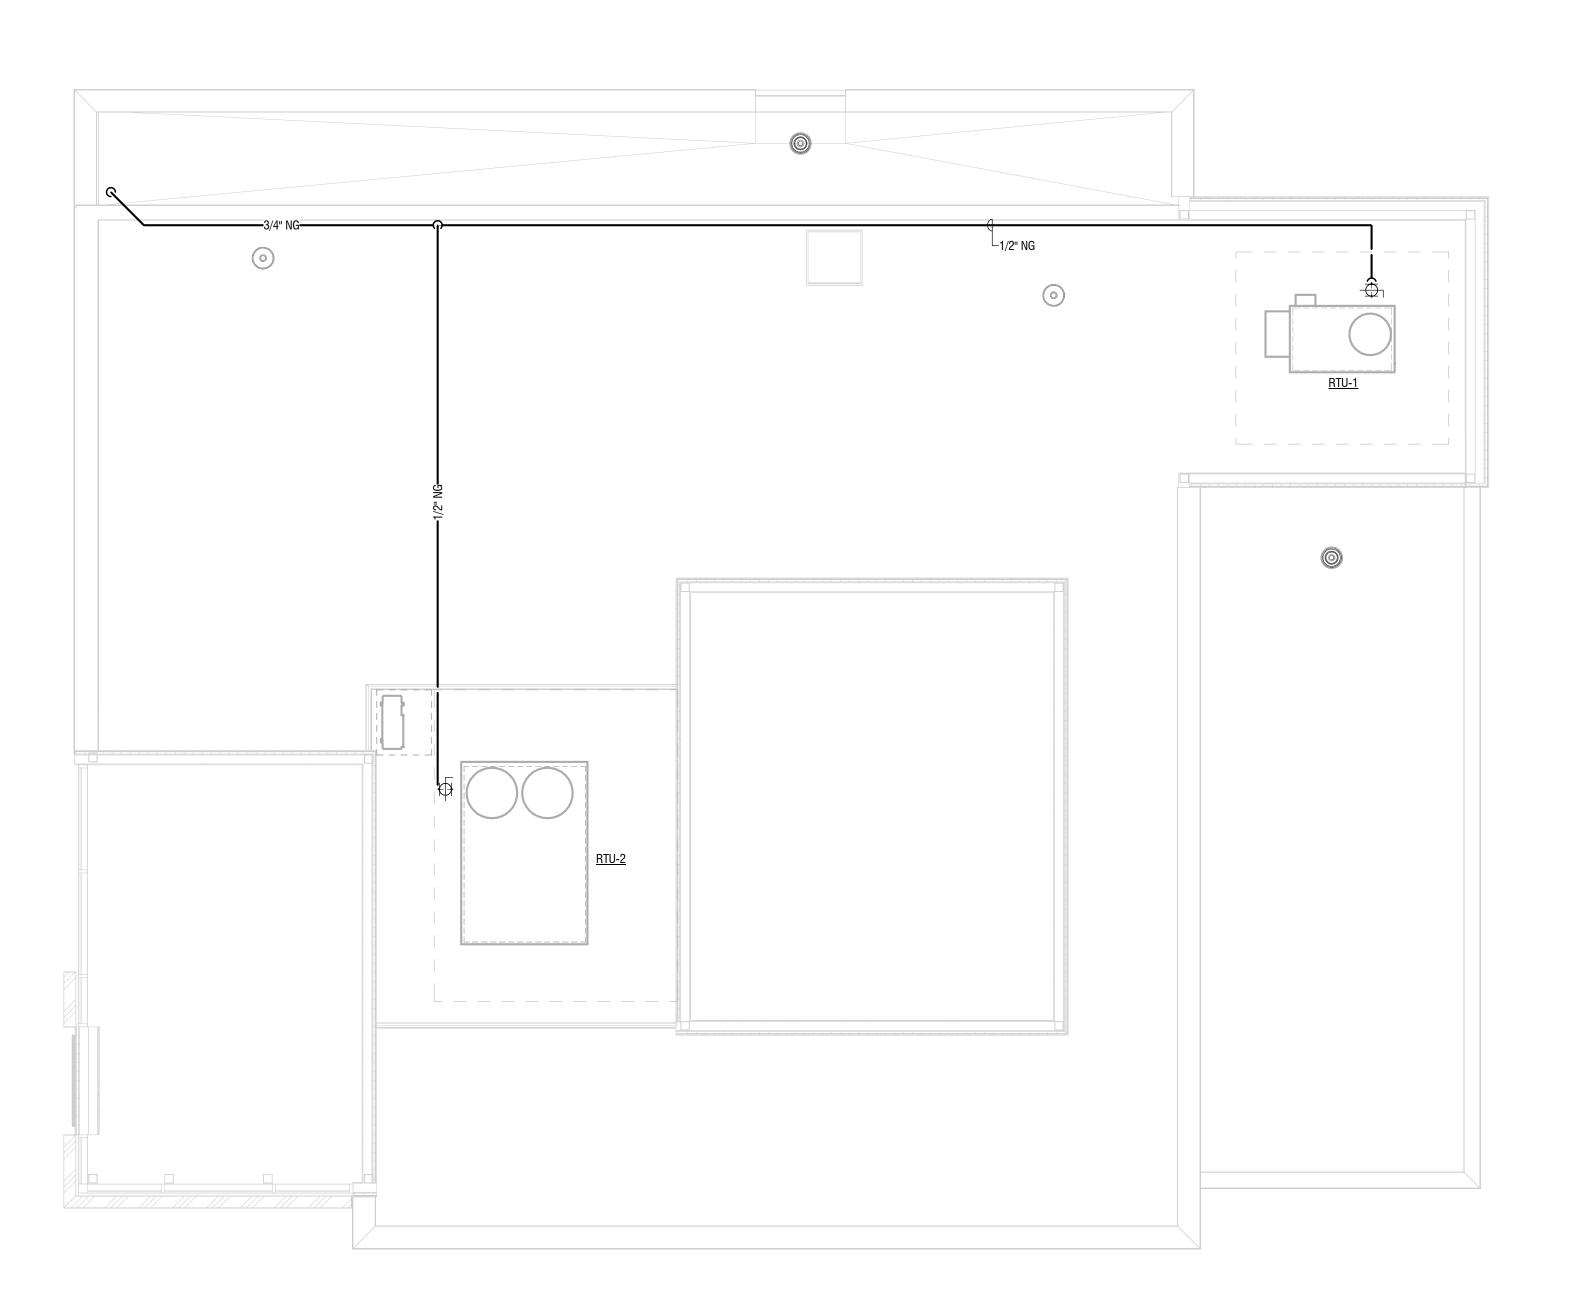

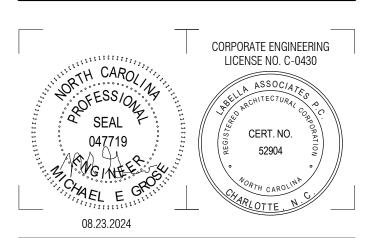
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DRAWING	NAME:		

FIRST FLOOR DOMESTIC WATER PLAN

DRAWING NUMBER:



1 ROOF GAS PIPING PLAN
P102 3/16" = 1'-0"

GAS PIPING NOTES:

- 1. WORK TO INCLUDE PIPING FROM GAS METER TO GAS FIRED EQUIPMENT. PLUMBING CONTRACTOR TO PROVIDE SHUT-OFF VALVE, DIRT TRAP AND PRESSURE REGULATOR AT THE GAS FIRED EQUIPMENT.
- 2. ALL WORK SHALL BE IN ACCORDANCE WITH ALL APPLICABLE LOCAL CODE REQUIREMENTS, AND THE PROVISIONS OF NFPA-54 AND NFPA-58.
- 3. THE CONTRACTOR SHALL SUPPLY ALL PERMITS, FEES AND LICENSES REQUIRED FOR THE WORK, AND FOR ALL INSPECTIONS REQUIRED.
- 4. PIPE 3" AND SMALLER SHALL BE SCHEDULE 40 STEEL WITH THREADED MALLEABLE FITTINGS.
- 5. VALVES SHALL BE GAS COCKS AND BE MANUFACTURED BY NIBCO. VALVES SHALL MEET TABLE 409.1.1 OF THE NCFGC AND BE RATED UP TO 2 PSIG PRESSURE PER TABLE.
- 6. ALL PIPING EXPOSED TO THE OUTDOORS OR RUN IN UNCONDITIONED SPACES SHALL BE PAINTED WITH TWO COATS OF RUST RESISTANT ENAMEL.
- 7. PRESSURE TEST PORTS MUST BE PROVIDED AT ALL MP REGULATORS IN ACCORDANCE TO NCFGC 410.2.
- 8. ALL SUPPORT OF GAS PIPING MUST COMPLY WITH NCFGC T.415.1.

GAS LOAD SUMMARY

LOW PRESSURE		HIGH PRESSURE	
PRESSURE DROP: 0).5 IN.W.C.	ATMOS. PRESSURI	E: 14.6954 PSIA
STEEL (SCHD. 40)		P1: 2 PSIG	
LENGTH: 131 FT		P2: 1 PSIG	
FITTING FACTOR: 10).4	STEEL (SCHD. 40)	
EQUIVALENT TOTAL	LENGTH: 142 FT	LENGTH: 131 FT	
CAPACITY OF PIPES	IN MBH	FITTING FACTOR: 1	0.4
1/2"	40	EQUIVALENT TOTA	L LENGTH: 142 FT
3/4"	83	CAPACITY OF PIPES	S IN MBH
1"	157	1/2"	372
1-1/4"	322	3/4"	751
1-1/2"	482		


NOTE:
• GAS PIPING IS SIZED FOR 2PSI NATURAL GAS. CONTRACTOR SHALL PROVIDE AN ALTERNATE BID FOR LOW PRESSURE PIPING IF HIGH PRESSURE IS NOT AVAILABLE. CONTRACTOR SHALL VERIFY THE AVAILABILITY OF 2PSI SERVICE BEFORE ANY WORK HAS BEGAN AND NOTIFY ARCHITECT IN WRITING OF AVAILABLE SERVICE.

 PROVIDE GAS REGULATOR AT EACH PIECE OF GAS-FIRED EQUIPMENT TO PROVIDE PRESSURE TO UNIT AS REQUIRED BY MANUFACTURER.

EQUIP DESIG.	FUFI INPL
RTU-1	100.0 MB
RTU-2	350.0 MBI
TOTAL	450.0 MB



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ISSUED FO	R:	BID SET	
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ROOF GAS PIPING PLAN

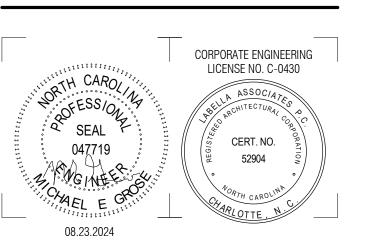
DRAWING NUMBER:

GENERAL NOTES:

- SEE SHEET P601 FOR FIXTURE SCHEDULES & CONNECTION SIZES.
- 2. MINIMUM SIZE FOR SANITARY WASTE AND VENT PIPING SHALL BE 1-1/2". PROVIDE MINIMUM 2" SANITARY BELOW SLAB.
- 3. ALL SANITARY VENT PIPING SHALL BE RUN AS HIGH AS POSSIBLE.
- 4. BEFORE BEGINNING WORK, VERIFY LOCATIONS OF ALL POINTS OF CONNECTION, PIPE SIZES, AND INVERTS. NOTIFY ENGINEER OF ANY DISCREPANCIES.

KEY NOTES:


- SEE UTILITY PLAN FOR CONTINUATION OF SANITARY
 SEWER ON SITE. COORDINATE INVERT ELEVATION WITH
 SITE UTILITY CONTRACTOR.
- 2 SEE UTILITY PLAN FOR CONTINUATION OF STORM WATER ON SITE. COORDINATE INVERT ELEVATION WITH SITE UTILITY CONTRACTOR.

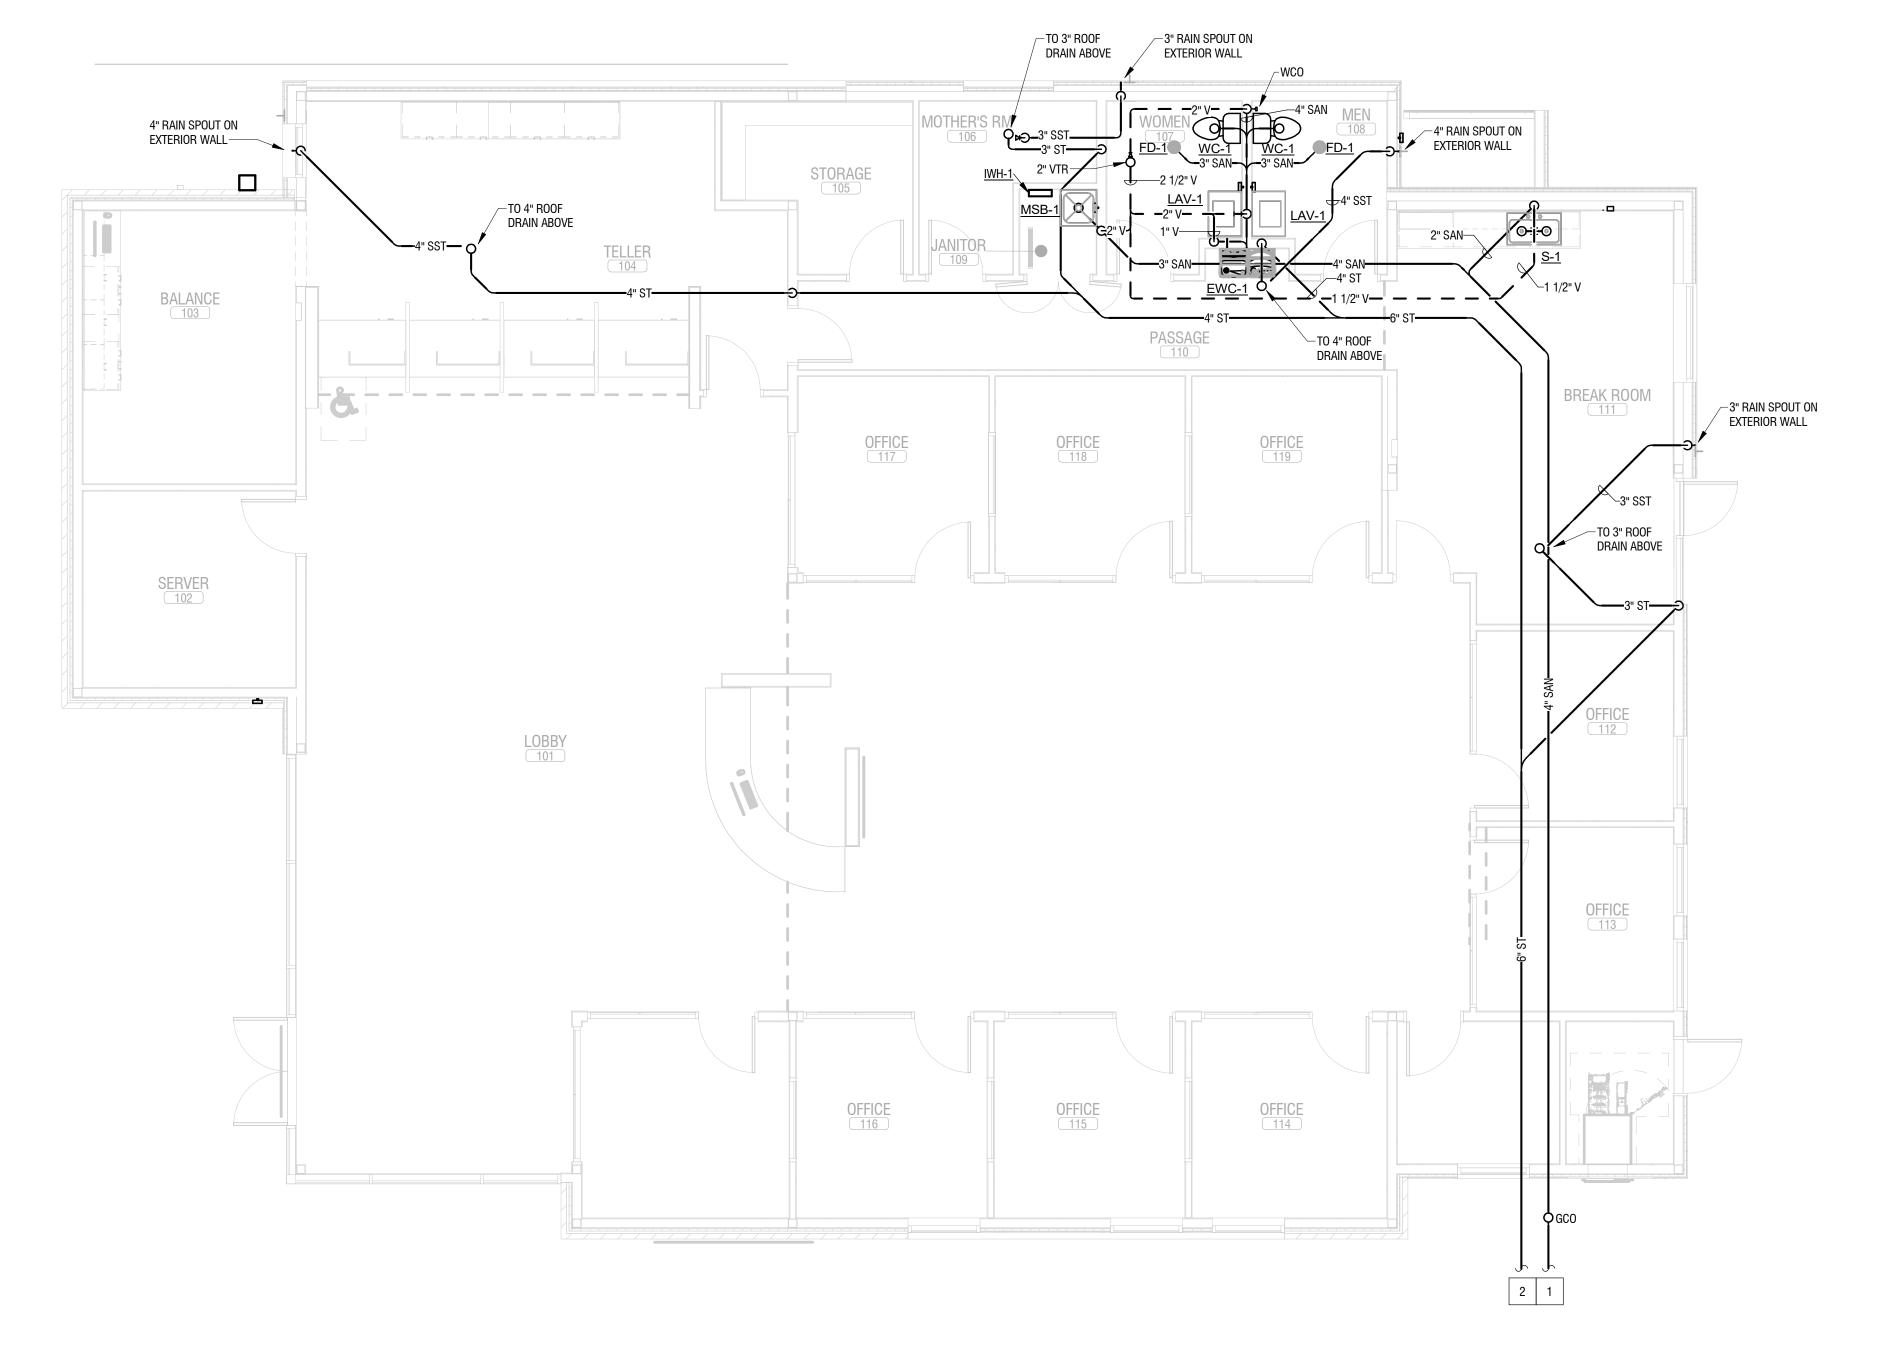

1 FIRST FLOOR SANITARY/WASTE PLAN
P201 3/16" = 1'-0"



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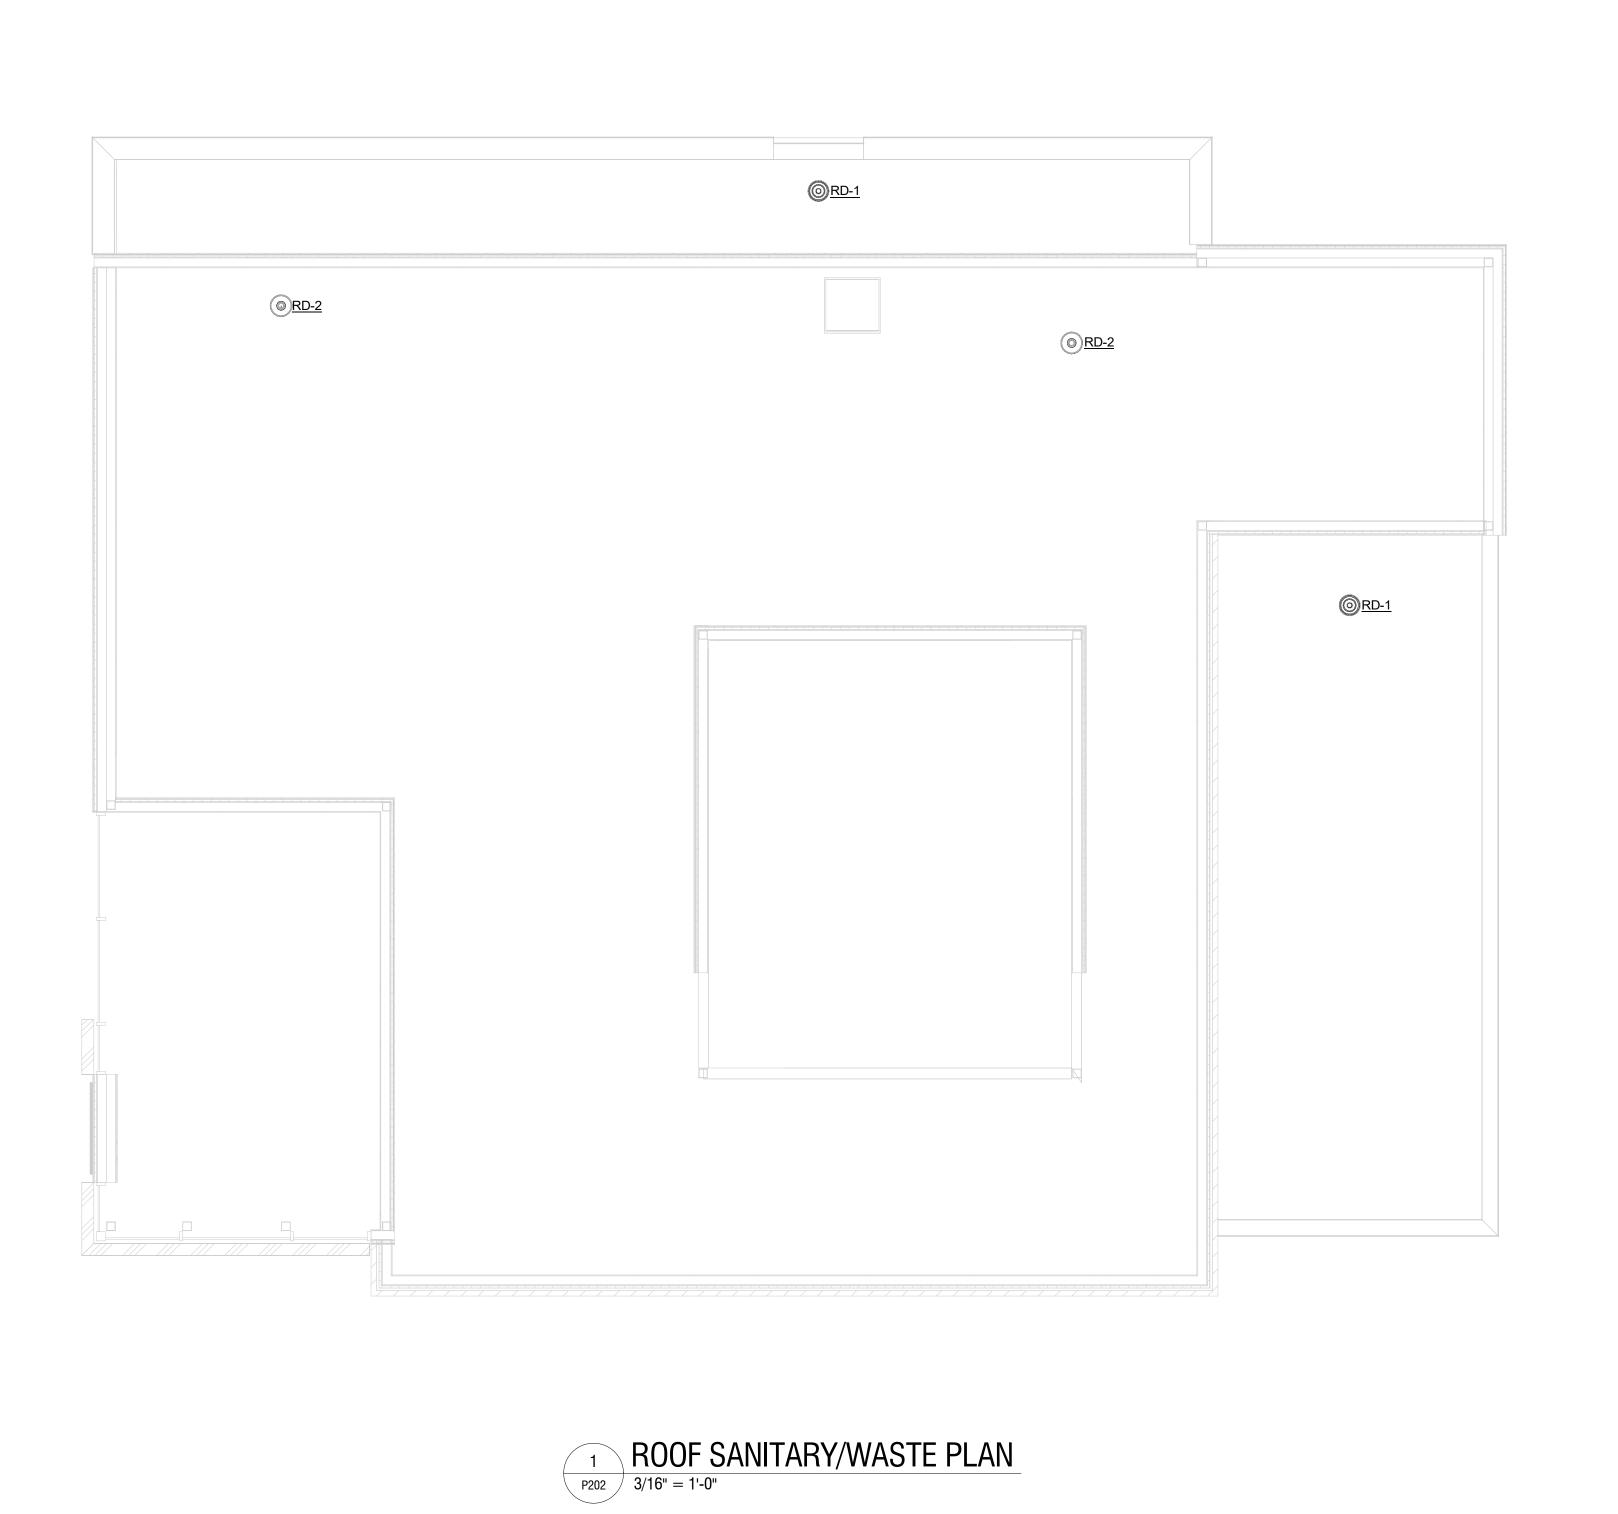

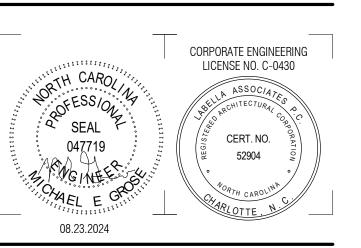
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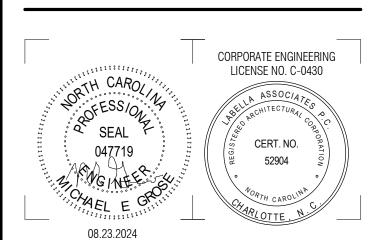
Revisions PROJECT NUMBER:	
PROJECT NUMBER:	
	2230150
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FIRST FLOOR SANITARY/WASTE PLAN

DRAWING NUMBER:







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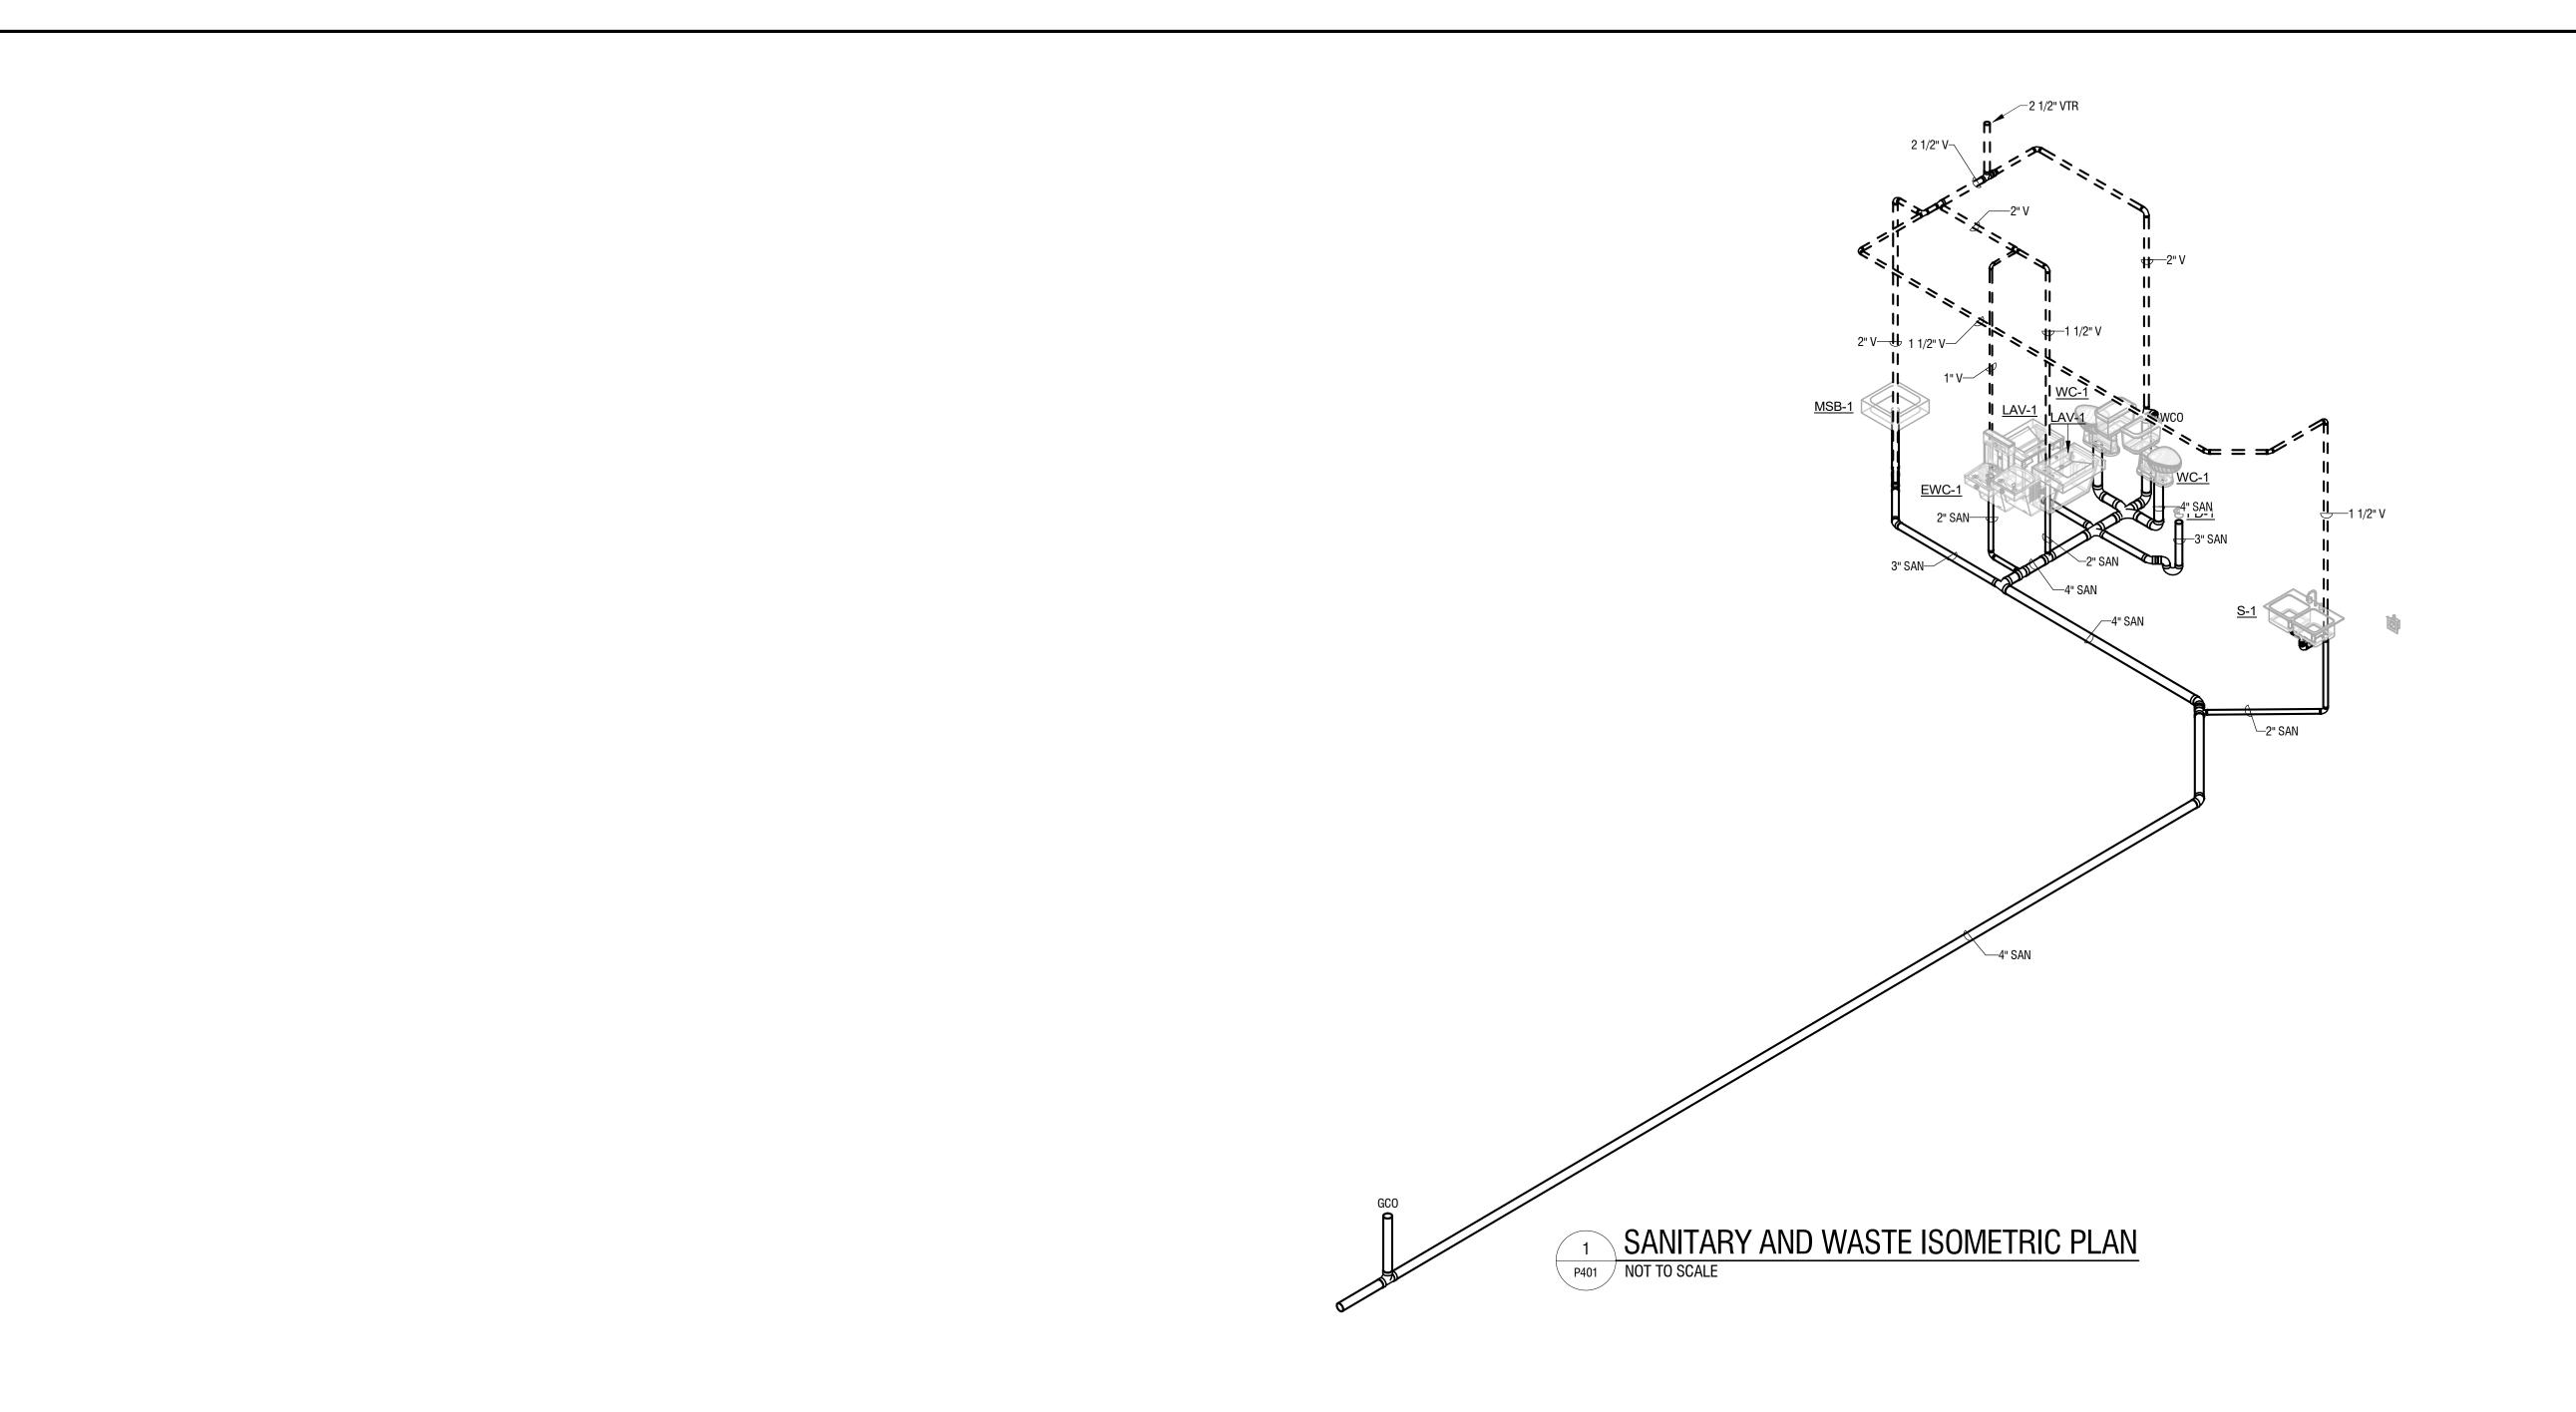
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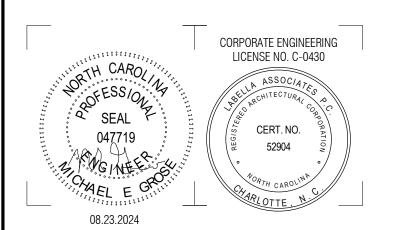
DRAWING NAME:

ROOF SANITARY/WASTE

DRAWING NUMBER:







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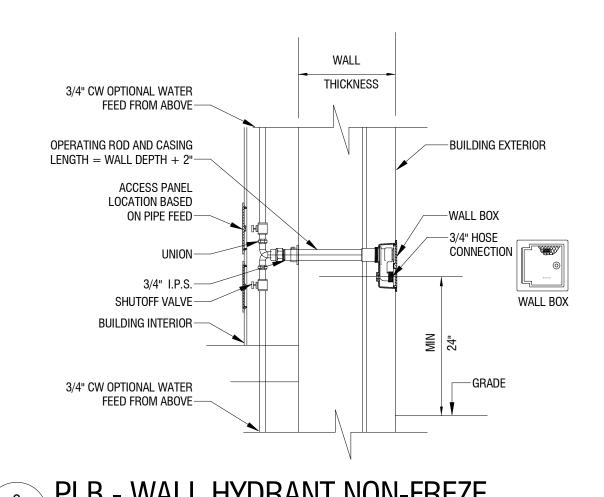
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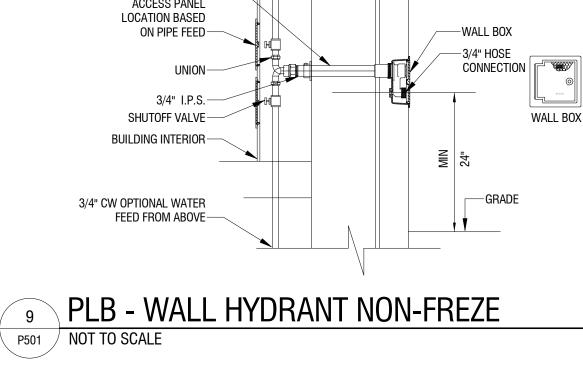
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DRAWING NAME:

PLUMBING ENLARGED/ISOMETRIC PLANS

DRAWING NUMBER:





MIN.

8 PLB - VENT THROUGH ROOF

ROOF DECK


SEALANT-

CLAMP-

FLASHING-

P501 NOT TO SCALE

STAINLESS STEEL

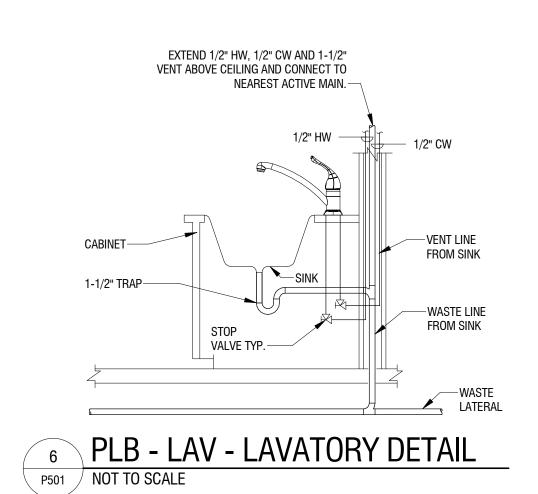

WALL—►

1/2" HW -

LAVATORY SUPPORT FOR CONCEALED ARM-

LAVATORY

1 1/2" -

VALVE TYP.-

P-TRAP W/CO-

FL00R—


CONNECT WASTE PIPING TO

ST0P


CONNECT VENT SYSTEM ABOVE CEILING

— 1 1/2"

1 1/2"

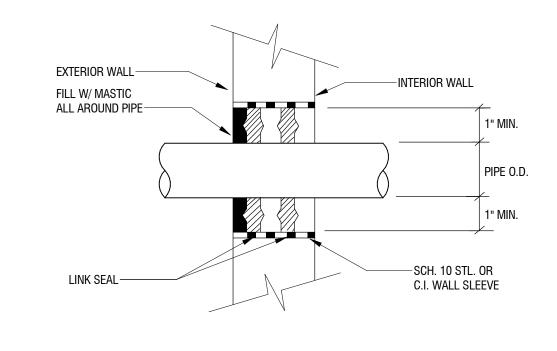

PLB - EXTERIOR/FOUNDATION WALL SLEEVE DETAIL P501 NOT TO SCALE

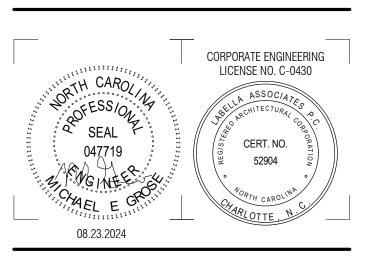

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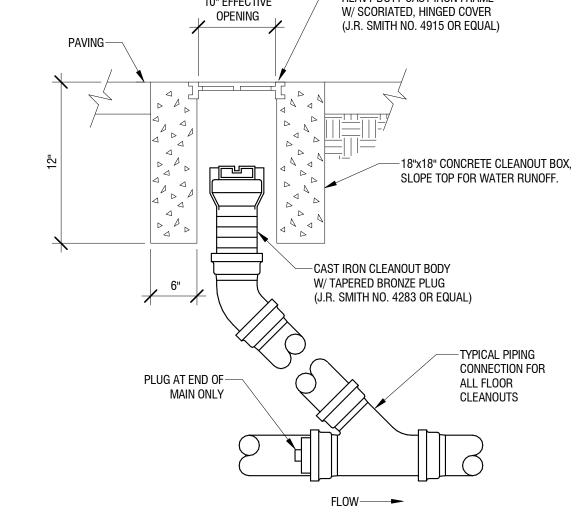
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- HEAVY DUTY CAST IRON FRAME 10" EFFECTIVE W/ SCORIATED, HINGED COVER OPENING (J.R. SMITH NO. 4915 OR EQUAL) PAVING: SLOPE TOP FOR WATER RUNOFF. -CAST IRON CLEANOUT BODY W/ TAPERED BRONZE PLUG (J.R. SMITH NO. 4283 OR EQUAL) TYPICAL PIPING CONNECTION FOR PLUG AT END OF— MAIN ONLY ALL FLOOR CLEANOUTS






PLB - CO - EXTERIOR CLEANOUT DETAIL P501 NOT TO SCALE

- FINISHED FLOOR OR PAVED AREA.

CLEANOUT ACCESS COVER (DPCO)-

P501 NOT TO SCALE


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PLUMBING DETAILS

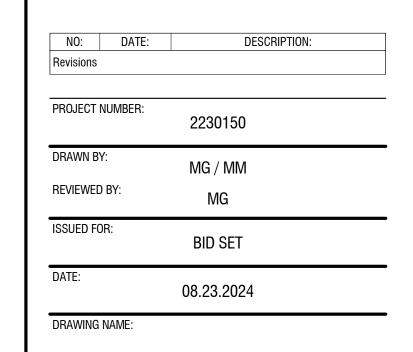DRAWING NUMBER:

P501



-WATER CLOSET

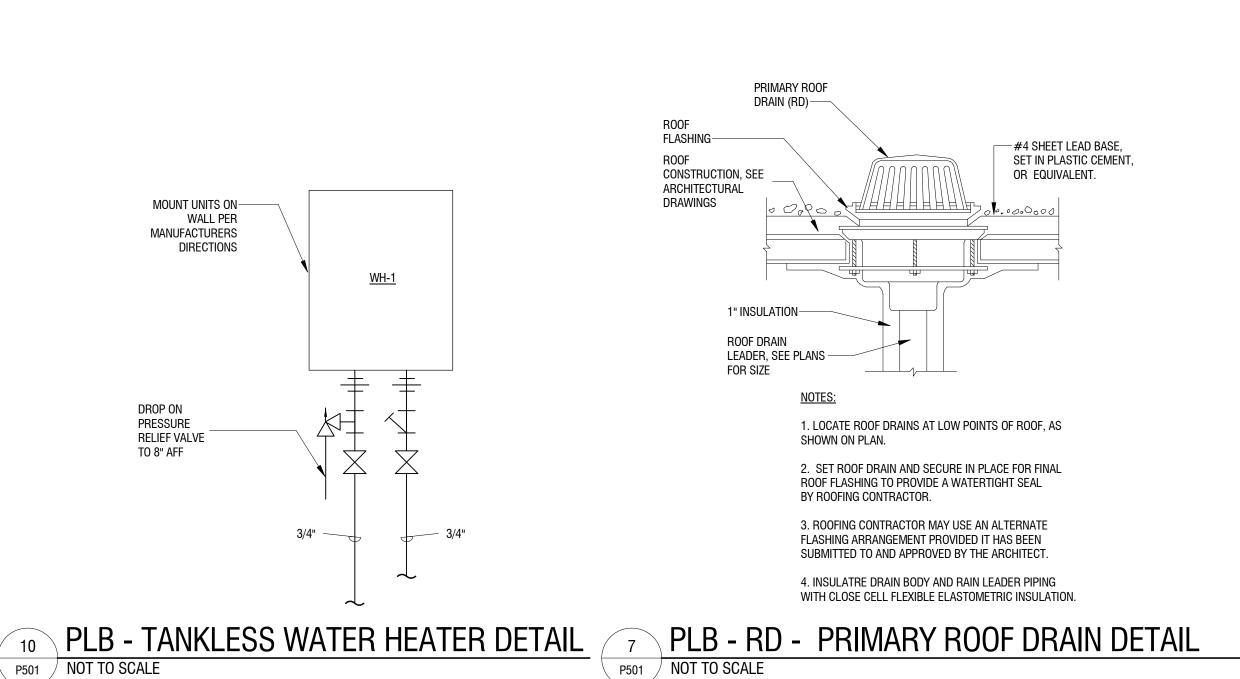-WATER CLOSET

-FINISHED FLOOR

-CONCRETE SLAB

-4" SAN TO NEAREST MAIN

C.W. SUPPLY-

SHUTOFF VALVE-

3/4" COLD WATER SUPPLY-


4" SAN TO NEAREST MAIN-


P501 NOT TO SCALE

PLAN VIEW

20 2 0 A D A O S S D A O S S D A O S S D A O S S D A O S S D A O S S D A O S S D A O S S D A O S S D A O S S D A O S S D A O S S D A O S S D A O S S D A O S S D A O S S D A O S S D A O S D A

PLB - WATER CLOSET - FLR MTD- TANK DETAIL

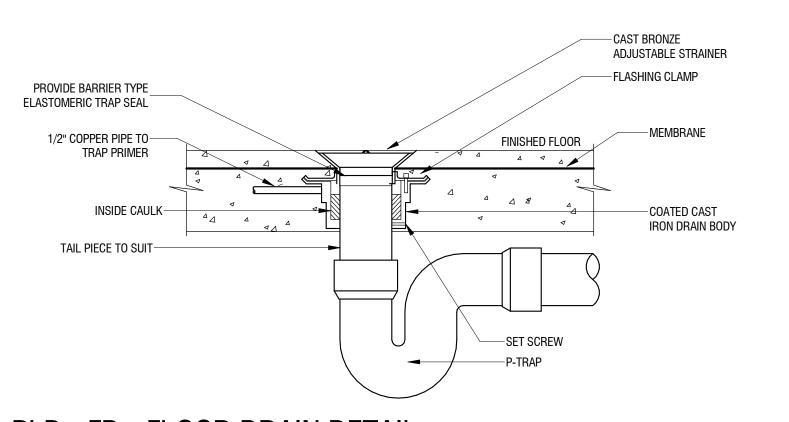

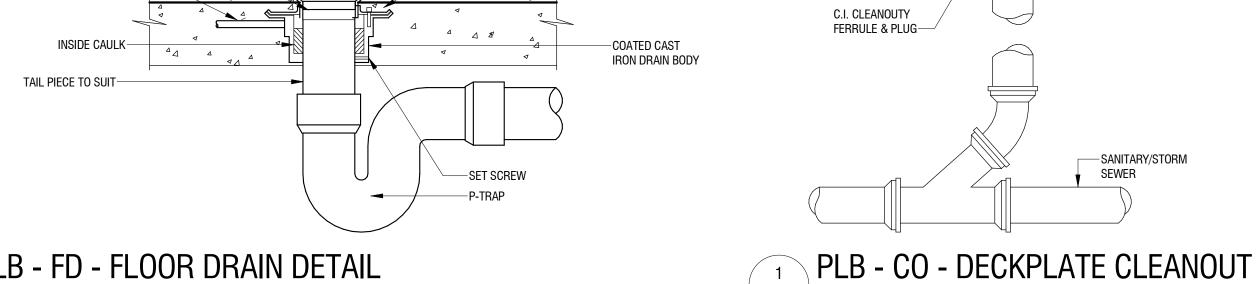


PLB - FD - FLOOR DRAIN DETAIL P501 NOT TO SCALE

										PLUMBING FIXTURE SCHEDULE
MARK	TRIM	COLD	HOT	SAN/W	VENT	SUPPORT	ADA	MANUFACTURER	MODEL	NOTES
EWC-1	-	1/2"	-	1-1/2"	1-1/2"	WALL	YES	ELKAY	LZSTL8WSLK	BI-LEVEL, BOTTLE FILLER, NON-FILTERED, 8GPH OF 50°F DRINKING WATER, 115v/1Ph, 5A, 370W
FD-1	-	-	-	3"	2"	FL00R	-	ZURN	EZ1-5	5" ROUND TOP, NICKEL BRONZE TOP, PVC OUTLET, PROVIDE TRAPE SEAL
HB-1	-	3/4"	-	-	-	WALL	-	WOODFORD	26	CHROME FINISH, BACKFLOW PROTECTED
IMB-1	-	1/2"	-	-	-	WALL	-	IPS	MIB1DAB	LEAD FREE, QUARTER TURN VALVE, WHITE POWDER COATED FINISH
LAV-1	AMERICAN STANDARD 775B.105	1/2"	1/2"	1-1/2"	1-1/2"	COUNTER	YES	ТОТО	LT221	0.5GPM SENSOR OPERATED BATTERY POWERED FAUCET, UNDERCOUNTER, WHITE, VITREOUS CHINA
MSB-1	SERVICE FAUCET 830-AA	1/2"	1/2"	3"	2"	FLOOR MOUNT	-	FIAT	MSB 2424	MOLDED STONE, PROVIDE WITH HOSE AND HOSE BRACKET (832-AA), MOP HANGER (889-CC), AND STAINLESS STEEL BUMPERGUARD (E-88-AA)
RD-1	-	-	-	3"	-	R00F	-	ZURN	FROET 100C3	BI-FUNCTIONAL DEEP SUMP DUAL OUTLET ROOF DRAIN WITH DOME
RD-2	-	-	-	4"	-	R00F	-	ZURN	FR0ET 100C4	BI-FUNCTIONAL DEEP SUMP DUAL OUTLET ROOF DRAIN WITH DOME
S-1	DELTA B1310LF	1/2"	1/2"	1-1/2"	1-1/2"	DROP-IN	YES	ELKAY	LWDB332264	33"x22"x6" DOUBLE BOWL, 22GA STAINLESS STEEL, SATIN FINISH
WC-1	-	1/2"	-	3"	2"	FLOOR MOUNT	YES	AMERICAN STANDARD	231AA.104	1.28GPF, VITREOUS CHINA, WHITE, OPEN FRONT SEAT
WH-1	-	3/4"	-	-	-	WALL	-	PRIER	C-634N	ENCASED, ANTI-SIPHON, CAST BRASS HYDRANT, SATIN NICKEL, FINISH, 3/4" INLET, 3/4" HOSE THREAD OUTLET, LOOSE KEY OPERATION, SELF DRAINING, WITH INTEGRAL VACUUM BREAKER/BACKFLOW PREVENTER

INSTANTANEOUS WATER HEATER SCHEDULE														
				TEMP RISE AT 1					DIMENSIONS					
TAG	LOCATION	SERVICE	MIN FLOW RATE	GPM	CONTROLLER	KW	AMPS	V/Ph	(HxWxD)	MANUFACTURER	MODEL	NOTES		
IWH-1	109 JANITOR	LAVATORIES	0.3 GPM	61°F at 2.0 GPM	THERMOSTATIC	18 kW	50 A	208V/3Ph	12"x19"x9"	EEMAX	EX180T2T ML			



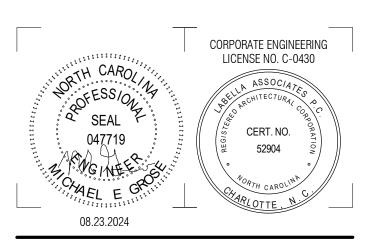

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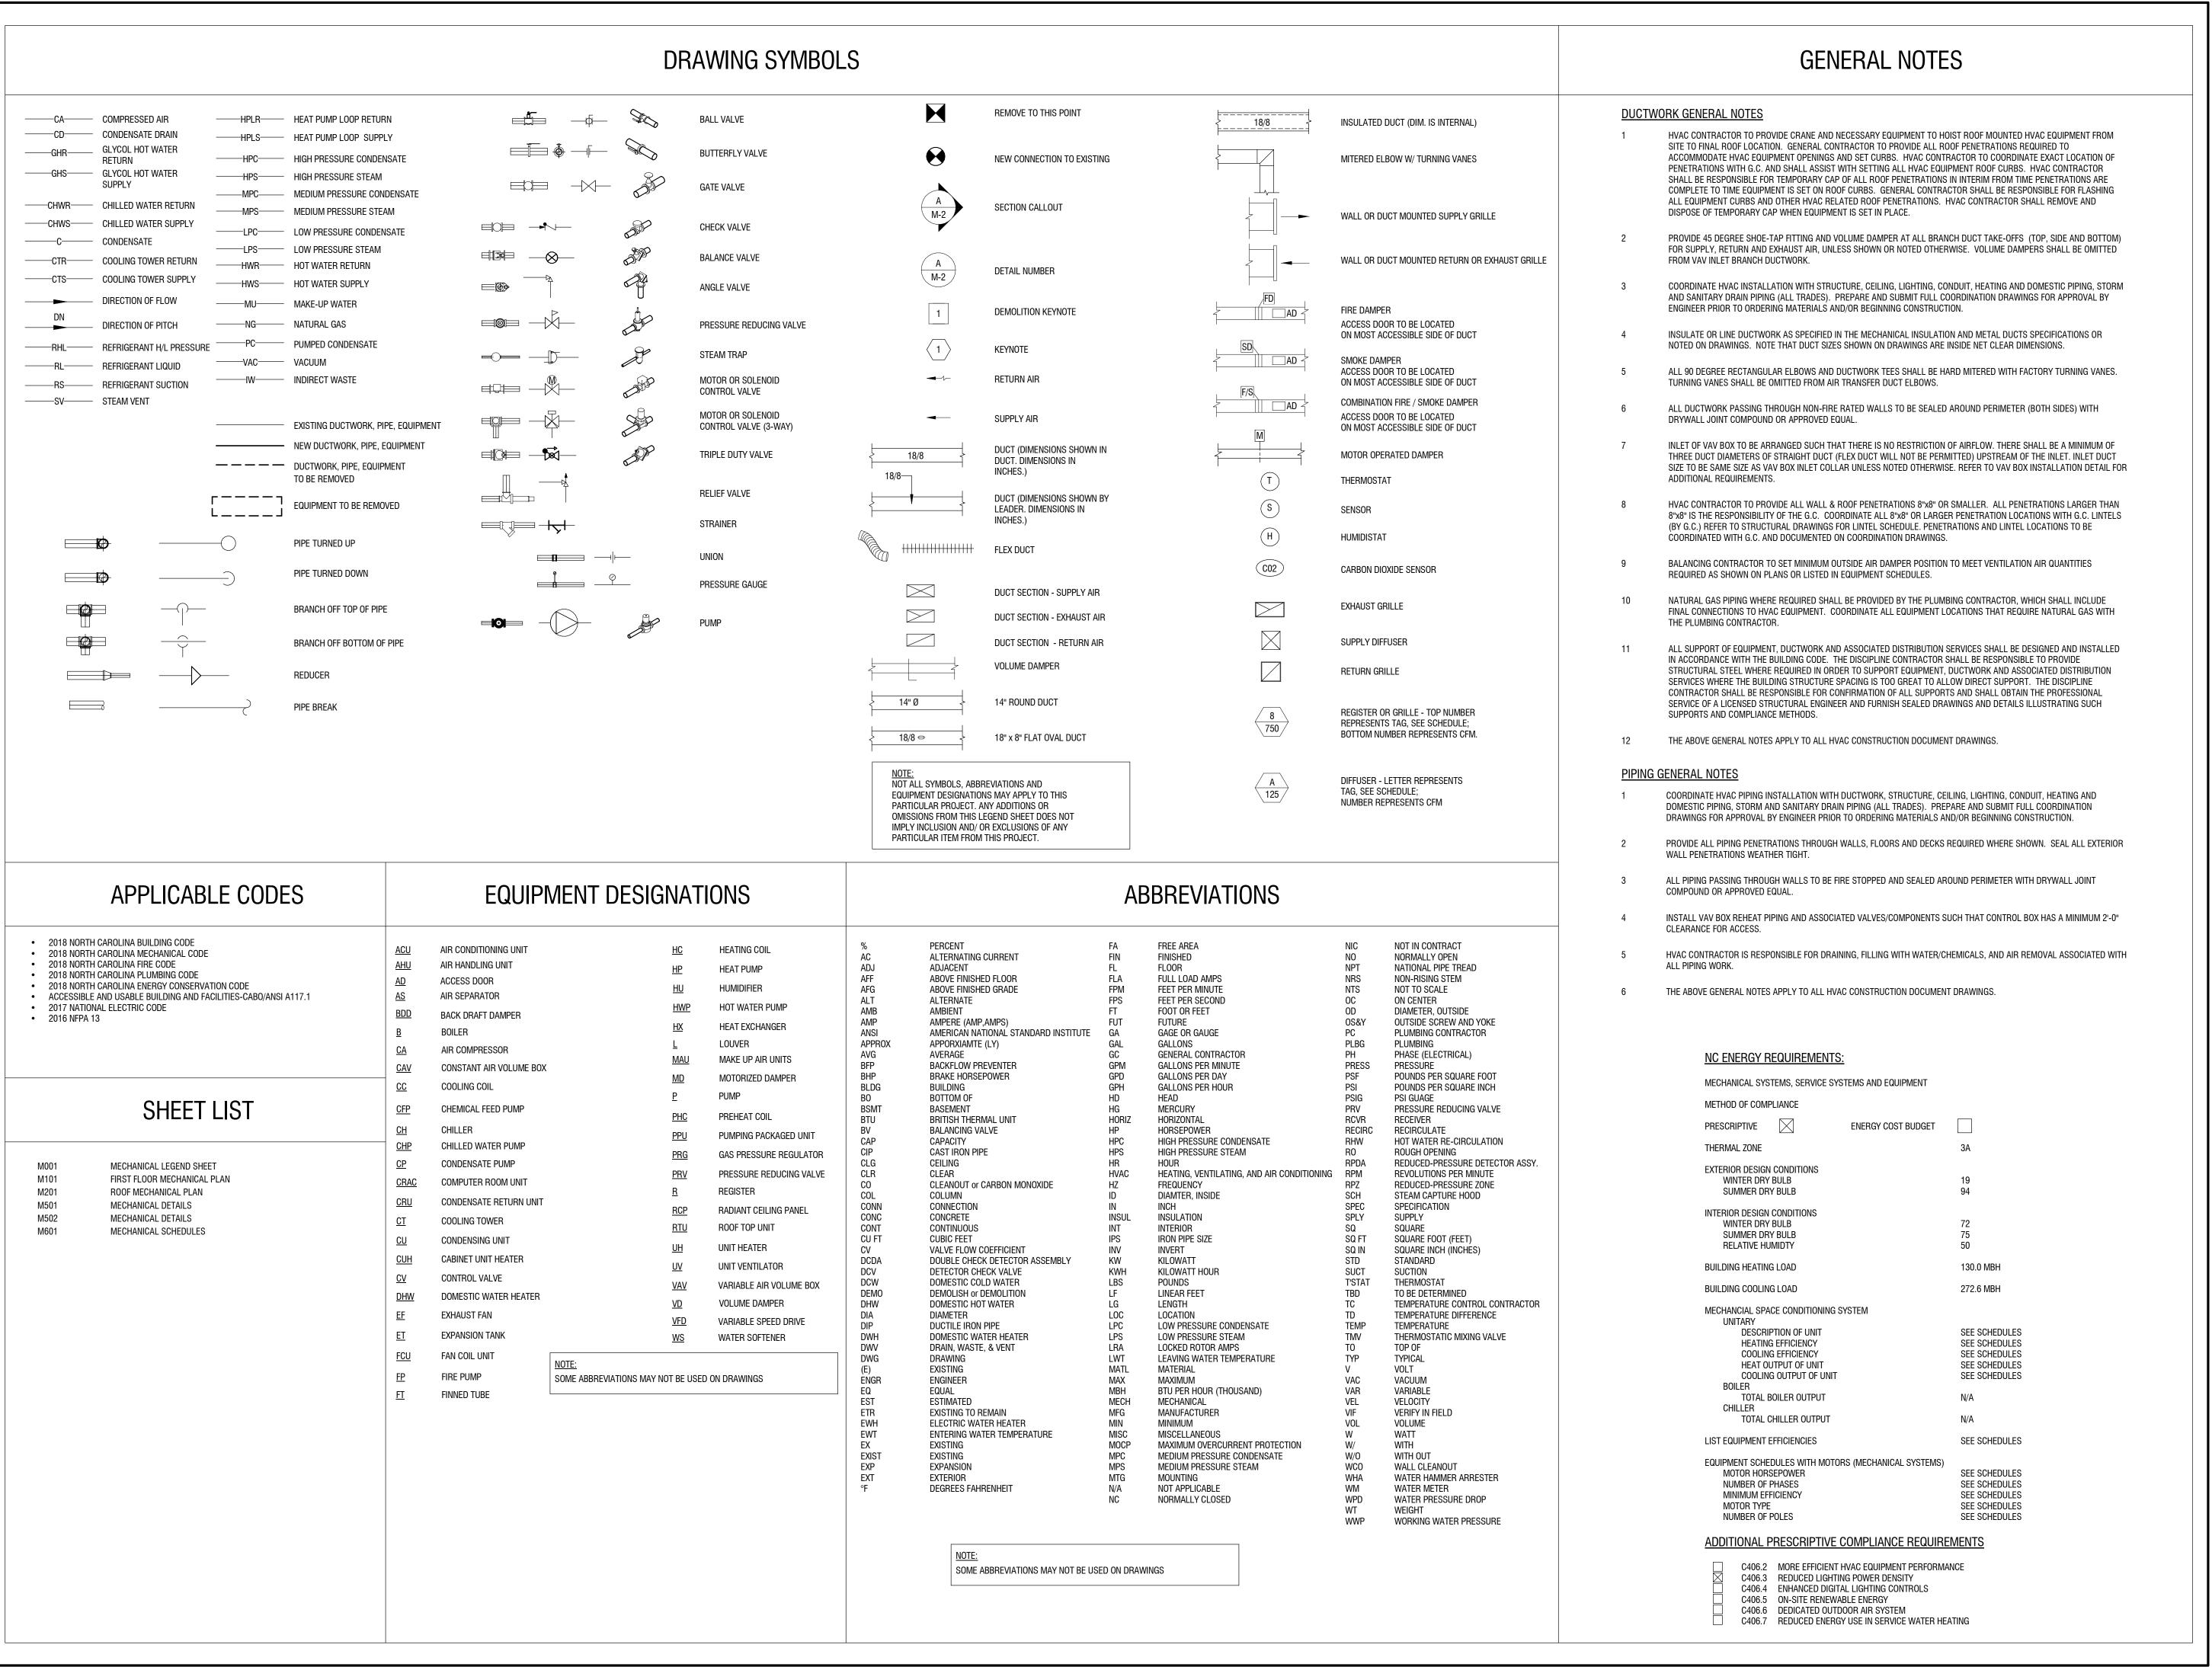
DATE:

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PLUMBING SCHEDULES

DRAWING NUMBER:





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08.23.2024



LCCU - Morrisville Site Adapt 9521 Chapel Hill RD. Morrisville, NC 27560

NO: DATE: DESCRIPTION:
Revisions

PROJECT NUMBER:

2230150

DRAWN BY: MG / MM

REVIEWED BY: MG

ISSUED FOR:

BID SET

DATE:

08.23.2024

DRAWING NAME:

MECHANICAL LEGEND SHEET

DRAWING NUMBER:

M001

KEY NOTES:

- 1 ROUTE 8" EXHAUST DUCT THROUGH ROOF AND TERMINATE W/ HOODED ROOF CAP. ROOF CAP TO BE GREENHECK MODEL RCC-8, OR APPROVED EQUAL. PROVIDE W/ BIRD SCREEN & BACKDRAFT DAMPER. COORDINATE FINISH AND ROOF PITCH W/ ARCHITECT. FIELD COORDINATE EXACT LOCATION. MAINTAIN 10'-0" MIN. AWAY FROM O.A. INTAKES. MAINTAIN 3'-0" MIN. AWAY FROM BUILDING OPENINGS.
- PROVIDE (2) 20"x20" OPENINGS ON TOP SIDE OF RETURN AIR DUCT W/ ACOUSTICAL LINER. COVER OPENINGS W/ 1/2"x1/2" WIRE MESH (TYPICAL).
- PROVIDE (2) 36"x28" OPENINGS ON TOP SIDE OF RETURN AIR DUCT W/ ACOUSTICAL LINER. COVER OPENINGS W/ 1/2"x1/2" WIRE MESH (TYPICAL).
- FIELD COORDINATE ALL LINEAR SLOT DIFFUSERS ON SIDEWALL WITH STRUCTURAL MEMBERS AND G.C..
- 5 20"x16" SUPPLY AIR DUCT AND 24"x16" RETURN AIR DUCT COMING DOWN FROM RTU-1. SEE SHEET 1/M201 FOR LOCATION OF RTU-1.
- 6 24"x24" SUPPLY AIR DUCT AND 40"x18" RETURN AIR DUCT COMING DOWN FROM RTU-2. SEE SHEET 1/M201 FOR LOCATION OF RTU-2.



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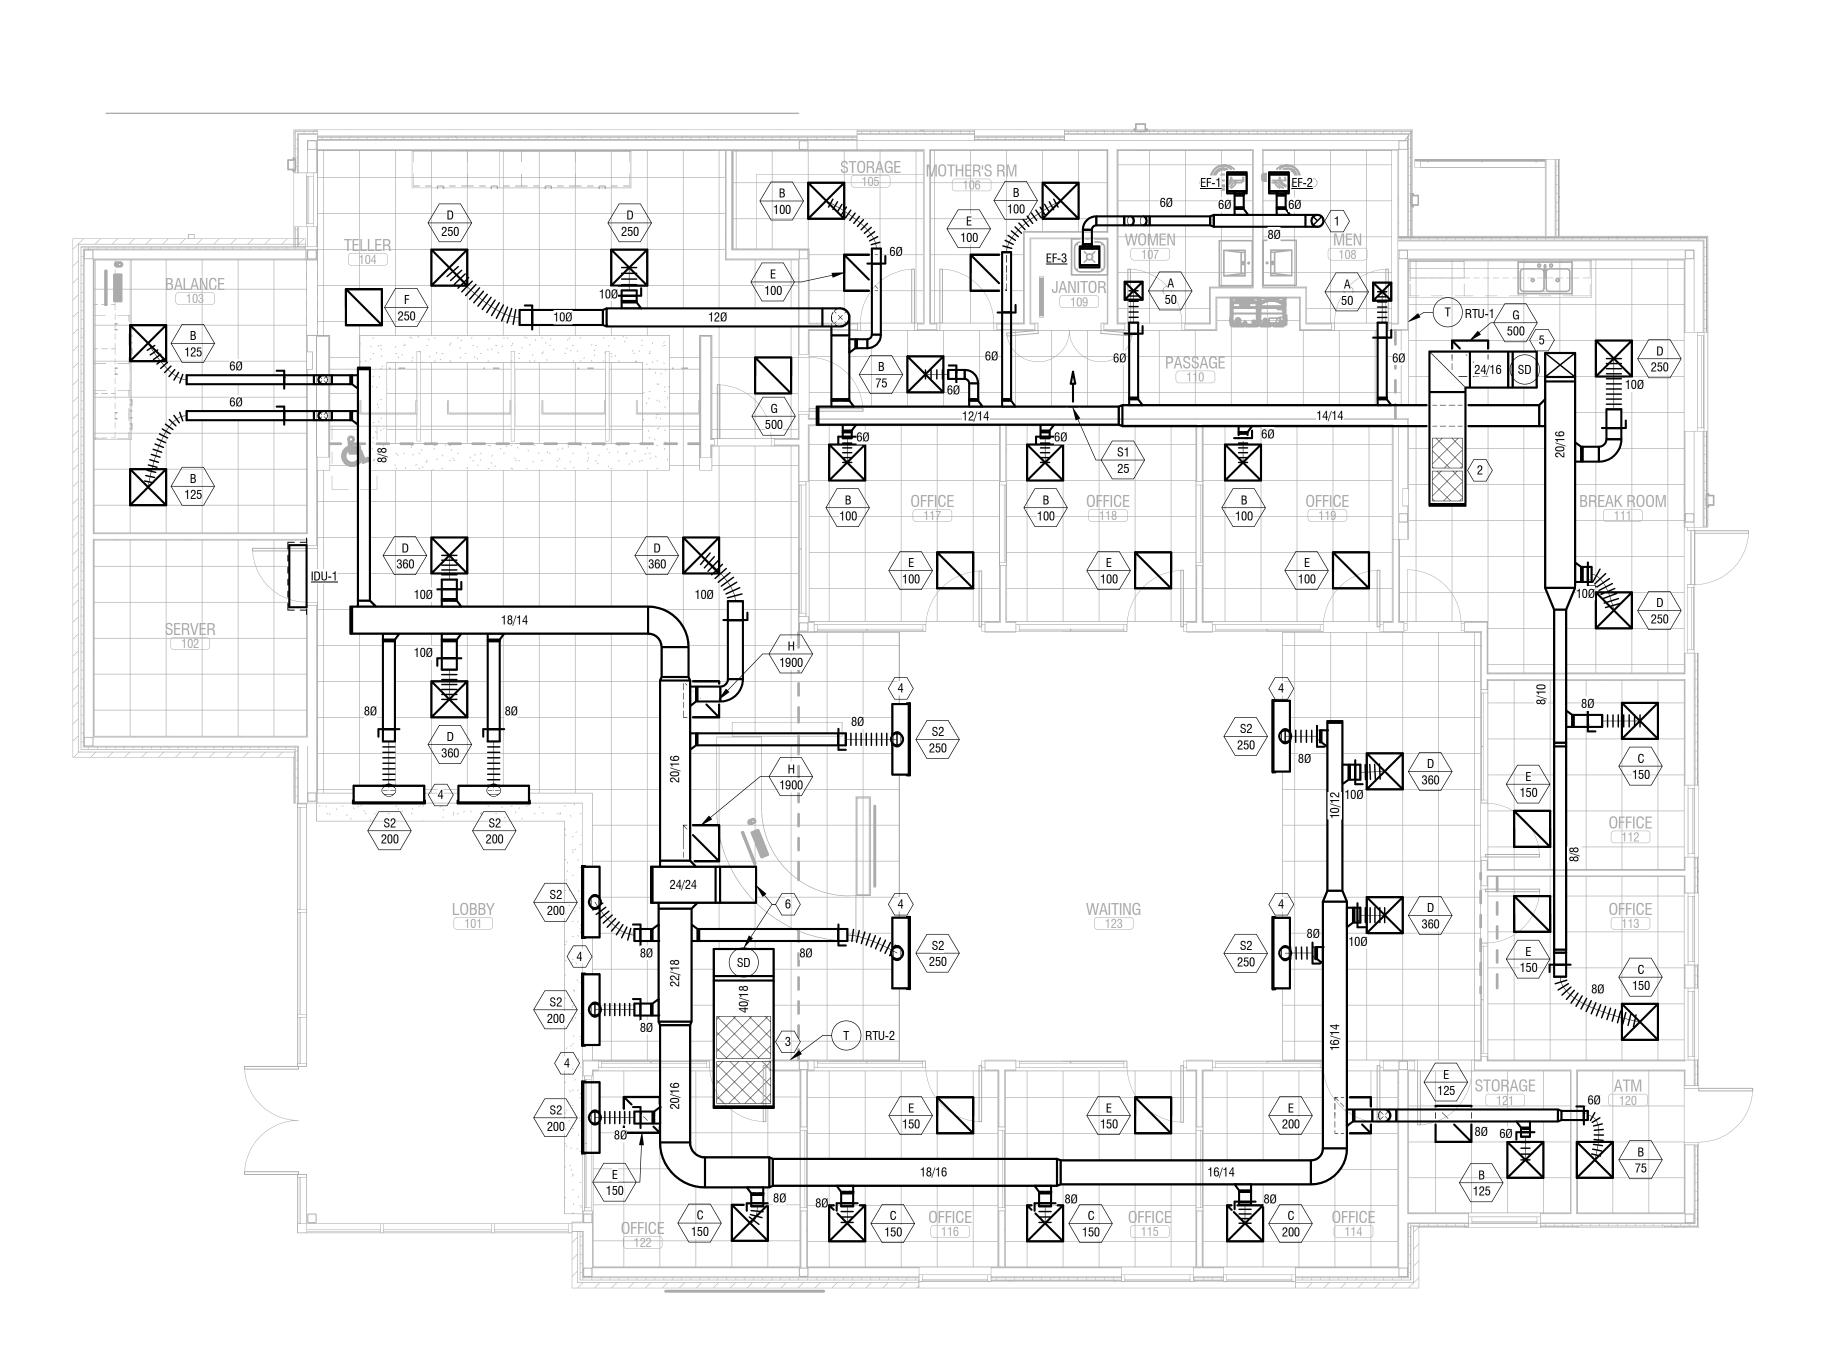
ISSUED FOR:
BID SET

DATE:
08.23.2024

FIRST FLOOR MECHANICAL PLAN

DRAWING NUMBER:

M101



1 FIRST FLOOR MECHANICAL PLAN


3/16" = 1'-0"

KEY NOTES:

- TIPELD COORDINATE EXACT LOCATION OF PLUMBING VENTS AND EXHAUST DUCTWORK THROUGH ROOF. MAINTAIN 10'-0" MIN. AWAY FROM O.A. INTAKES. MAINTAIN 3'-0" MIN. AWAY FROM BUILDING OPENINGS.
- FIELD COORDINATE EXACT LOCATION OF ROOF TOP UNIT WITH G.C. AND STRUCTURAL. MAINTAIN 10'-0" MIN. AWAY FROM E.A. OUTLETS. MAINTAIN MANUFACTURER RECOMMENDED CLEARANCES.
- FIELD COORDINATE EXACT LOCATION OF OUTDOOR CONDENSING UNIT WITH G.C.. COORDINATE ALL MANUFACTURER'S CLEARANCES AND REFRIGERANT LINESET LENGTH ALLOWANCES PRIOR TO PURCHASING ANY EQUIPMENT. NOTIFY ENGINEER AND ARCHITECT OF ANY DISCREPANCIES.



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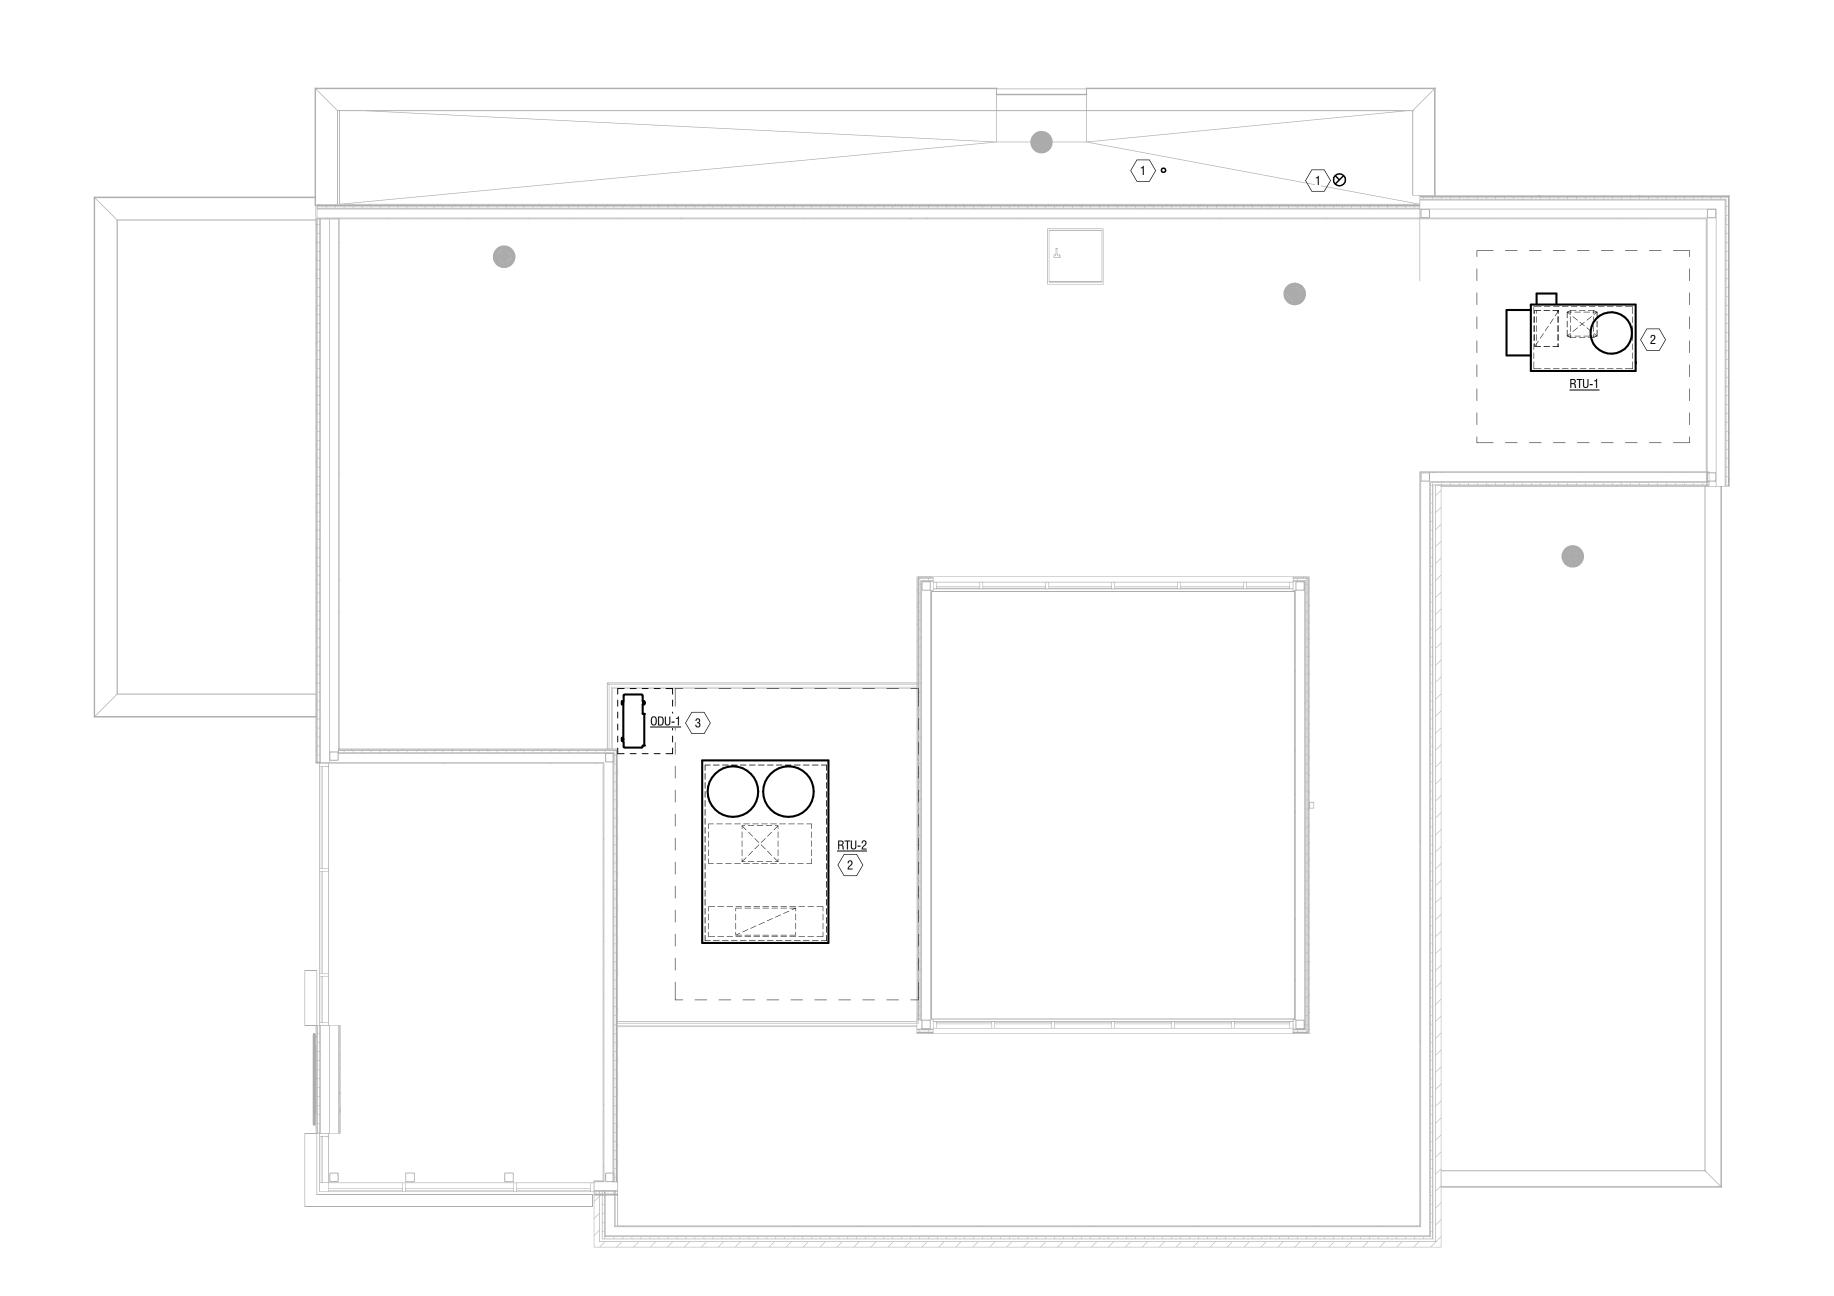
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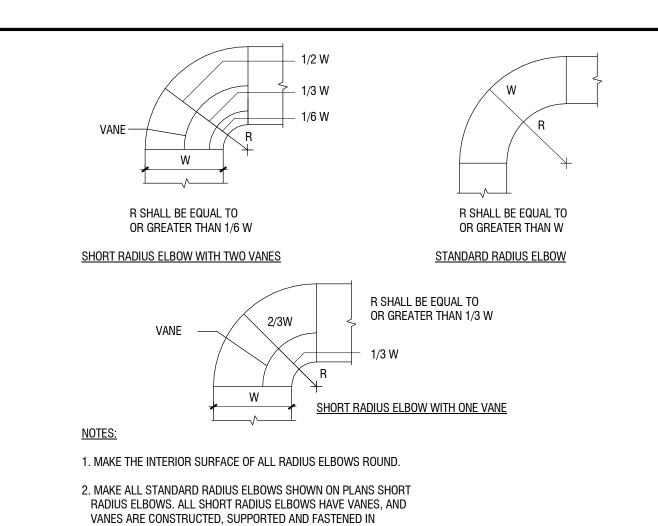
ROOF MECHANICAL PLAN

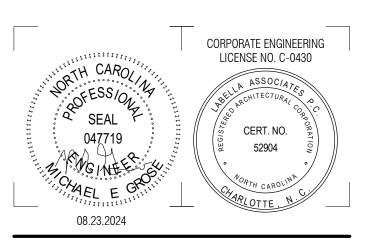DRAWING NUMBER:

M201




1 ROOF MECHANICAL PLAN
M201 3/16" = 1'-0"




DUCT - TYPICAL RADIUS ELBOWS M501 NOT TO SCALE


ACCORDANCE WITH SMACNA.

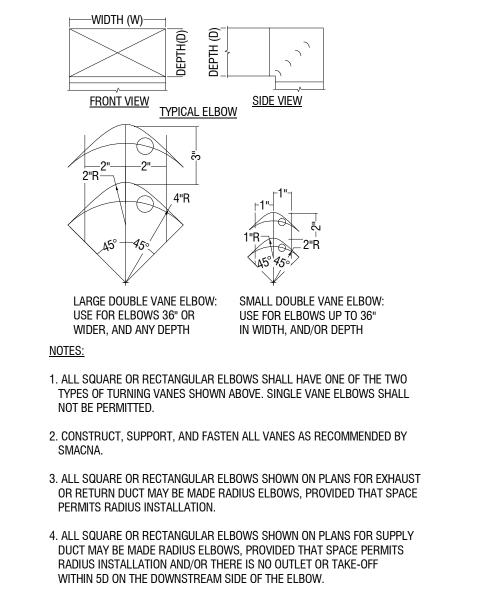


B DUCT - SQUARE OR RECTANGULAR ELBOWS M501 NOT TO SCALE

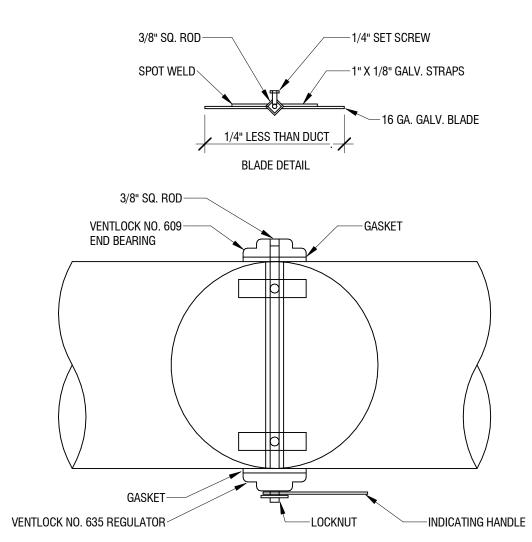

DUCT - ROUND VOLUME DAMPER DETAIL M501 NOT TO SCALE

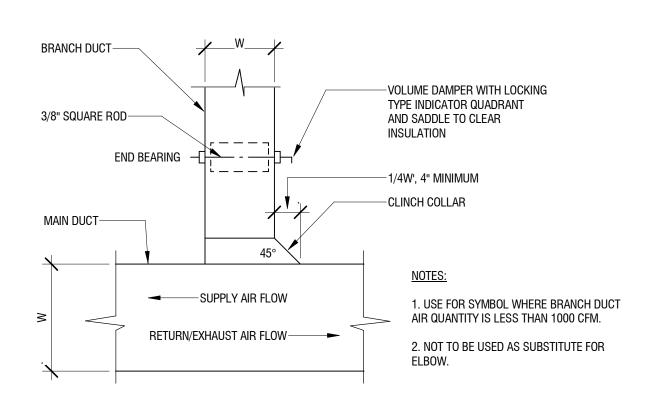


DUCT - RECTANGULAR BRANCH CONNECTION DETAIL

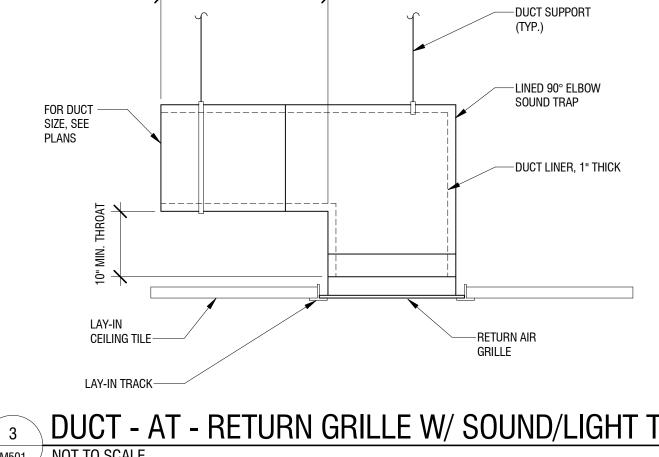


2'-0" (MIN.)

DUCT - AT - RETURN GRILLE W/ SOUND/LIGHT TRAP M501 NOT TO SCALE

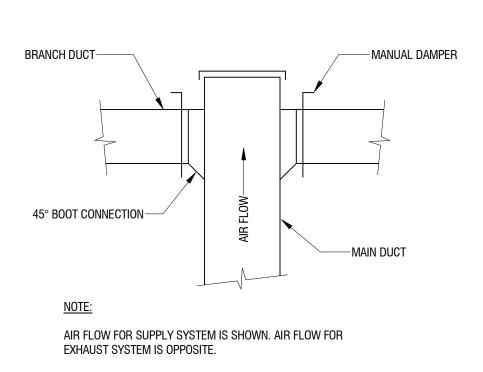

5 DUCT - DUCT TEE BRANCH TAKE-OFF DETAIL M501 NOT TO SCALE

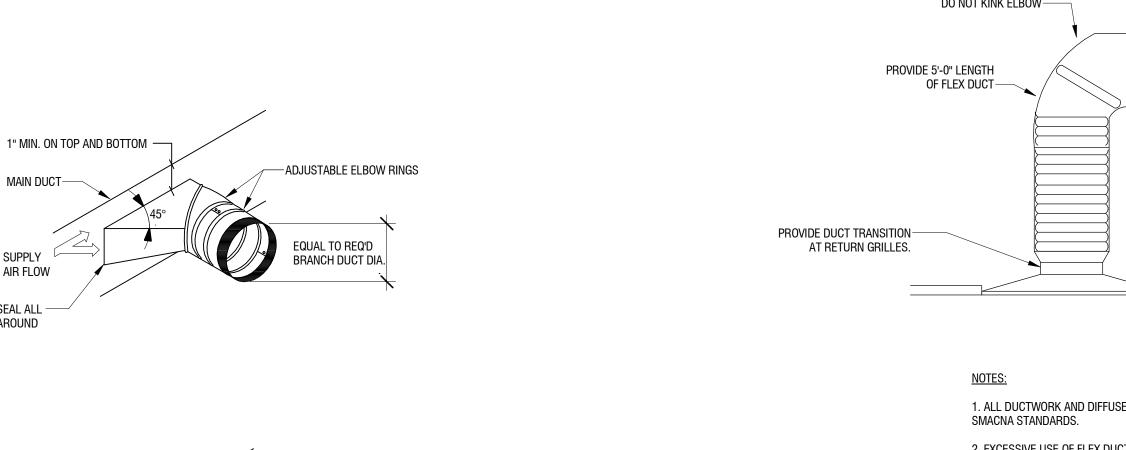



- 1/4" BRANCH DUCT

WIDTH, BUT MIN. 4"

—EQUAL TO REQ'D

BRANCH DUCT DIMENSIONS

MAIN DUCT-

AIR FLOW


SEAL ALL —

1" MIN. ON TOP AND BOTTOM


MAIN DUCT-

SEAL ALL AROUND

AROUND

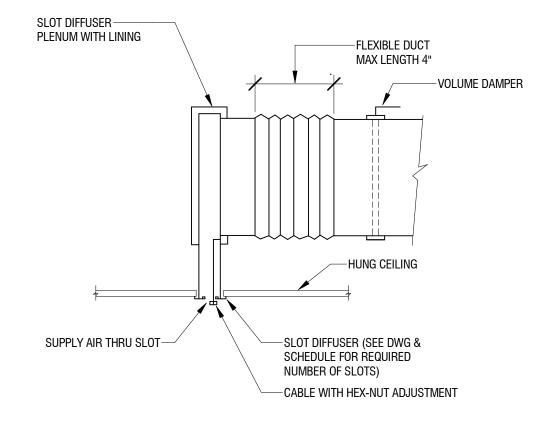



DUCT - AT - LINEAR DIFFUSER DETAIL M501 NOT TO SCALE

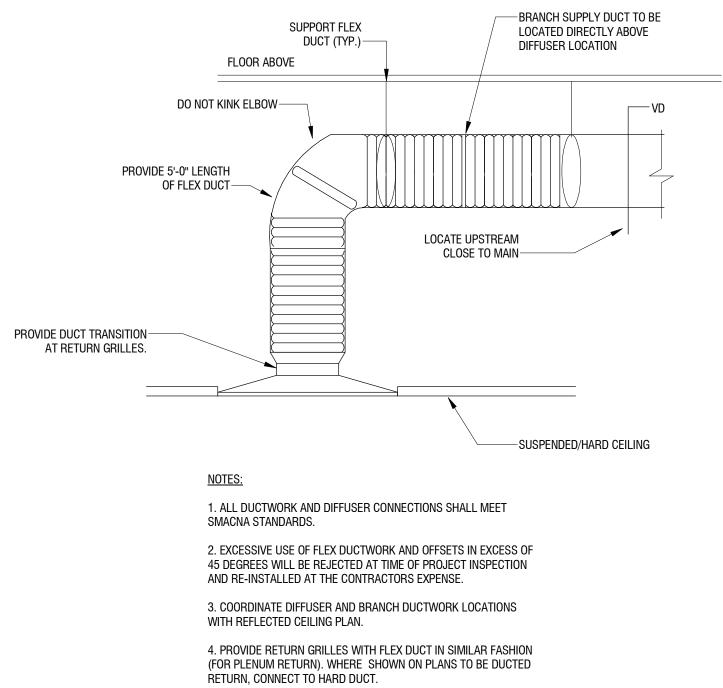

DUCT - AT - DIFFUSER AND RETURN GRILLE CONNECTION DETAIL M501 NOT TO SCALE

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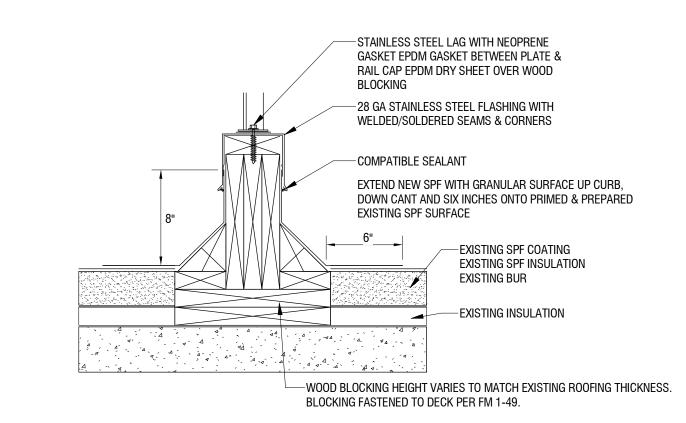
LCCU - Morrisville Site Adapt 9521 Chapel Hill RD. Morrisville, NC 27560
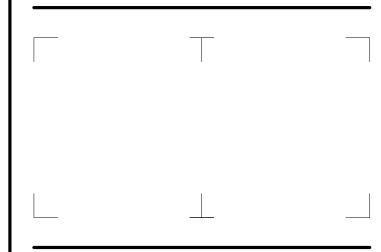
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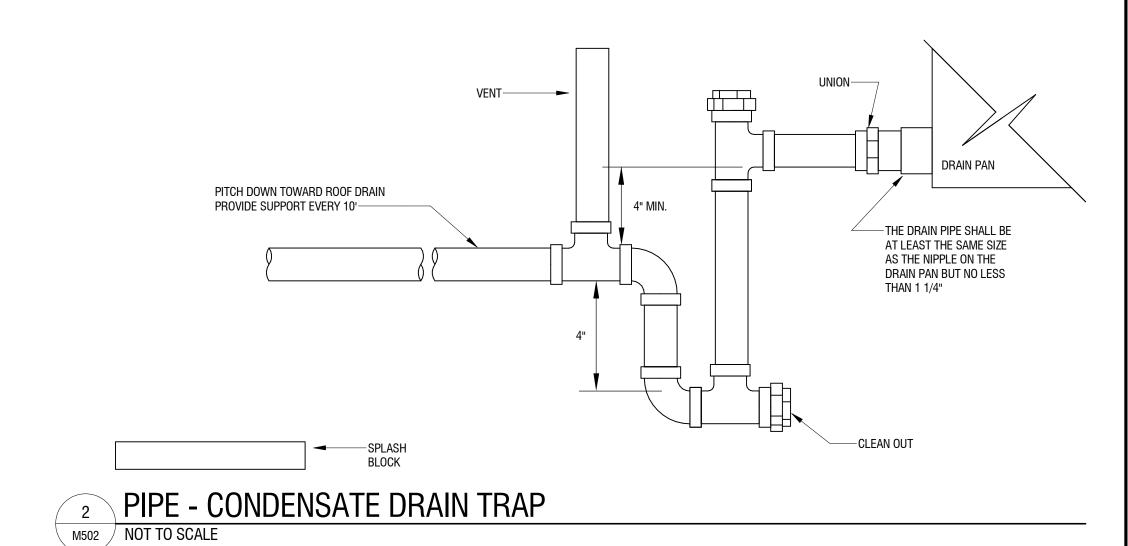
MECHANICAL DETAILS

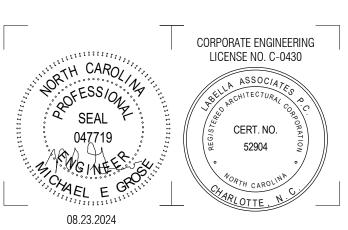
DRAWING NUMBER:

DRAWING NAME:




3 S - ROOF CURB DETAIL M502 NOT TO SCALE



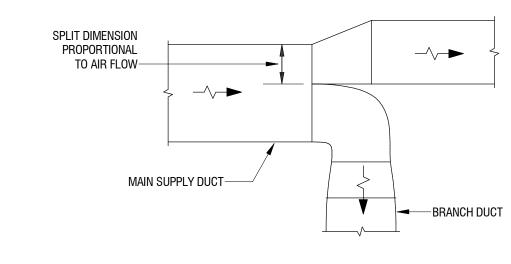

<u>PLAN VIEW</u> <u>AIR SPLIT TYPE DUCT TAKE-OFF</u>

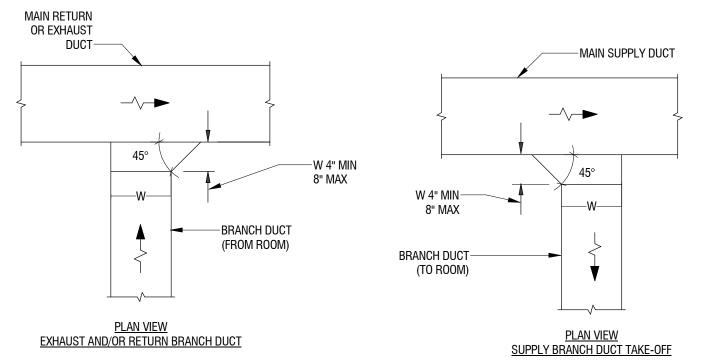


M502 NOT TO SCALE

DUCT - TYPICAL DUCTWORK DETAILS



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NO: DATE: DESCRIPTION: Revisions PROJECT NUMBER: 2230150 DRAWN BY: MG / MM REVIEWED BY: ISSUED FOR: BID SET DATE: 08.23.2024

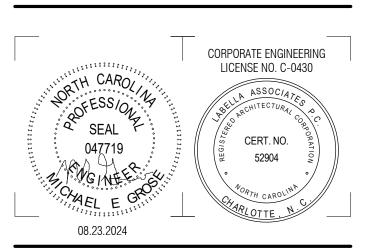MECHANICAL DETAILS

DRAWING NUMBER:

DRAWING NAME:

ANGLE (LLV) MECHANICAL HANGER EQUIPMENT--JAM NUTS RODS— (TYPICAL) -3"x3"x1/4" ANGLE TRAPEZE-JAM NUT (TYPICAL) — NOTES:

—BEAMS OR JOISTS SEE

STRUCTURAL

DRAWINGS

−3"x4"x1/4"

1. MAXIMUM LOAD PER HANGER ASSEMBLY = 750 POUNDS.

CLAMP-

2. LOCATE HANGERS AS REQUIRED FOR PROPER SUPPORT OF EQUIPMENT.

3. PROVIDE EXTERNAL VIBRATION ISOLATORS ONLY IF FAN EQUIPMENT HAS NOT BEEN

PROVIDED WITH INTERNAL VIBRATION ISOLATION.

S - TYPICAL MECHANICAL EQUIPMENT HANGER DETAIL M502 NOT TO SCALE

	RTU (DX) SCHEDULE																																	
	SUPPLY OUTSIDE SUPPLY AIR			l		SUPPLY FAN			COMPRESSOR CONDENSER				COOLING					HEATING				ELECTRICAL												
	NOMINAL	MAX	HEATING	At Max		ESP (in.	TSP (in.								CAPACITY						CAPACITY				INPUT	OUTPUT								
No.	TONS	CFM	CFM	SACFM	TYPE	w.g.)	w.g.)	HP FL/	No.	RLA	LRA	No.	FLA	LRA	CONTROL	EAT	LAT	TOTAL MBH	SENS. MBH	EFFICIENCY	CONTROL	EAT	LAT	FUEL	MBH	MBH	EFFICIENCY	V/PH/Hz	MCA	MOP	WEIGHT	MANUFACTURER	MODEL	NOTES
RTU-1	5.0	2000	2000	285	DIRECT	1.0	1.28	1.5 -	1	15.9	-	1	1.4	-	TSTAT	80	57.5	59.9	48.8	12.0 EER	TSTAT	65	102.8	NATURAL GAS	100.0	81.0	14.0 SEER	208V/3Ph/60Hz	30.0	45	797	TRANE	YSC060G3EM	1 - 7
RTU-2	12.5	4900	4900	560	BELT	1.0	1.29	3.0 10.	6 2	24.96	-	2	2.2	-	TSTAT	80	57.5	147.7	119.1	11.0 EER	TSTAT	65	117.7	NATURAL GAS	350.0	280.0	12.2 SEER	208V/3Ph/60Hz	60.0	80	1970	TRANE	YSD150G3RV	1 - 8

NOTES:

1. COOLING CAPACITIES ARE RATED IN ACCORDANCE WITH AHHRI STANDARD 210/290 AT 95F AMBIENT OUTDOOR AIR TEMP. 80F DRY BULB, 67F WET BULB ENTRANCE AIR TEMP, AND NOMINAL AIR QUANTITY LISTED.
MANUFACTURER'S FULL PEREMITER INSULATED ROOF CURB.

PROVIDE 7-DAY PROGRAMMABLE THERMOSTAT W/ CLEAR, LOCKING COVER.

FIELD MOUNTED DISCONNECT SWITCH - TO BE PROVIDED & INSTALLED BY E.C.
 PROVIDE NEW FILTERS FOR EACH UNIT.

6. INTEGRATED ENTHALPY ECONOMIZER W/ BAROMETRIC RELIEF. 7. DUCT SMOKE DETECTOR.

8.	PROVIDE UNIT WITH DUAL COMPRESSOR SYSTEMS

								M	INI-SPLIT SY	STEM (CO	OLING	ONLY) S	SCHEDULE	Ē						
IND00R	OUTDOOR		COOLING	PERF0F	RMANCE			li I	NDOOR UNIT					OUT	DOOR UNIT					
UNIT TAG	UNIT TAG	LOCATION	CAPACITY (MBH)	EER	REFRIG. TYPE	DRY CFM	WET CFM	WEIGHT (lb)	POWER	MAX FUSE	MCA	FAN FLA	WEIGHT (lb)	POWER	MAX FUSE	MCA	FAN FLA	MANUFACTURER	MODEL	NOTES
IDU-1	ODU-1	102 SERVER	12.0	13.3	R-410a	265	215	28	208V/1Ph/60Hz	-	1.0	0.19	92	208V/1Ph/60Hz	28	11.0	0.5	MITSUBISHI	PKA-A12LA / PUY-A12NKA7	

NOTES:

1. PROVIDE NEW FILTER FOR ALL UNITS UPON ACCEPTANCE OF PROJECT. 2. FIELD MOUNTED DISCONNECT SWITCH TO BE PROVIDED & NSTALLED BY E.C.. PROVIDE 7-DAY PROGRAMMABLE AUTO-CHANGEOVER HEAT/COOL THERMOSTAT/

PROVIDE LONG LINE REFRIGERANT PIPING KIT (INCLUDING LIQUID LINE SOLENOID VALVES, 7. CONDENSATE OVERFLOW SWITCH ACCUMULATOR, ETC.) WHENEVER MANUFACTURER'S RECOMMENDED LENGTHS ARE 8. INDOOR UNIT POWERED FROM OUTDOOR UNIT. EXCEEDED. SEE INSTALLATION INSTRUCTIONS FOR MANUFACTURER'S RECOMMENDED EQUIVALENT REFRIGERANT PIPING LENGTHS PRIOR TO PERFORMING ANY WORK.

5. REFRIGERATION PIPING TO BE SIZED PER THE TOTAL INSTALLED EQUIVALENT LENGTH. 6. SINGLE POINT ELEC. POWER CONNECTION.

						EXHAUST FAN	SCHEDULE						
							Electrical Data						
No.	LOCATION	SERVICE	TYPE	CFM	ESP (in.)	W	VOLTS PH	FLA	SONES	WEIGHT (lb)	MANUFACTURER	MODEL	NOTES
EF-1	107 WOMEN	EXHAUST	CEILING CENTRIFUGAL	80	0.25	16.7	120V/1Ph	0.14	0.4	12	GREENHECK	SP-A90	1 - 7
EF-2	108 MEN	EXHAUST	CEILING CENTRIFUGAL	80	0.25	16.7	120V/1Ph	0.14	0.4	12	GREENHECK	SP-A90	1 - 7
EF-3	109 JANITOR	EXHAUST	CEILING CENTRIFUGAL	80	0.25	16.7	120V/1Ph	0.14	0.4	12	GREENHECK	SP-A90	1 - 7

NOTES:

1. INTERLOCK WITH LIGHTS BIRDSCREEN 3. BACKDRAFT DAMPER

SUBBASE W/ CLEAR LOCKING COVER FOR EACH UNIT. 4. OUTDOOR UNITS SHALL HAVE MINIMUM 15.0 SEER RATING.

> UL LISTED 6. VIBRATION ISOLATION 7. PROVIDE WITH A ROOF CAP 4. INTEGRAL DISCONNECT SWITCH


					DIFFUS	SER SCHEDULE					
No.	NECK SIZE (Dia.)	FACE SIZE	MATERIAL	DAMPER	MOUNTING	FINISH	USE	DESCRIPTION	MANUFACTURER	MODEL	NOTES
А	6"	12"x12"	ALUMINUM	VOLUME	LAY-IN / SURFACE	NOTE 1	SUPPLY	PLAQUE FACE DIFFUSER	TITUS	OMNI-AA	1
В	6"	24"x24"	ALUMINUM	VOLUME	LAY-IN / SURFACE	NOTE 1	SUPPLY	PLAQUE FACE DIFFUSER	TITUS	OMNI-AA	1
С	8"	24"x24"	ALUMINUM	VOLUME	LAY-IN / SURFACE	NOTE 1	SUPPLY	PLAQUE FACE DIFFUSER	TITUS	OMNI-AA	1
D	10"	24"x24"	ALUMINUM	VOLUME	LAY-IN / SURFACE	NOTE 1	SUPPLY	PLAQUE FACE DIFFUSER	TITUS	OMNI-AA	1
Е	8"	24"x24"	ALUMINUM	NONE	LAY-IN / SURFACE	NOTE 1	RETURN	PERFORATED FACE DIFFUSER	TITUS	PAR-AA	1
F	10"	24"x24"	ALUMINUM	NONE	LAY-IN / SURFACE	NOTE 1	RETURN	PERFORATED FACE DIFFUSER	TITUS	PAR-AA	1
G	12"	24"x24"	ALUMINUM	NONE	LAY-IN / SURFACE	NOTE 1	RETURN	PERFORATED FACE DIFFUSER	TITUS	PAR-AA	1
Н	20"	24"x24"	ALUMINUM	NONE	LAY-IN / SURFACE	NOTE 1	RETURN	PERFORATED FACE DIFFUSER	TITUS	PAR-AA	1
S1	4"x2"	6"x5"	ALUMINUM	VOLUME	SURFACE	NOTE 1	SUPPLY	SUPPLY GRILLE W/ 3/4" SPACING	TITUS	300FS	1, 2
S2	8"	6"x48"	ALUMINUM	VOLUME	SIDEWALL / SURFACE	NOTE 1	SUPPLY	1" LINEAR SLOT DIFFUSER	TITUS	ML-39	1, 2

<u>NOTES:</u>
1. FINISH TO MATCH CEILING, WALL OR DUCTWORK 2. COORDINATE EXACT HEIGHT OF DIFFUSERS W/ G.C. AND ARCHITECTURAL

				DESIGN BRIE	F - VENTIL	ATION CAL	.CULATIC	ONS					
Room			Area (Az)	Occupant Density	OA/Person	Outdoor Air	Exhaust	Config.	Occupa	ancy (Pz)	_	Zone Outdoor Airflow	Space Exhaust
Number	Room Name	Classification	(sq.ft.)	(#/1000 sq.ft.)	(Rp)	Rate (Ra)	Rate	(Ez)	Code	Adjusted	Rate (Vbz) (cfm)	Rate (Voz) (cfm)	Rate (cfm)
100	VESTIBULE	CORRIDOR	85	0	0	0.06	0	0.80	0	0	5	6	0
101	LOBBY/WAITING	LOBBIES	1991	15	8	0.06	0	0.80	30	31	367	459	0
102	SERVER	TELEPHONE CLOSETS	129	0	0	0	0	0.80	0	0	0	0	0
103	BALANCE	OFFICE SPACE	179	5	5	0.06	0	0.80	1	1	16	20	0
104	TELLER	OFFICE SPACE	401	5	5	0.06	0	0.80	2	3	39	49	0
105	STORAGE	STORAGE	84	2	5	0.06	0	0.80	0	1	10	13	0
106	LACTATION	OFFICE SPACE	71	5	5	0.06	0	0.80	0	1	9	12	0
107	WOMEN	TOILETS	67	0	0	0	0.71	0.80	0	0	0	0	80
108	MEN	TOILETS	67	0	0	0	0.71	0.80	0	0	0	0	80
109	JANITOR	JANITOR CLOSET	20	0	0	0	0	0.80	0	0	0	0	80
110	PASSAGE	CORRIDOR	168	0	0	0.06	0	0.80	0	0	10	13	0
111	BREAK ROOM	BREAKROOMS	345	50	5	0.12	0	0.80	17	18	131	164	0
112	OFFICE	OFFICE SPACE	112	5	5	0.06	0	0.80	1	1	12	15	0
113	PRINT ROOM	OFFICE SPACE	107	5	5	0.06	0	0.80	1	1	11	14	0
114	OFFICE	OFFICE SPACE	118	5	5	0.06	0	0.80	1	1	12	15	0
115	OFFICE	OFFICE SPACE	115	5	5	0.06	0	0.80	1	1	12	15	0
116	OFFICE	OFFICE SPACE	115	5	5	0.06	0	0.80	1	1	12	15	0
117	OFFICE	OFFICE SPACE	115	5	5	0.06	0	0.80	1	1	12	15	0
118	OFFICE	OFFICE SPACE	114	5	5	0.06	0	0.80	1	1	12	15	0
119	OFFICE	OFFICE SPACE	114	5	5	0.06	0	0.80	1	1	12	15	0
120	ATM	STORAGE	47	0	0	0.12	0	0.80	0	0	6	7	0
121	STORAGE	STORAGE	71	0	0	0.12	0	0.80	0	0	9	11	0
122	OFFICE	OFFICE SPACE	125	5	5	0.06	0	0.80	1	1	13	16	0



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NO: DATE: DESCRIPTION: PROJECT NUMBER: 2230150 DRAWN BY: MG / MM BID SET DATE: 08.23.2024 DRAWING NAME:

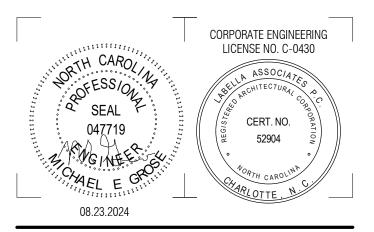MECHANICAL SCHEDULES

DRAWING NUMBER:

THE WORK COVERED BY THESE SPECIFICATIONS CONSISTS OF FURNISHING ALL LABOR, EQUIPMENT, SUPPLIES, AND MATERIALS, AND PERFORMING ALL OPERATIONS, INCLUDING TRENCHING, BACKFILLING, CUTTING, CHANNELING, CHASING, AND PATCHING NECESSARY FOR THE INSTALLATION OF COMPLETE WIRING SYSTEMS IN STRICT ACCORDANCE WITH DIVISION 16 OF THESE SPECIFICATIONS, AND THE APPLICABLE DRAWINGS, INSTRUCTION TO BIDDERS. GENERAL CONDITIONS. AND DIVISION ONE. GENERAL REQUIREMENTS.

- A. THE INSTALLATION SHALL COMPLY WITH THE APPLICABLE RULES OF THE NATIONAL ELECTRICAL CODE AND RULES AND REGULATIONS OF LOCAL AUTHORITIES HAVING JURISDICTION. IN NO CASE SHALL THE MATERIALS AND WORKMANSHIP FAIL TO MEET THE MINIMUM REQUIREMENTS OF THE 2020 NATIONAL ELECTRICAL CODE.
- 1. THE REGULATIONS OF THE LOCAL UTILITY SHALL GOVERN SERVICE CONNECTIONS AND METERING PROVISIONS.
- 2. AN ELECTRICAL INSPECTION CERTIFICATE SHALL BE ISSUED BY THE LOCAL AUTHORITY BEFORE WORK WILL BE APPROVED FOR FINAL PAYMENT. 3. THIS CONTRACTOR SHALL DO ALL CUTTING NECESSARY FOR THE PROPER INSTALLATION OF THIS WORK AND SHALL REPAIR ANY DAMAGE DONE BY HIMSELF OR HIS WORKMEN TO CEILINGS, WALLS, FLOORS, PAVING, AND SEEDED AREAS.
- B. SITE INSPECTION. EACH ELECTRICAL BIDDER SHALL VISIT THE SITE OF WORK AND FAMILIARIZE HIMSELF WITH THE CHARACTER AND CONDITIONS OF THE SITE AND THE PROPOSED BUILDING.
- C. MATERIALS. ALL MATERIALS, DEVICES, APPLIANCES, AND EQUIPMENT USED IN THIS WORK SHALL BE NEW AND APPROVED BY THE UNDERWRITERS' LABORATORIES IN EVERY CASE WHERE THEY HAVE ESTABLISHED A STANDARD FOR THE PARTICULAR TYPE OF MATERIALS TO BE INSTALLED OR SHALL BE LABEL LISTED BY A NORTH CAROLINA APPROVED THIRD PARTY TESTING AGENCY.
- 1. ALL LIGHTING FIXTURES SHALL BEAR THE LABEL OF UNDERWRITERS' LABORATORIES OR BE LISTED UNDER THE REEXAMINATION SERVICE. 2. CATALOG NUMBERS AND TRADE NAMES IN THESE SPECIFICATIONS AND NOTED ON THE DRAWINGS ARE INTENDED TO DESCRIBE THE MATERIAL, DEVICE, OR APPARATUS WANTED.
- D. SUPERVISION. THE CONTRACTOR SHALL BE IN CHARGE OF THE WORK AT ALL TIMES DURING CONSTRUCTION. A THOROUGHLY COMPETENT FOREMEN WITH EXTENSIVE EXPERIENCE IN THE WORK TO BE PERFORMED UNDER THE CONTRACT. ANYONE DEEMED NOT CAPABLE BY THE ENGINEER SHALL BE REPLACED IMMEDIATELY UPON REQUEST AND AFTER A SATISFACTORY FOREMEN HAS BEEN ASSIGNED HE SHALL NOT BE WITHDRAWN WITHOUT THE
- WRITTEN CONSENT OF THE ENGINEER. E. TESTS. A FULL SCALE TEST WITH ALL LIGHTS, EQUIPMENT, AND APPLIANCES IN OPERATION SHALL BE CONDUCTED BY THE CONTRACTOR AT HIS EXPENSE AND THE ELECTRICAL SYSTEM SHALL BE PROVEN SATISFACTORY FOR OPERATION AND FREE FROM DEFECTS. PARTICULAR ATTENTION SHALL BE PAID TO THE BALANCING OF THE SINGLE PHASE LOADS ON THE THREE PHASE SYSTEM. ANY AND ALL DEFECTS SHALL BE PROMPTLY REMEDIED. 1. THE CONTRACTOR SHALL TEST ALL WIRING AND CONNECTIONS FOR CONTINUITY AND GROUNDS BEFORE FIXTURES ARE CONNECTED AND HE SHALL
- DEMONSTRATE BY MEGGER TEST THE INSULATION RESISTANCE OF ANY CIRCUIT OR GROUP OF CIRCUITS, WHERE SUCH INSULATION RESISTANCE TEST INDICATES THE POSSIBILITY OF FAULTY INSULATION. THE CONTRACTOR SHALL LOCATE THE POINT OR POINTS OF SUCH FAULTY INSULATION, AND HE SHALL PULL OUT THE CONDUCTOR AT FAULT, REPLACE WITH NEW CONDUCTORS, AND DEMONSTRATE BY FURTHER TEST THE ELIMINATION OF SUCH FAULT AT HIS OWN EXPENSE.
- 2. READINGS PHASE-TO-PHASE, PHASE-TO-NEUTRAL & PHASE-TO-GROUND SHALL BE 2 MEGAOHMS OR GREATER.

ALL CONDUIT, NEUTRAL CONDUCTORS OF THE WIRING SYSTEMS, AND ALL ELECTRICAL EQUIPMENT SHALL BE GROUNDED. THE GROUND CONNECTION OF THE ELECTRICAL SYSTEM NEUTRAL AND CONDUIT SYSTEM SHALL BE MADE AT THE MAIN SERVICE SWITCH OR CIRCUIT BREAKER. ALL FEEDER AND BRANCH CIRCUIT CONDUITS SHALL HAVE A GREEN GROUNDING CONDUCTOR IN ADDITION TO THE PHASE AND NEUTRAL CONDUCTORS. A. A THW COPPER GROUND CONDUCTOR SIZED IN ACCORDANCE WITH THE NEC SHALL BE EXTENDED IN CONDUIT FROM THE MAIN SERVICE EQUIPMENT TO THE POINT OF ENTRANCE OF THE WATER SERVICE. THE CONDUIT SHALL BE BONDED TO THE GROUNDING CONDUCTOR AT EACH END OF THE CONDUIT. CONNECTION TO WATER PIPE SHALL BE BY SUITABLE GROUND CLAMP OR BY LUG CONNECTION TO A PLUGGED TEE. IF FLANGED PIPES ARE ENCOUNTERED, CONNECTION SHALL BE MADE WITH THE LUG BOLTED TO THE SUPPLY SIDE OF THE FLANGED CONNECTION. ELECTRICAL BOND SHALL BE ESTABLISHED AROUND THE WATER METER IF APPLICABLE.

SECTION 02 - BASIC MATERIALS AND METHODS

<u>01 REQUIREMENTS OF SECTION 1601 SHALL APPLY.</u>

OF AT LEAST 3" PER 100' TOWARD A DRAINAGE POINT.

- 02 WIRING. ALL WIRING SHOWN ON THE CONTRACT DRAWING SHALL BE IN CONDUIT UNLESS OTHERWISE HEREINAFTER SPECIFIED. A. BRANCH CIRCUIT CONDUCTORS SHALL BE AS INDICATED ON THE DRAWINGS.
- B. CONDUCTORS SHALL BE CONTINUOUS FROM OUTLET TO OUTLET, AND NO SPLICES SHALL BE MADE EXCEPT WITHIN OUTLET OR JUNCTION BOXES. JUNCTION BOXES MAY BE UTILIZED WHERE REQUIRED.
- 03 CONDUIT SYSTEMS. CONDUIT SHALL BE RIGID STEEL CONDUIT, INTERMEDIATE METAL CONDUIT, OR ELECTRICAL METALLIC TUBING (EMT). EMT SHALL NOT BE INSTALLED UNDERGROUND OR IN SLABS ON GRADE.
- A. AT THE CONTRACTOR'S OPTION RIGID SCHEDULE 40 NONMETALLIC CONDUIT (PVC) MAY BE USED IN LIEU OF STEEL CONDUIT WHERE INSTALLED UNDER BUILDING SLABS OR UNDERGROUND, AND SHALL BE INSTALLED IN STRICT ACCORDANCE WITH ARTICLE 352 OF THE NEC. RIGID STEEL CONDUIT SHALL BE USED WHERE BEND GREATER THAN 45 DEGREES ARE REQUIRED. EXPOSED PVC CONDUIT SHALL NOT BE PERMITTED. B. AT THE CONTRACTOR'S OPTION MC CABLE SHALL BE ALLOWED WHEN USED IN STRICT ACCORDANCE WITH THE NEC AND ALL OTHER PERTINENT CODES.

- A. CONDUITS SHALL BE CONCEALED WITHIN WALLS, CEILINGS, AND FLOOR WHERE POSSIBLE. EXPOSED RUNS OF CONDUIT SHALL BE SUPPORTED EVERY 8' WITH APPROVED TYPE SUPPORTS.
- B. GALVANIZED STEEL INSULATION THROAT COMPRESSION RING TYPE FITTINGS SHALL BE USED FOR EMT WORK.
- C. PULL CORDS SHALL BE INSTALLED IN ALL EMPTY CONDUITS. NO CONDULET TYPE FITTINGS SHALL BE ALLOWED ON SERVICE CONDUITS OR ANY OTHER CONDUIT 2" OR LARGER.
- D. WHERE STEEL AND PVC CONDUIT IS INSTALLED UNDERGROUND OR UNDER BUILDING SLABS JOINTS SHALL BE MADE WATERTIGHT. ALL CONDUIT INSTALLED UNDERGROUND SHALL BE ENCASED IN A MINIMUM OF 3" OF CONCRETE WITH 2" SEPARATION BETWEEN ADJACENT CONDUITS. E. UNDERGROUND CONDUIT OUTSIDE THE BUILDING SHALL HAVE A MINIMUM COVER OF 2' AND IF POSSIBLE SHALL BE GRADED SO AS TO HAVE A FALL
- 1. ALL UNDERGROUND STEEL CONDUITS SHALL BE THOROUGHLY COATED WITH TWO COATS OF ASPHALTUM OR BITUMASTIC AND SHALL BE RETOUCHED AS REQUIRED AFTER BEING MADE UP.
- <u>05 SECONDARY CONDUCTORS.</u> A COMPLETE SYSTEM OF CONDUCTORS SHALL BE INSTALLED IN THE RACEWAY SYSTEM. ONLY POWDERED SOAPSTONE OR
- OTHER NON-DELETORIOUS LUBRICANT APPROVED BY THE ENGINEER MAY BE USED IN PULLING CONDUCTORS IN CONDUIT. A. ALL CONDUCTORS SHALL BE COPPER. CONDUCTORS UNLESS OTHERWISE NOTED SHALL BE HEAT AND MOISTURE RESISTANT GRADE,
- THERMOPLASTIC INSULATED, TYPE THW, THWN, THHN, OR XHHW AS APPLICABLE. 1. CONDUCTORS NO. 8 AWG AND LARGER SHALL BE STRANDED COPPER. NO. 12 AWG AND NO. 10 AWG SHALL BE SOLID COPPER.
- B. HOMERUNS MAY BE COMBINED IN ONE CONDUIT, PROVIDED ALL CONNECTIONS ARE IN ACCORDANCE WITH NEC REQUIREMENTS AND THE MAXIMUM
- UNBALANCED CURRENT IN THE NEUTRAL DOES NOT EXCEED THE CAPACITY OF THE CONDUCTOR. C. COLOR CODE. ALL CONDUCTORS, FEEDERS, AND BRANCH CIRCUITS SHALL BE COLOR CODED BY PHASE AND SHALL BE PLAINLY MARKED IN
- ACCORDANCE WITH SECTIONS 210.5(C) AND 200.6 OF THE NEC: COLOR CODES SHALL BE AS FOLLOWS: 1. 120/240 VOLT, 3-PHASE, 4-WIRE HIGH LEG DELTA SYSTEMS: PHASE A, BLACK; PHASE B (HIGH LEG), ORANGE; PHASE C, BLUE; GROUNDED NEUTRAL,
- 2. 120/208 VOLT, 3-PHASE, 4-WIRE SYSTEM: PHASE A, BLACK; PHASE B, RED; PHASE C, BLUE; GROUNDED NEUTRAL, WHITE.
- 3. 277/480 VOLT, 3 PHASE, 4-WIRE SYSTEM: PHASE A, BROWN; PHASE B, ORANGE; PHASE C, YELLOW; GROUNDED NEUTRAL, GREY. 4. GROUNDING CONDUCTORS SHALL BE GREEN FOR ALL SYSTEMS.
- 06 SERVICE. SERVICE ENTRANCE CONDUCTORS SHALL BE INDIVIDUAL CONDUCTORS IN CONDUIT, AS PREVIOUSLY SPECIFIED, FROM THE POWER COMPANY

TRANSFORMER TO SERVICE SECTION OF THE MAIN SERVICE EQUIPMENT, ALL AS INDICATED ON THE DRAWINGS.

- A. PANELBOARDS SHALL BE OF THE DEAD FRONT SAFETY TYPE. THE PANELBOARDS SHALL BE PROVIDED WITH THE SIZE AND NUMBER OF SINGLE, DOUBLE, OR TRIPLE POLE BRANCH CIRCUIT BREAKERS, BOLTED TO THE BUS, AS INDICATED ON THE DRAWINGS. PANELBOARD BUS SHALL BE COPPER. 1. CIRCUIT BREAKERS SHALL BE OF THE AUTOMATIC THERMAL MAGNETIC TYPE, QUICK-MAKE AND QUICK-BREAK FOR MANUAL AND AUTOMATIC OPERATION. ALL MULTI-POLE BREAKERS SHALL BE COMMON TRIP, HANDLE TIES WILL NOT BE ACCEPTABLE. PANELBOARDS SHALL BE PROVIDED WITH A GROUNDING TERMINAL
- BAR BONDED TO THE CABINET OR PANELBOARD FRAME. 2. CIRCUIT BREAKERS FOR ALL TWO(2) AND THREE(3) CIRCUIT HOMERUNS WITH A COMMON NEUTRAL SHALL BE EQUIPPED WITH A "TIE HANDLE" IN ORDER TO SIMULTANEOUSLY DISCONNECT ALL UNGROUNDED CONDUCTORS THAT SHARE A COMMON NEUTRAL IN ACCORDANCE WITH NEC ART. 210.4(A),(B),&(C).
- B. PANELBOARDS USED AS SERVICE EQUIPMENT SHALL HAVE U.L. LISTING AS "SUITABLE FOR USE AS SERVICE EQUIPMENT", AND SHALL BE SO MARKED. C. SQUARE-D PANELBOARD, FUSED SWITCH, AND CIRCUIT BREAKER DESIGNATIONS ARE USED HEREIN AND ON THE DRAWINGS, BUT SIMILAR AND EQUAL PRODUCTS OF G.E., SIEMENS, OR CUTLER HAMMER ARE EQUALLY ACCEPTABLE. ALL CIRCUIT BREAKERS SHALL BE CALIBRATED FOR 40-DEGREES "C" OR BE AMBIENT COMPENSATED. CIRCUIT BREAKERS SHALL HAVE U.L. INTERRUPTING RATINGS AS INDICATED BY CLASS OF CIRCUIT BREAKER SHOWN ON THE DRAWINGS.
- D. ALL 3-PHASE, 4-WIRE GROUNDED NEUTRAL OR 3-PHASE, 3-WIRE POWER OR DISTRIBUTION PANELBOARDS SHALL BE SQUARE-D "HC" WITH CIRCUIT BREAKERS OF NAMES AND TYPE NOTED ON SCHEDULES.
- E. 120/208-VOLT, 3-PHASE, 4-WIRE, GROUNDED SOLID NEUTRAL LIGHTING PANELBOARDS SHALL BE SQUARE-D "NQ". UNLESS OTHERWISE NOTED, 2-POLE CIRCUIT BREAKERS MAY BE RATED FOR 120/240-VOLT AC, COMMON TRIP AND HANDLE. F. 277/480 VOLT, 3-PHASE, 4-WIRE GROUNDED, SOLID NEUTRAL LIGHTING PANELBOARDS SHALL BE SQUARE-D "NF" AND SHALL ACCEPT 2-POLE AND 3-POLE

CIRCUIT BREAKERS.

A. INDIVIDUAL CIRCUIT BREAKERS SHALL BE THE MOLDED CASE TYPE OF THE FRAME AND TRIP RATING NOTED ON THE DRAWINGS IN NEMA 1 ENCLOSURE UNLESS NOTED OTHERWISE. FRAMES LISTED ARE SQUARE-D BUT EQUIVALENT CIRCUIT BREAKERS BY G.E., SIEMENS, OR WESTINGHOUSE ARE EQUALLY ACCEPTABLE. 1. ALL CIRCUIT BREAKERS SHALL BE AMBIENT COMPENSATED OR CALIBRATED FOR 40-DEGREES "C". CIRCUIT BREAKERS SHALL HAVE U.L. INTERRUPTING RATINGS AS INDICATED BY CLASS OF CIRCUIT BREAKERS SHOWN ON THE DRAWINGS.

09 DISCONNECTS. A. FUSED DISCONNECTING SWITCHES SHALL BE SQUARE-D TYPE "H" IN NEMA 1 ENCLOSURES, RATED FOR 250 OR 600-VOLTS AS APPLICABLE. UNLESS

- OTHERWISE NOTED, FUSES SHALL BE BUSS "FUSETRONS", OR APPROVED EQUAL. B. UNFUSED DISCONNECTING SWITCHES SHALL BE TYPE "H" IN NEMA 1 OR 3R AS APPLICABLE ENCLOSURES.
- 1. SIMILAR AND EQUIVALENT EQUIPMENT AS MANUFACTURED BY G.E., SIEMENS, OR WESTINGHOUSE IS EQUALLY ACCEPTABLE. SWITCHES USED AS SERVICE SWITCHES SHALL BEAR SUCH U.L. LABEL, AND NAMEPLATE ON SWITCH SHALL SO INDICATE.
- 10 DEVICE PLATES. ALL DEVICE PLATES ON FLUSH OUTLETS SHALL BE "302" STAINLESS STEEL AND ON SURFACE BOXES SHALL BE GALVANIZED STEEL.
- DEVICES SHALL BE GRAY, UNLESS OTHERWISE NOTED. 11 OUTLET AND JUNCTION BOXES. OUTLET BOXES SHALL BE GALVANIZED SHEET STEEL OF A CLASS TO SATISFY THE CONDITIONS FOR EACH OUTLET.
- JUNCTION ND PULL BOXES SHALL BE CODE GAUGE. GALVANIZED SHEET METAL BOXES SHALL NOT BE LESS THAN THE MINIMUM SIZE RECOMMENDED BY THE NEC. EACH OUTLET AND JUNCTION BOX SHALL BE FITTED WITH AN APPROPRIATE COVER.
- 12. PANELBOARD CABINETS CABINETS FOR PANELBOARDS, UNLESS OTHERWISE NOTED, SHALL HAVE A MINIMUM WIDTH OF 20" AND SHALL BE PROVIDED WITH NO LESS THAN 4" WIRING GUTTERS AT THE SIDES, TOP, AND BOTTOM. CABINETS SHALL BE CONSTRUCTED OF ZINC COATED SHEET STEEL. PANELBOARDS SHALL BE OF THE DEAD FRONT SAFETY TYPE. THE PANELBOARDS SHALL BE PROVIDED WITH THE SIZE AND NUMBER OF SINGLE, DOUBLE, OR TRIPLE POLE BRANCH CIRCUIT BREAKERS. PANELBOARD BUS SHALL BE COPPER.
- 13 DEMOLITION AND ALTERATION. THIS CONTRACTOR SHALL EITHER REMOVE COMPLETELY, OR MECHANICALLY OR ELECTRICALLY SECURE ALL ELECTRICAL CONDUIT, CONDUCTORS, AND OUTLETS WHICH ARE SHOWN AS BEING ABANDONED. ELECTRICAL MATERIALS AND EQUIPMENT WHICH ARE SHOWN AS BEING REMOVED OR REPLACED SHALL, UNLESS OTHERWISE NOTED TO BE RELOCATED OR REUSED, BE TURNED OVER TO THE OWNER. ALL EXISTING ELECTRICAL OUTLETS NOT SHOWN AS BEING ABANDONED SHALL BE RECONNECTED.

ELECTRICAL SYMBOLS

THE ELECTRICAL SYMBOLS HEREINAFTER LISTED ARE A BASIC STANDARD FOR ALL PROJECTS AS APPLICABLE. EACH AND EVERY SYMBOL MAY NOT NECESSARILY APPEAR ON THE SPECIFIC PROJECT DRAWINGS. ALL DIMENSIONS ARE TO TOP OF THE OUTLET BOX UNLESS OTHERWISE NOTED. THE ELECTRICAL CONTRACTOR SHALL COORDINATE THE EXACT OUTLET HEIGHT WITH COUNTERS, BACKSPLASHES, WAINSCOT, AND EQUIPMENT TO ASSURE PROPER MOUNTING

CONDUIT CONCEALED IN OR ABOVE CEILING, IN OVERHEAD SLAB OR IN WALL, AS APPLICABLE. CONDUIT CONCEALED IN OR BELOW FLOOR, BELOW GRADE OR IN WALL, AS APPLICABLE.

CONDUIT EXPOSED ON SURFACE OF CEILING, OVERHEAD STRUCTURE OR WALL AS APPLICABLE.

NUMBER OF CURRENT CARRYING CONDUCTORS PLUS NEUTRAL IF REQUIRED. EQUIPMENT GROUNDING CONDUCTORS SIZED PER N.E.C. ARE NOT INCLUDED IN QUANTITY INDICATED, BUT SHALL BE INCLUDED IN ALL RACEWAYS.

CONDUIT TURNING UP/CONDUIT TURNING DOWN.

CONDUIT STUB UP 6" AFF WITH CONNECTION TO EQUIPMENT.

HOMERUN TO PANELBOARD, MOTOR CONTROL CENTER, OR SWITCHBOARD AS APPLICABLE.

SINGLE OR DOUBLE POLE SWITCH AS INDICATED, MOUNTED 48" AFF.

JUNCTION BOX SIZED PER N.E.C. UNLESS OTHERWISE INDICATED.

JUNCTION BOX WITH FLEX CONNECTION TO EQUIPMENT.

THREE-WAY OR FOUR-WAY SWITCH AS INDICATED, MOUNTED 48" AFF.

SWITCH AS SPECIFIED ABOVE WITH CAST WEATHERPROOF COVER AND OUTLET AND BOX ADAPTER IF REQUIRED.

- SWITCH WITH DIMMING CAPABILITIES. CONTRACTOR TO COORDINATE DIMMING SWITCHES WITH FIXTURE DIMMING PROTOCOLS.

WALL MOUNTED OCCUPANCY SENSOR, WITH DUAL TECHNOLOGY. AUTO ON/OFF. FIELD CHANGEABLE TO VACANCY SENSOR.

- CEILING MOUNTED OCCUPANCY SENSOR, WITH DUAL TECHNOLOGY. AUTO ON/OFF. FIELD CHANGEABLE TO VACANCY SENSOR.
- NEMA 5-20R DUPLEX CONVENIENCE RECEPTACLE MOUNTED 20", UNLESS NOTED OTHERWISE.
- NEMA 5-20R DUPLEX CONVENIENCE RECEPTACLE MOUNTED 48" AFF OR BACKSPLASH.
- RECEPTACLE AS SPECIFIED ABOVE EXCEPT WITH INTEGRATED GROUND FAULT CIRCUIT INTERRUPTER (GFCI).
- CONCEALED SERVICE FLOOR OUTLET WITH ONE OR TWO NEMA 5-15R DUPLEX RECEPTACLES AS INDICATED. LEGRAND NO. RFB2, RFB4 OR RFB6 WITH APPLICABLE FACEPLATES AS REQUIRED.
- CONCEALED SERVICE FLOOR OUTLET FOR POWER (NEMA 5-15R DUPLEX) AND COMMUNICATIONS. LEGRAND NO. RFB2, RFB4 OR RFB6 WITH APPLICABLE FACEPLATES AS REQUIRED.
- GFCI RECEPTACLE SIMILAR TO THOSE SPECIFIED ABOVE EXCEPT U.L. "WR" (WEATHER-RESISTANT) LISTED AND PROVIDED WITH A WEATHERPROOF COVER.
- DEAD FRONT GFCI PROTECTIVE DEVICE WITH TEST/RESET BUTTONS AND STATUS INDICATOR AS REQUIRED PER NEC ARTICLE 210.8 OR 422.5. INSTALL IN READILY ACCESSIBLE LOCATION THAT IS NEAR THE PROTECTED APPLIANCE RECEPTACLE. PROVIDE ENGRAVED NAMEPLATE INDICATING PROTECTED OUTLET OR APPLIANCE (i.e., DISHWASHER, REFRIGERATOR, VENDING MACHINE, ETC.).
- WALL OUTLET FOR SECU DATA. 20" TO OF BOX, OR 48" TO TOP OF BOX IF DENOTED WITH DOT. PROVIDE 3/4" EC TO ABOVE ACCESSIBLE
- WALL OUTLET FOR LCCU TELECOMMUNICATIONS. 20" TO TOP OF BOX, OR 48" TO TOP OF BOX IF DENOTED BY DOT. PROVIDE 3/4" EC TO ABOVE ACCESSIBLE CEILING. COORDINATE WITH OWNER.
- WALL OUTLET FOR LCCU DATA. 20" TO TOP OF BOX, OR 48" TO TOP OF BOX IF DENOTED BY DOT. PROVIDE 3/4" EC TO ABOVE ACCESSIBLE CEILING. COORDINATE WITH OWNER.
- LIGHTING POWER OR DISTRIBUTION PANELBOARD AS INDICATED AND SCHEDULED.
- EQUIPMENT CONTROL PANEL, CABINET, OR MODULE AS APPLICABLE.
- DISCONNECT. NUMERALS INDICATE SIZE, POLES, AND FUSETRON SIZE. WP INDICATES NEMA 3R ENCLOSURE OR WITH OTHER ENCLOSURE AS INDICATED. SWITCHES WITHOUT FUSETRON SIZING ARE TO BE UNFUSED.
- CIRCUIT BREAKER NUMERALS INDICATE AMPERE RATING, POLES, AND FRAME. WP INDICATES 3R ENCLOSURE OR WITH OTHER ENCLOSURE AS INDICATED.
- MANUAL MOTOR STARTER SINGLE PHASE.
- LIGHTING FIXTURE DRAWN APPROXIMATELY TO SCALE. TYPE AS INDICATED. SEE FIXTURE SCHEDULE FOR DESCRIPTION.
- STRIP FIXTURE, TYPE AS INDICATED. SEE FIXTURE SCHEDULE FOR DESCRIPTION.
- CEILING FIXTURE SURFACE, PENDANT OR RECESSED LED, INCANDESCENT, OR H.I.D. TYPE AS INDICATED. SEE FIXTURE SCHEDULE FOR
- WALL FIXTURE SURFACE PENDANT, RECESSED LED, INCANDESCENT, OR H.I.D. TYPE AS INDICATED. SEE FIXTURE SCHEDULE FOR \bigcirc H
- LIGHTING FIXTURE AS SPECIFIED ABOVE, DESIGNATED AS "NITE LIGHTING". SEE LIGHTING FIXTURE NOTES.



- LIGHTING FIXTURE AS SPECIFIED ABOVE EQUIPPED WITH UNIT BATTERY SYSTEM SELF CONTAINED WITHIN EACH FIXTURE, OR ON EMERGENCY CIRCUIT. PROVIDE ADDITIONAL, UNSWITCHED HOT FOR BATTERY CHARGING CIRCUIT. SWITCH FIXTURE WITH NON-EMERGENCY FIXTURES IN ROOM UNLESS NOTED OTHERWISE.
- $+\otimes$ $|\otimes|$ SINGLE FACED EXIT SIGN; WALL OR CEILING MOUNTED AS INDICATED. SEE LIGHTING FIXTURE SCHEDULE FOR SPECIFICATIONS. CONNECTION TO EXHAUST FAN NUMBER AS INDICATED. COORDINATE CONTROLS WITH MECHANICAL CONTRACTOR. PROVIDE MANUAL
- CONNECTION TO BUILDING MOUNTED SIGN. COORDINATE CONTROLS AND CONNECTION REQUIREMENTS WITH SIGN VENDOR AND WIRE
- COMPLETE. \triangle _{ATM} CONNECTION TO ATM. COORDINATE CONNECTION REQUIREMENTS WITH ATM MANUFACTURER AND WIRE COMPLETE.
- POWER CONNECTION FOR DOOR CONTACTS. SEE E201 FOR ADDITIONAL INFORMATION.
- LIGHTING CONTROL PANEL. SEE 4/E401 FOR ADDITIONAL INFORMATION.

<u>LIGHTING FIXTURE NOTES</u>

LIGHTING FIXTURES AND LAMPS. ALL FIXTURES SHALL BE UL LISTED AND SUPPORTED IN ACCORDANCE WITH ARTICLE 410 OF NEC. LED EMITTERS SHALL HAVE CORRELATED COLOR TEMPERATURE OF 3500K. LED FIXTURES WITH 0-10V DIMMING SHALL HAVE ISOLATED DRIVERS.

FIXTURE TYPE DESIGNATIONS ARE KEYED SUCH THAT THE FIRST LETTER IN THE FIXTURE TYPE INDICATES THE GENERAL TYPE OF FIXTURE, AND THE SECOND LETTER INDICATES THE SPECIFIC FIXTURE UNDER THE GENERAL DESIGNATION.

> FIRST LETTER FIRST LETTER F= FLANGED TROFFER W= WALL BRACKETS G= LAY-IN TROFFER R= RECESSED FIXTURE S= SURFACE FIXTURE C= CEILING FIXTURE

FIRST LETTER I= INDUSTRIAL FIXTURE E = EMERGENCY/EGRESS FIXTURE 0= OUTDOOR AREA LIGHTING A= MISCELLANEOUS

LENS FOR ALL FLAT LENS TYPE FIXTURES SHALL BE CLEAR PRISMATIC ACRYLIC AND SHALL BE .125 INCH MINIMUM THICKNESS.

P= PENDANT OR SUSPENDED

ALL FIXTURES SHALL BE SECURELY SUPPORTED IN ACCORDANCE WITH NEC ARTICLES 410.30, 410.36, AND 314.27. ALL RECESSED FIXTURES SHALL COMPLY WITH NEC ARTICLE 410.64.

SWITCHES SHALL BE FURNISHED & INSTALLED IN ACCORDANCE WITH NEC ARTICLE 404. WHERE VOLTAGES BETWEEN ADJACENT DEVICES EXCEEDS 300 VOLTS, A U.L. LISTED BARRIER PER NEC 404.8(B) MUST SEPARATE THESE SWITCHES. PER NEC 404.8(C), WHERE A 120V & 277V CIRCUIT ARE CONTROLLED FROM A 2-CIRCUIT SWITCH, SWITCH SHALL BE LISTED AND MARKED FOR MULTI-CIRCUIT USE OR HAVE A VOLTAGE RATING THAT IS GREATER THAN THE LINE-TO-LINE VOLTAGE OF THE HIGHER VOLTAGE USED. WIRE INSULATION SHALL BE RATED AT 600 VAC.

NITE LIGHTING: LIGHTING FIXTURES DESIGNATED BY OR SHALL BE KNOWN AS "NITE LIGHTING" AND SHALL BE STANDARD LIGHTING FIXTURES AS SPECIFIED, CONNECTED

EMERGENCY AND EXIT LIGHTING (EGRESS LIGHTING) SHALL UPON FAILURE OF NORMAL POWER, BE AUTOMATICALLY SUPPLIED FROM ITS OWN EMERGENCY UNIT BATTERY SYSTEM,

A. EXIT FIXTURES SHALL BE SPECIFIED IN THE FIXTURE SCHEDULE COMPLETE UNIT SHALL BE UL LISTED AND CAPABLE OF A MINIMUM OF 90 MINUTES EMERGENCY OPERATION AND SHALL HAVE AUTOMATIC. SOLID STATE CHARGER AND SEALED. RECHARGEABLE LEAD DIOXIDE BATTERY.

B. <u>EMERGENCY LIGHTING FIXTURES</u> DESIGNATED BY OR SHALL BE STANDARD FIXTURES AS SPECIFIED, EQUIPPED WITH EMERGENCY LIGHTING FEATURES. UNIT COMPONENTS SHALL CONSIST OF HIGH TEMPERATURE, SEALED, NICKEL CADMIUM BATTERY, ENCAPSULATED SOLID STATE INVERTER/CHARGER TO PROVIDE ELECTRONIC SWITCHING, BATTERY CHARGING AND EMERGENCY LAMP OPERATION. SYSTEM SHALL BE UL LISTED AND CAPABLE OF A MINIMUM OF 90 MINUTES OPERATION AT 1400 LUMENS.

LIGHTING FIXTURE SCHEDULE

TYPE	LAMP	DESCRIPTION	MANUFACTURER	MODEL	APPARENT LOAD	VOLTAG
AA	LED 3500K 2030L	2' NARROW LED STRIP LIGHT FOR LINEAR COVE APPLICATION, DIFFUSE SNAP-ON LENS, CODE-GAUGE COLD ROLLED STEEL CONSTRUCTION, 0-10V DIMMING	LITHONIA	ZL1D L24 1500LM FST MVOLT 35K 80CRI WH	17	120
EA	LED	EDGE LIT LED EXIT SIGN/EMERGENCY LIGHTING UNIT COMBINATION FIXTURE. CONNECT TO UNSWITCHED LIGHTING CIRCUIT IN AREA SERVED. MUST BURN FOR 90 MINUTES UNDER BUILDING LOSS OF POWER.	EELP	EDGC E UR A RM	3	120
ЕВ	LED	WALL MOUNTED EMERGENCY LIGHTING UNIT. CONNECT TO UNSWITCHED LIGHTING CIRCUIT IN AREA SERVED. MUST BURN FOR 90 MINUTES UNDER BUILDING LOSS OF POWER.	EELP	EM 1 LED	1	120
EC	LED	EMERGENCY TEARDROP FIXTURE WITH INTEGRAL NICAD BATTERY, DIE-CAST ALUMINUM HOUSING, BRONZE FINISH, WET LOCATION LISTED. CONNECT TO UNSWITCHED LIGHTING CIRCUIT IN AREA SERVED. MUST BURN FOR 90 MINUTES UNDER BUILDING LOSS OF POWER.	EELP	DEM LED BR ACEM PC	6	120
GA	LED 3500K 3000L	2'X2' LED TROFFER WITH 0-10 V DIMMING CAPABILITIES.	LITHONIA	STAK 2X2 3000LM 80CRI 35K COL MIN10 ZT MVOLT	24	120
GAE	LED 3500K 3000L	2'X2' LED TROFFER WITH 0-10 V DIMMING CAPABILITIES. PROVIDE EMERGENCY SELF DIAGNOSTIC BATTERY PACK, 10W CONSTANT POWER. MUST BURN FOR 90 MINUTES UNDER BUILDING LOSS OF POWER. CONNECT TO UNSWITCHED LIGHTING CIRCUIT IN AREA SERVED.	LITHONIA	STAK 2X2 3000LM 80CRI 35K COL MIN10 ZT MVOLT E10WLCP	24	120
GB	LED 3500K 4000L	2'X4' LED TROFFER WITH 0-10 V DIMMING CAPABILITIES.	LITHONIA	STAK 2X4 4000LM 80CRI 35K COL MIN10 ZT MVOLT	33	120
OA	LED 4000K 22458L	LOW PROFILE LED POLE MOUNTED FIXTURE, WITH TYPE 3 LONG DISTRIBUTION PATTERN. SUITABLE FOR EXTERIOR USE AND DARK SKY COMPLIANT WITH 0 DEGREE TILT. SEE CIVIL PLANS FOR INFORMATION ON POLE SPECIFICATION AND MOUNTING HEIGHT.	SEE CIVIL	SEE CIVIL	167	120
ОВ	LED 4000K 19023L	LOW PROFILE LED POLE MOUNTED FIXTURE, WITH TYPE 4 DISTRIBUTION PATTERN. SUITABLE FOR EXTERIOR USE AND DARK SKY COMPLIANT WITH 0 DEGREE TILT. SEE CIVIL PLANS FOR INFORMATION ON POLE SPECIFICATION AND MOUNTING HEIGHT.	SEE CIVIL	SEE CIVIL	134	120
00	LED 4000K 24421L	LOW PROFILE LED POLE MOUNTED FIXTURE, WITH TYPE 5 LONG SQUARE DISTRIBUTION PATTERN. SUITABLE FOR EXTERIOR USE AND DARK SKY COMPLIANT WITH 0 DEGREE TILT. SEE CIVIL PLANS FOR INFORMATION ON POLE SPECIFICATION AND MOUNTING HEIGHT.	SEE CIVIL	SEE CIVIL	167	120
PA	LED 3500K 3360L	5' EDGE LIGHT RING FIXTURE, PENDANT MOUNTED. 0-10 V DIMMING REMOTE DRIVER,	OCL	A02 P1EM 60 MW SMP LED1/35K UNV 48 DM1	56	120
РВ	LED 3500K 8300L	CLUSTER OF 3, EDGE LIT LED RING FIXTURES, PENDANT MOUNTED AT DIFFERENT HEIGHTS AND ORIENTATIONS.	OCL	A02 P3DB 60 MW SMP LED1/35K UNV 38 DM1	140	120
PC	LED 3500K 2000L	4' LED PENDANT FIXTURE WITH 2' APERTURE. COORDINATE EXACT MOUNTING HEIGHT AND LOCATION WITH ARCHITECTURAL SLOT FEATURE. FIXTURE WITH 0-10 V DIMMING DRIVER AND AIRCRAFT CABLE MOUNTING.	PINNACLE ARCHITECTURAL LIGHTING	EX2D BW N 835 4 MAC48G1 U FSD 1 0 S	16	120
PD	LED 3500K 2000L	4' LED PENDANT FIXTURE WITH 4' APERTURE. COORDINATE EXACT MOUNTING HEIGHT AND LOCATION WITH ARCHITECTURAL SLOT FEATURE. FIXTURE WITH 0-10 V DIMMING DRIVER AND AIRCRAFT CABLE MOUNTING.	PINNACLE ARCHITECTURAL LIGHTING	EX4D BW N 835SO 4 MAC48G1 U FSD 1 0 S	16	120
RA	LED 3500K 1500L	6" RECESSED LED DOWNLIGHT, IC RATED, WITH 0-10 V DIMMING CAPABILITIES.	GOTHAM	IVO6 D 15LM 35K 50CRI WD MIN10 MVOLT ZT ICAT P AR LSS F	13	120
RB	LED 4000K 1851L	RECESSED, LOW PROFILE, LED LIGHT SUITABLE FOR EXTERIOR LIGHTING. COORDINATE MOUNTING OF FIXTURE INSIDE CANOPY WITH CANOPY VENDOR.	BEGA	B24245 K4 BLK	17	120
WA	LED 4000K 16134L	WALL MOUNTED LED SCONCE, SUITABLE FOR EXTERIOR APPLICATIONS. FIXTURE WITH ALUMINUM HOUSING, AND TYPE IV FORWARD DISTRIBUTION. MOUNT AT 14' AFF UNLESS INDICATED OTHERWISE.	LITHONIA	WDGE4 LED P2 40K 70CRI RFT MVOLT SRM DDBXD	106	120
WB	LED 4000K 6058L	WALL MOUNTED LED SCONCE, SUITABLE FOR EXTERIOR APPLICATIONS. FIXTURE WITH ALUMINUM HOUSING, AND TYPE IV FORWARD DISTRIBUTION. MOUNT AT 14' AFF UNLESS INDICATED OTHERWISE.	LITHONIA	WDGE3 LED PO 40K 70CRI RFT MVOLT SRM DDBXD	41	120
WC	LED 3500K 1200L	2' WALL MOUNTED LED STRIP WITH SQUARE FROSTED ACRYLIC LENS.	LITHONIA	WL2 12L GZ10 LP835	12	120

ELECTRICAL SYSTEM

METHOD OF COMPLIANCE:

ENERGY CODE: □ PRESCRIPTIVE ☐ PERFORMANCE ☐ PRESCRIPTIVE ASHRAE 90.1: ☐ PERFORMANCE

LIGHTING SCHEDULE: (EACH FIXTURE TYPE) SEE FIXTURE SCHEDULE LAMP TYPE REQUIRED IN FIXTURE NUMBER OF BALLASTS IN FIXTURE NUMBER OF LAMPS IN FIXTURE TOTAL WATTAGE PER FIXTURE

BALLAST TYPE USED IN THE FIXTURE TOTAL INTERIOR WATTAGE SPECIFIED = 2437 TOTAL ALLOWED = 3820

TOTAL EXTERIOR WATTAGE SPECIFIED = 889 TOTAL ALLOWED = ADDITIONAL PRESCRIPTIVE COMPLIANCE:

☐ 406.2 MORE EFFICIENT MECHANICAL EQUIPMENT

 □ 406.3 REDUCED LIGHTING POWER DENSITY ☐ 406.4 ENHANCED LIGHTING CONTROLS

☐ 406.5 ON-SITE SUPPLY OF RENEWABLE ENERGY ☐ 406.6 DEDICATED OUTDOOR AIR SYSTEM

☐ 406.7 HIGHER EFFICIENCY SERVICE WATER HEATING

☐ NOT APPLICABLE



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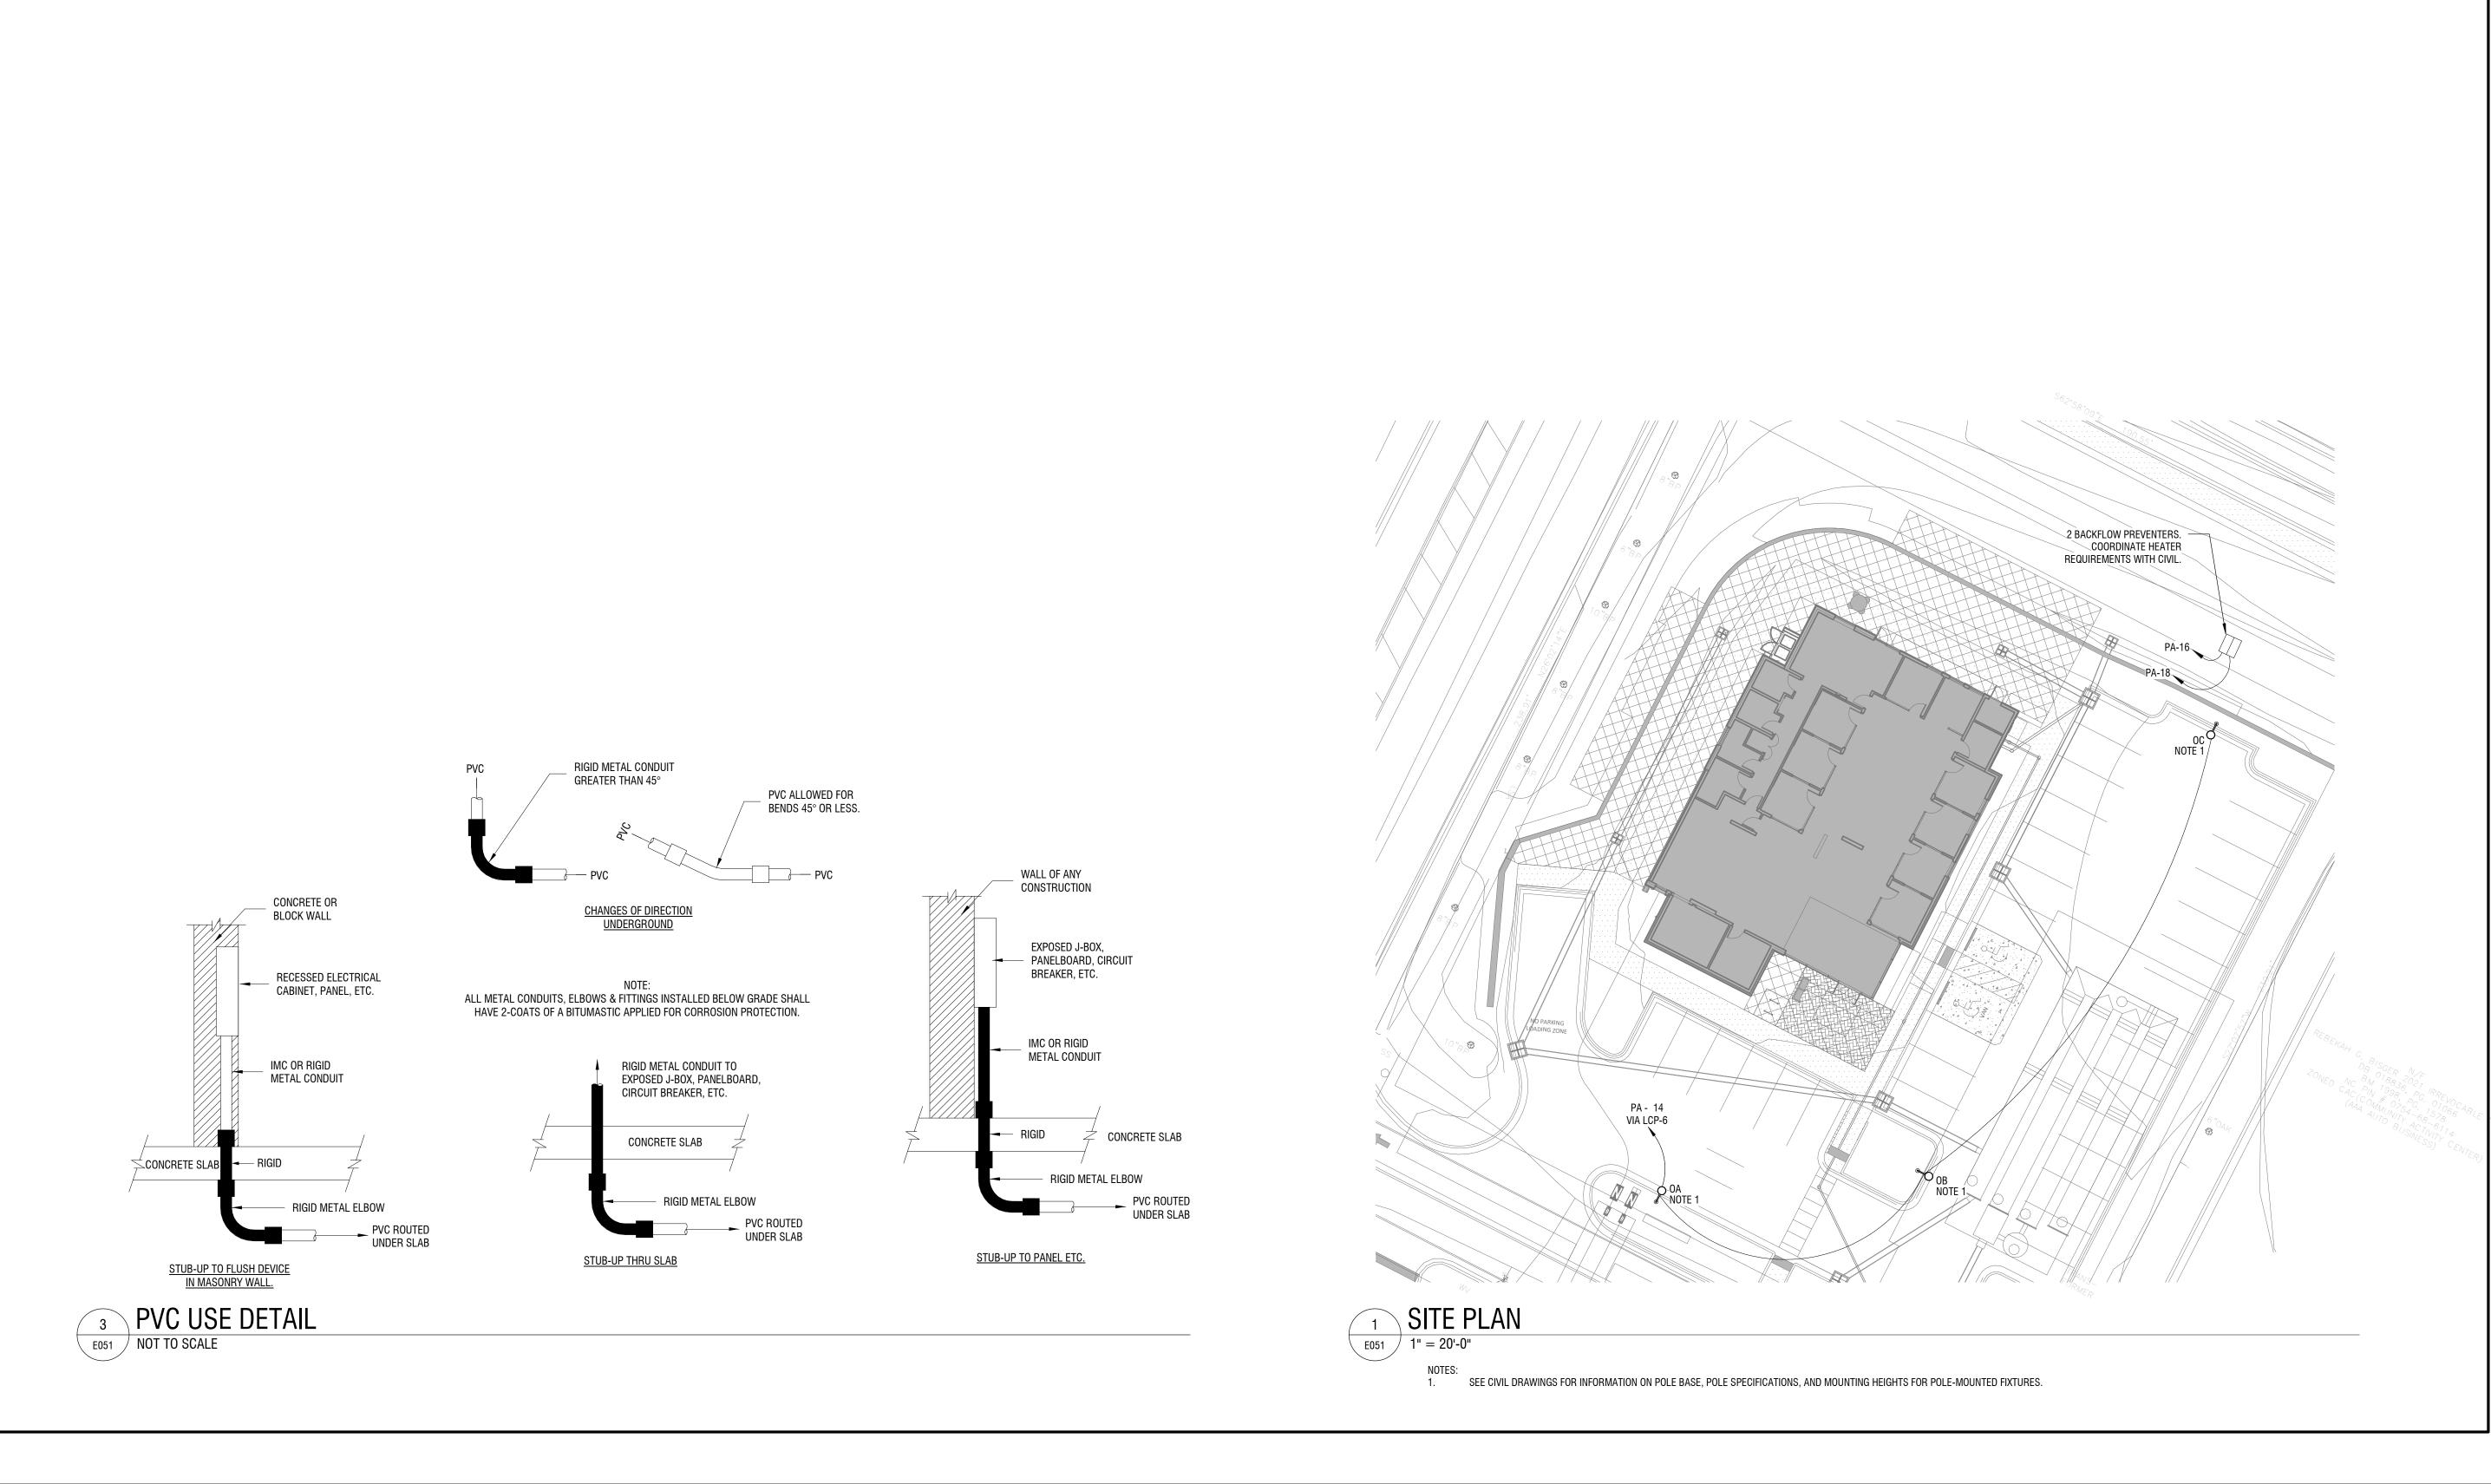
LCCU - Morrisville Site Adapt 9521 Chapel Hill RD. Morrisville, NC 27560

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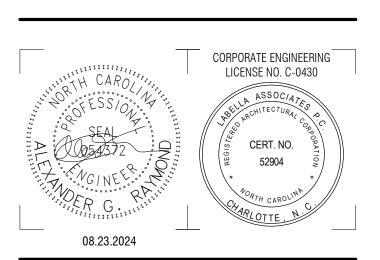
ELECTRICAL COVER SHEE

DRAWING NUMBER:

DRAWING NAME:







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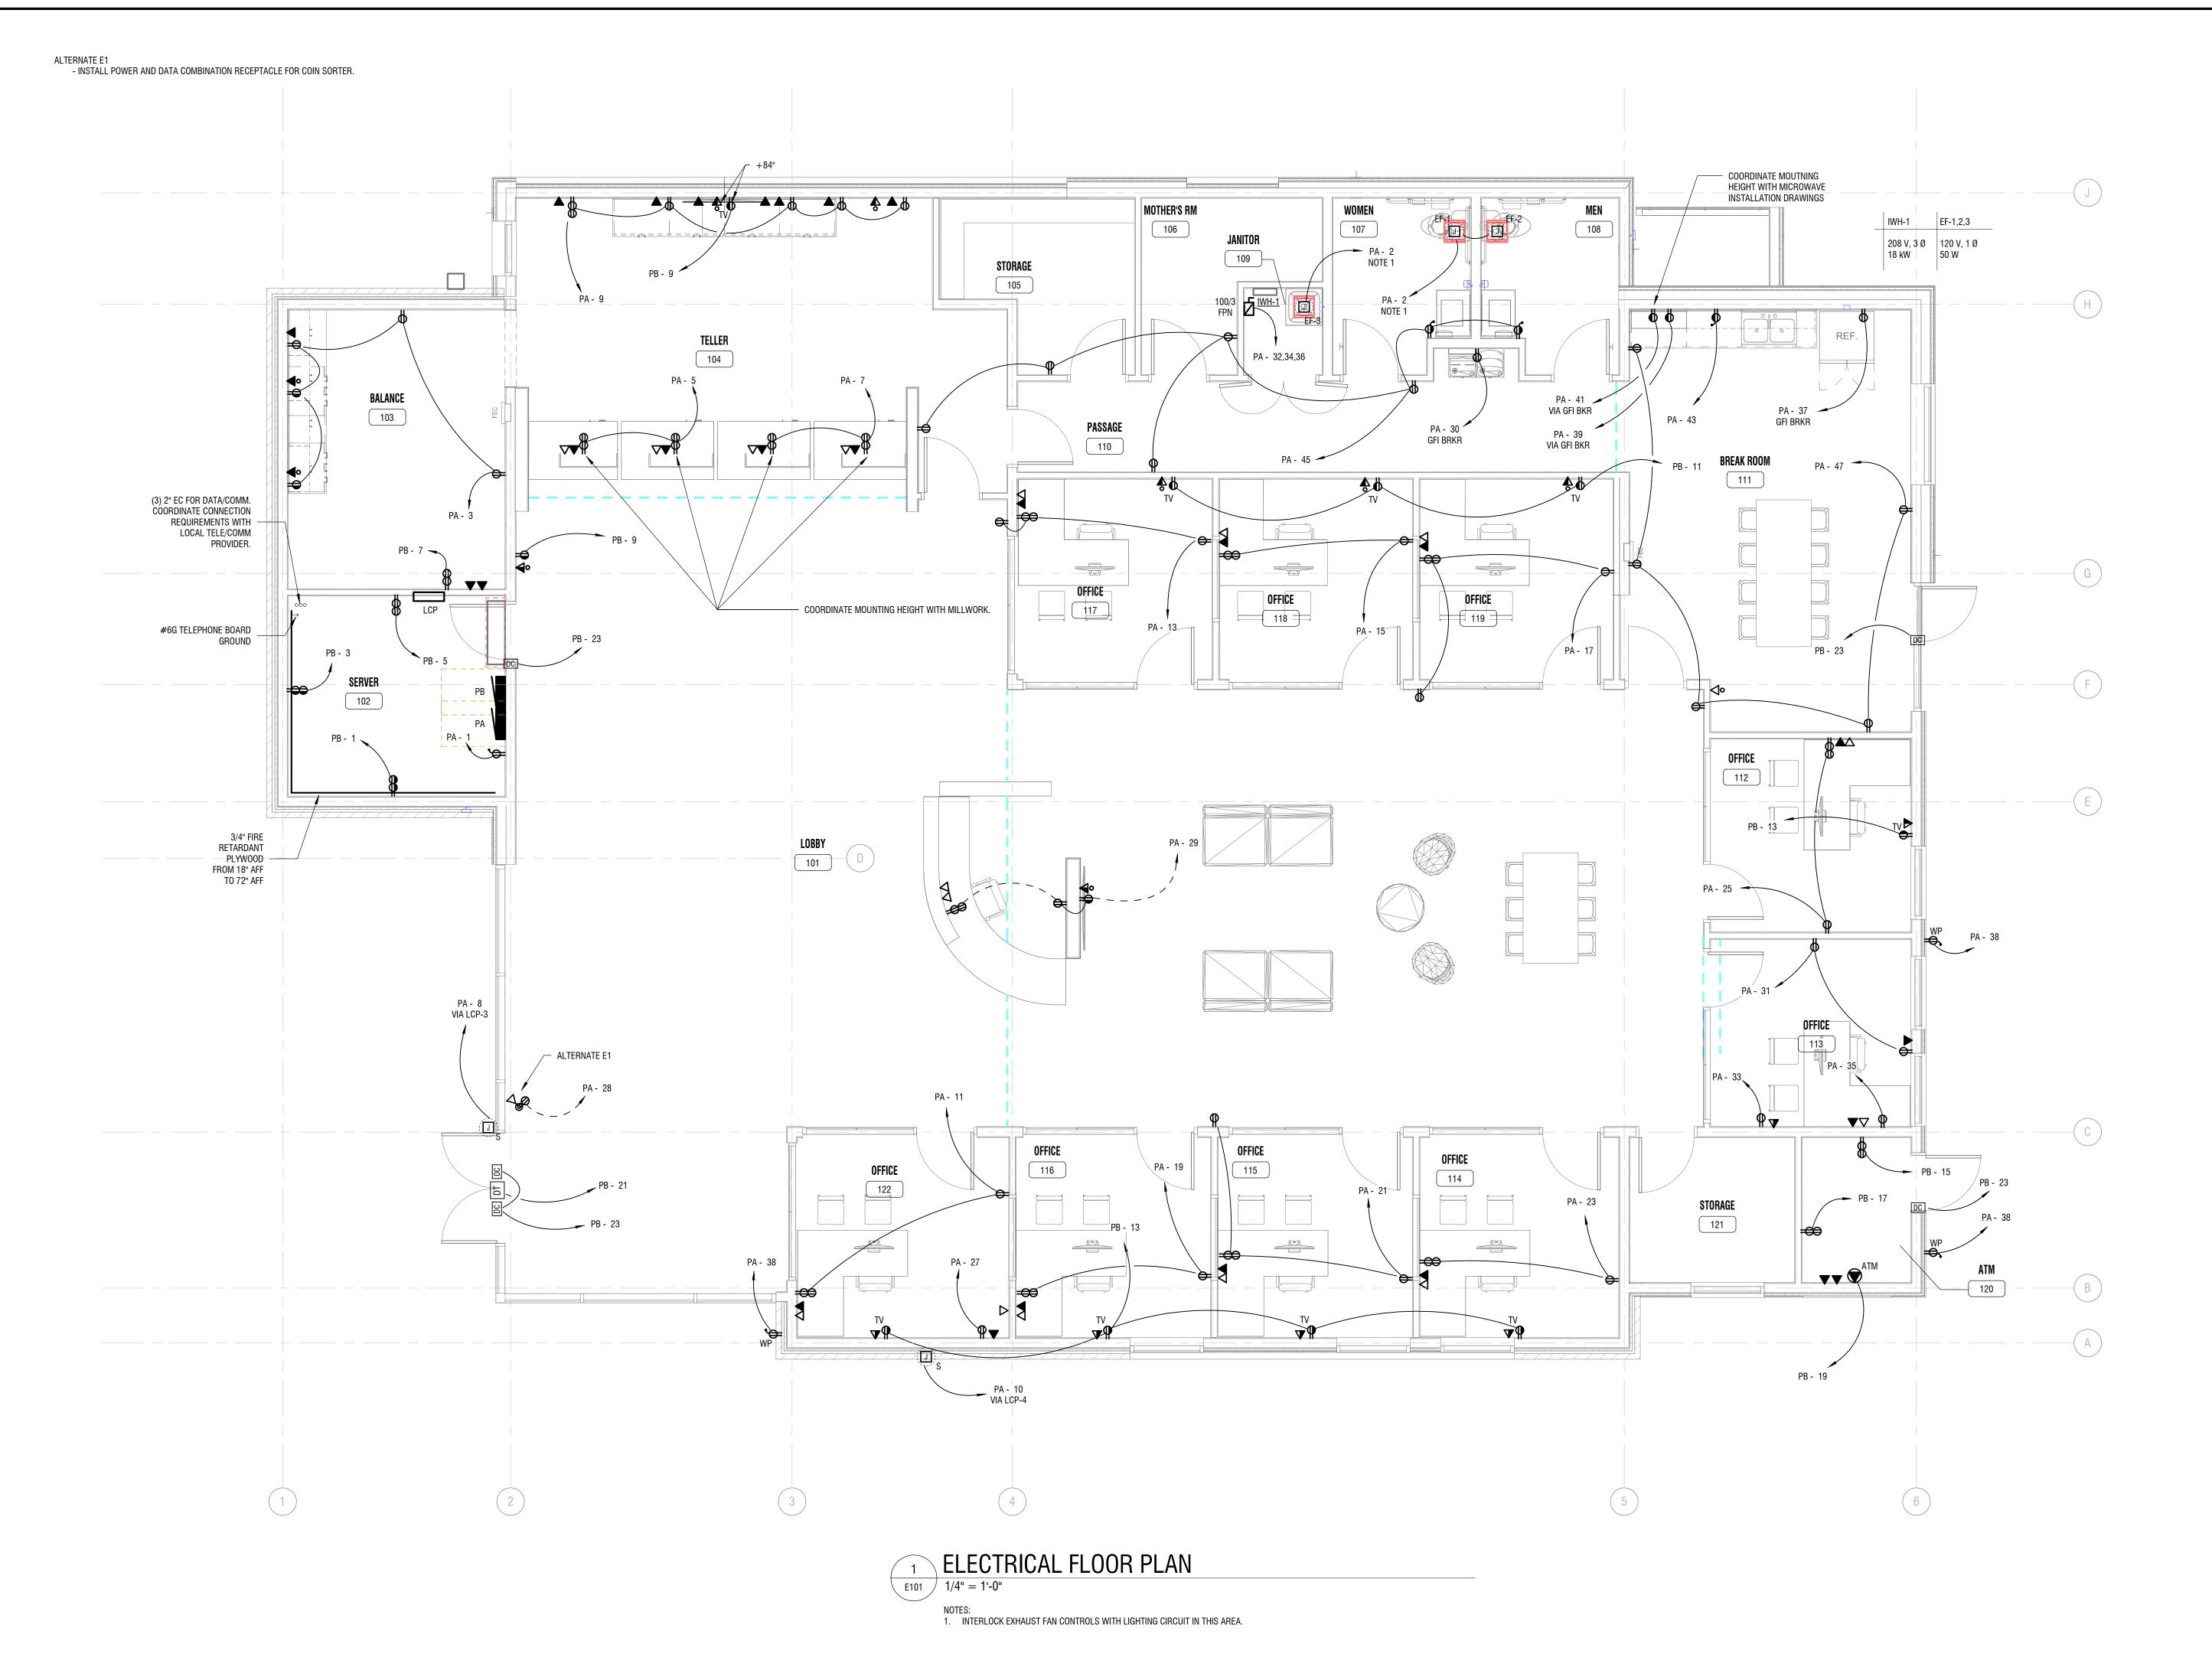


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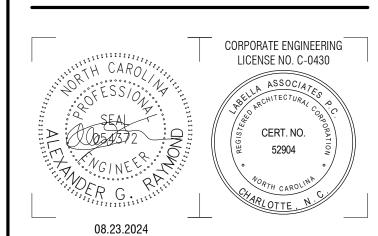
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OR:	BID SET	
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ELECTRICAL SITE PLAN

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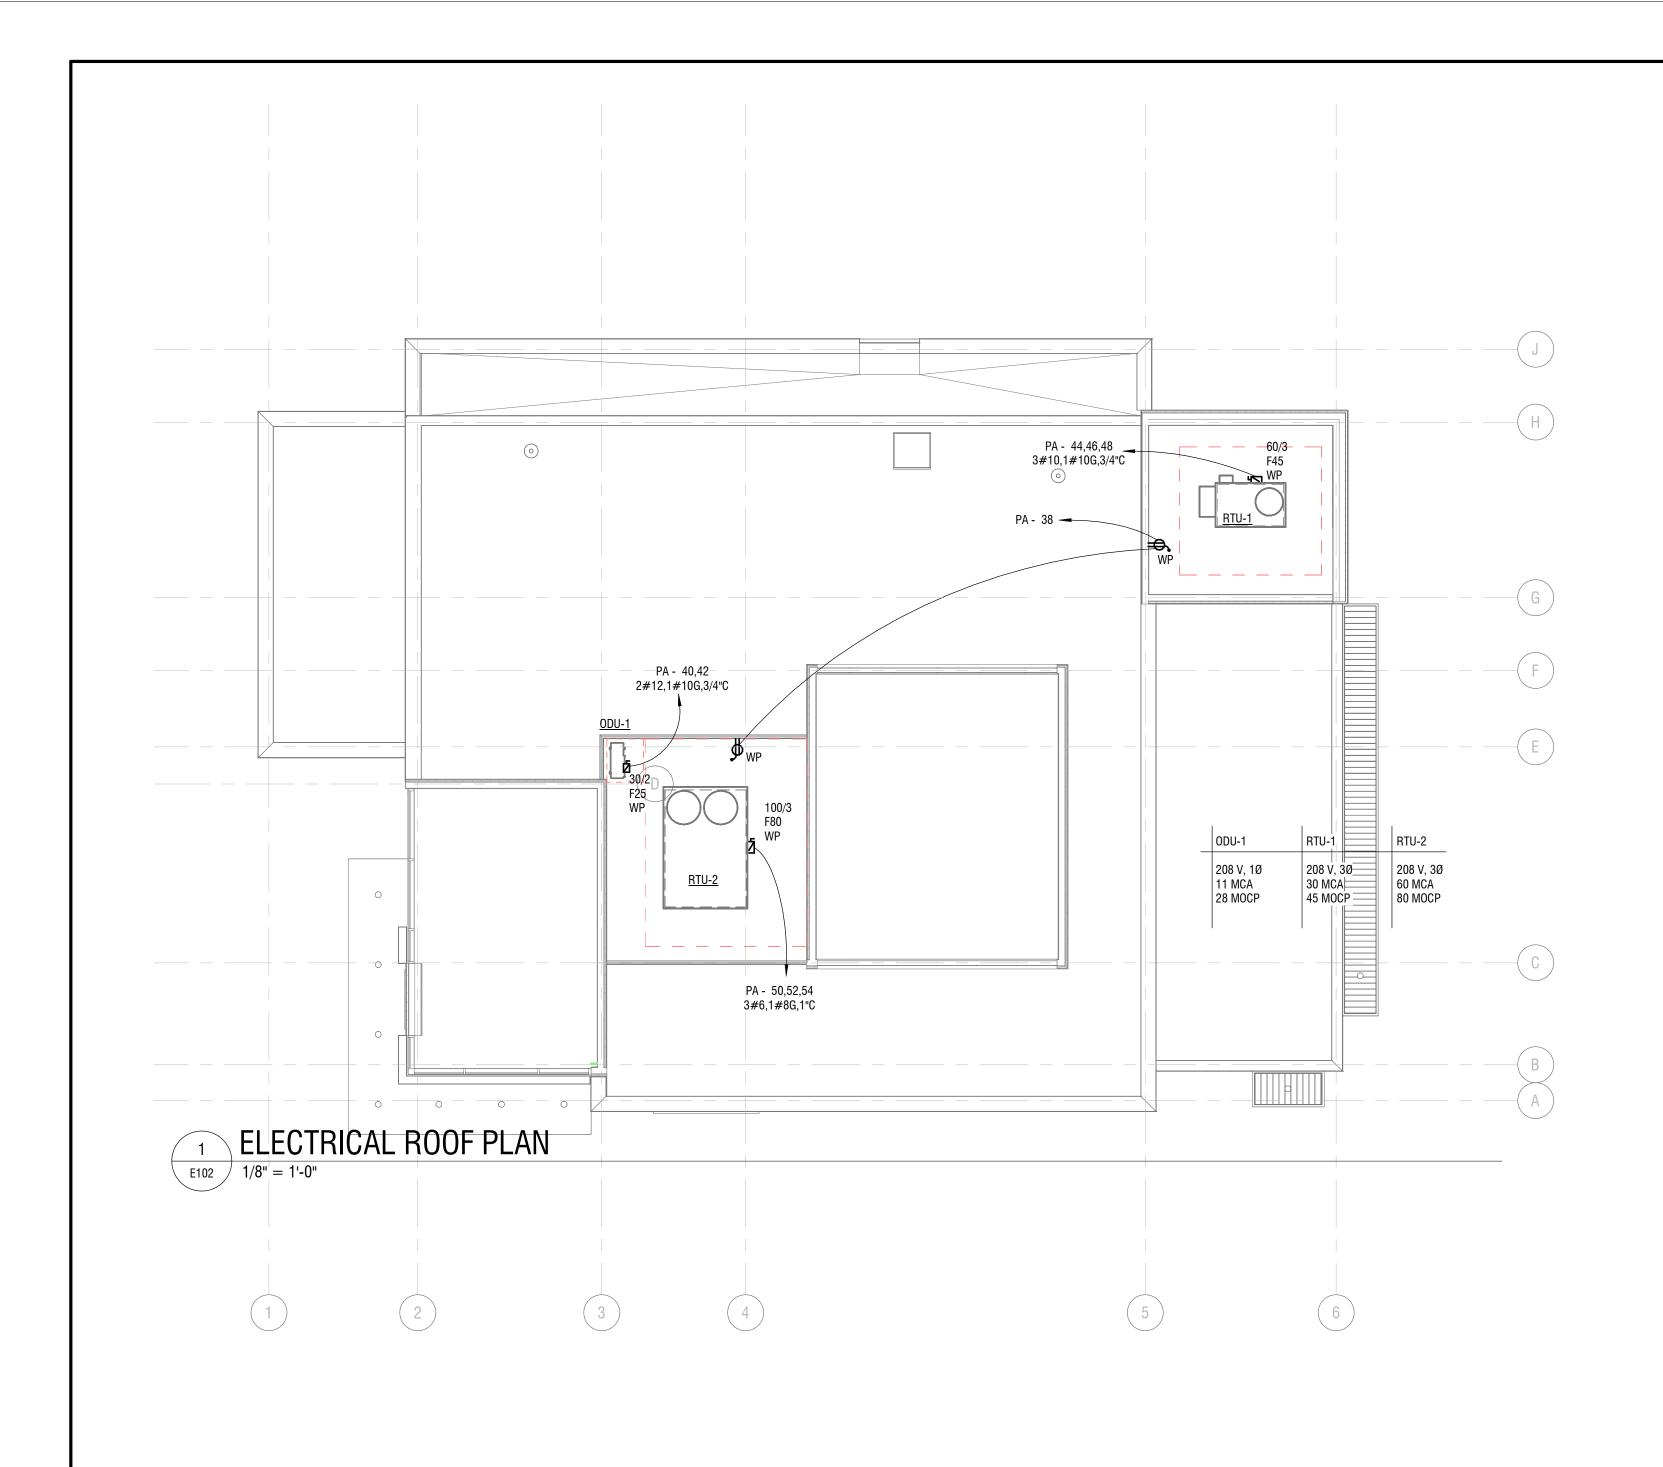


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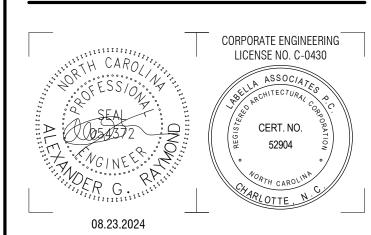
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ELECTRICAL FLOOR PLAN

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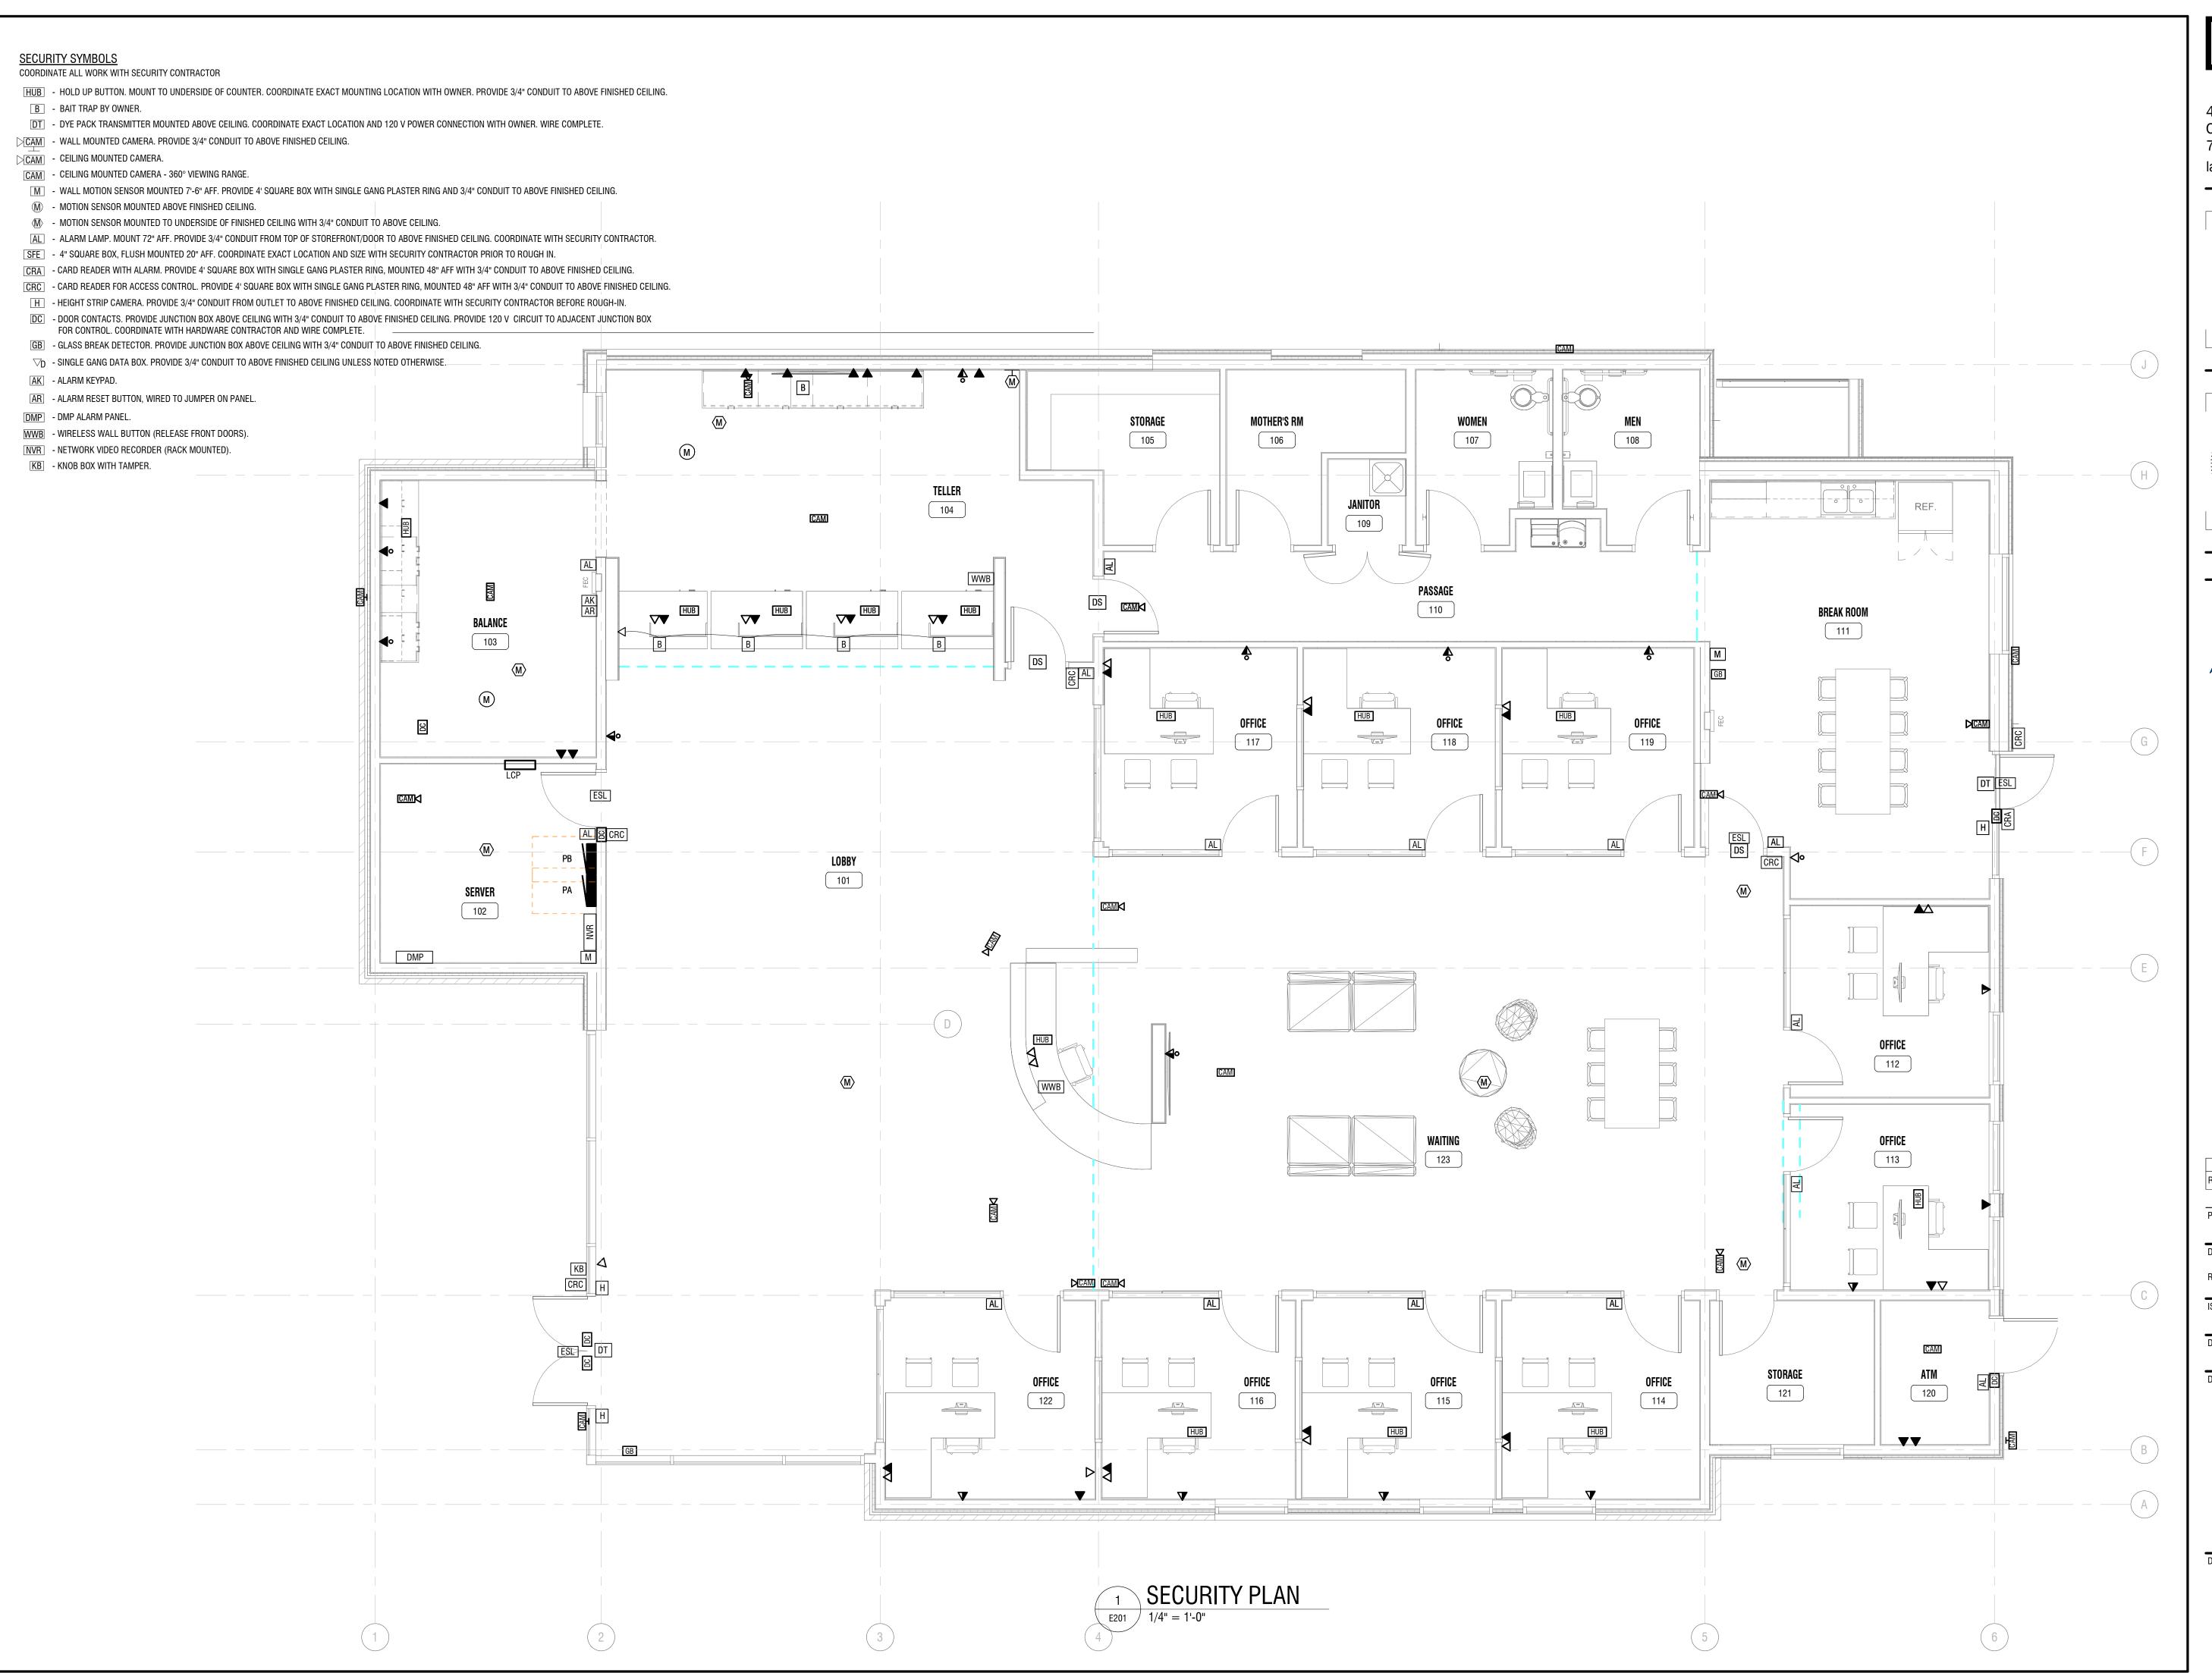


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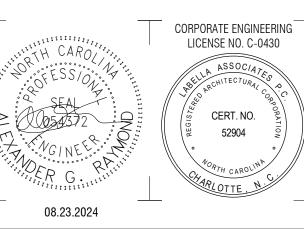
ELECTRICAL ROOF PLAN

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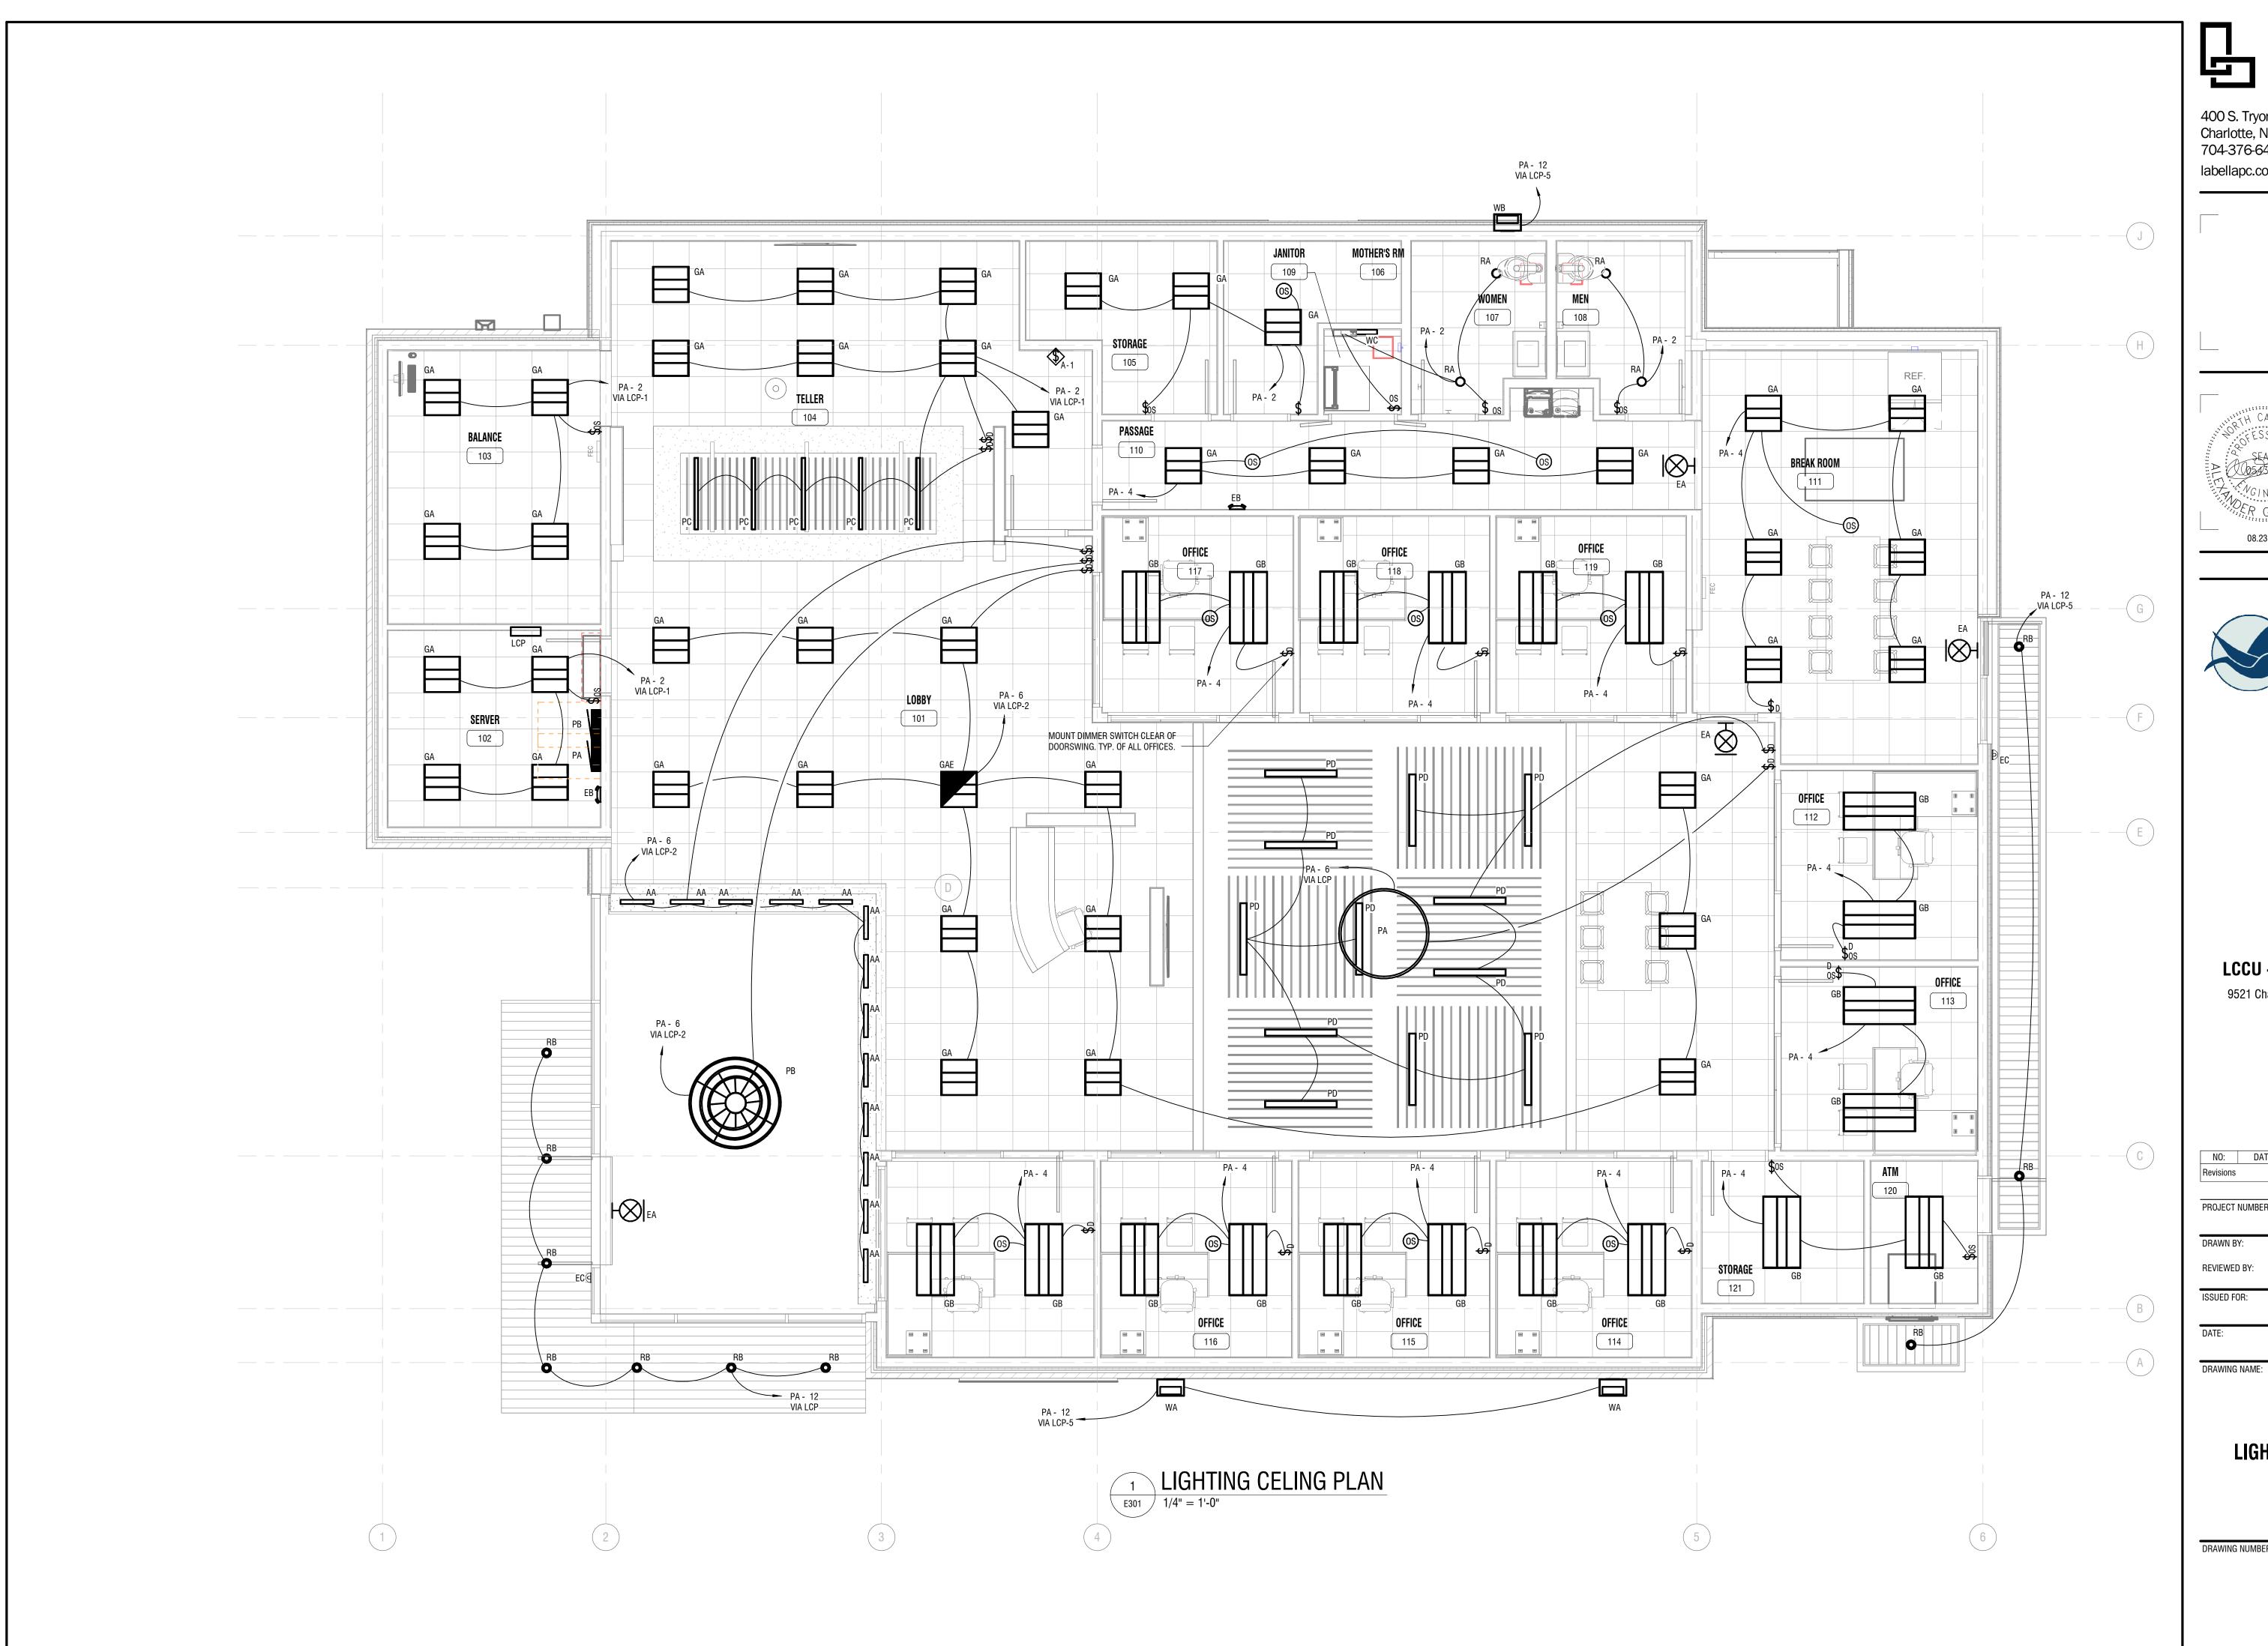
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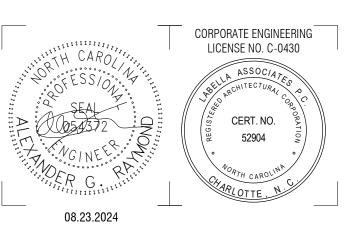
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SECURITY FLOOR PLAN

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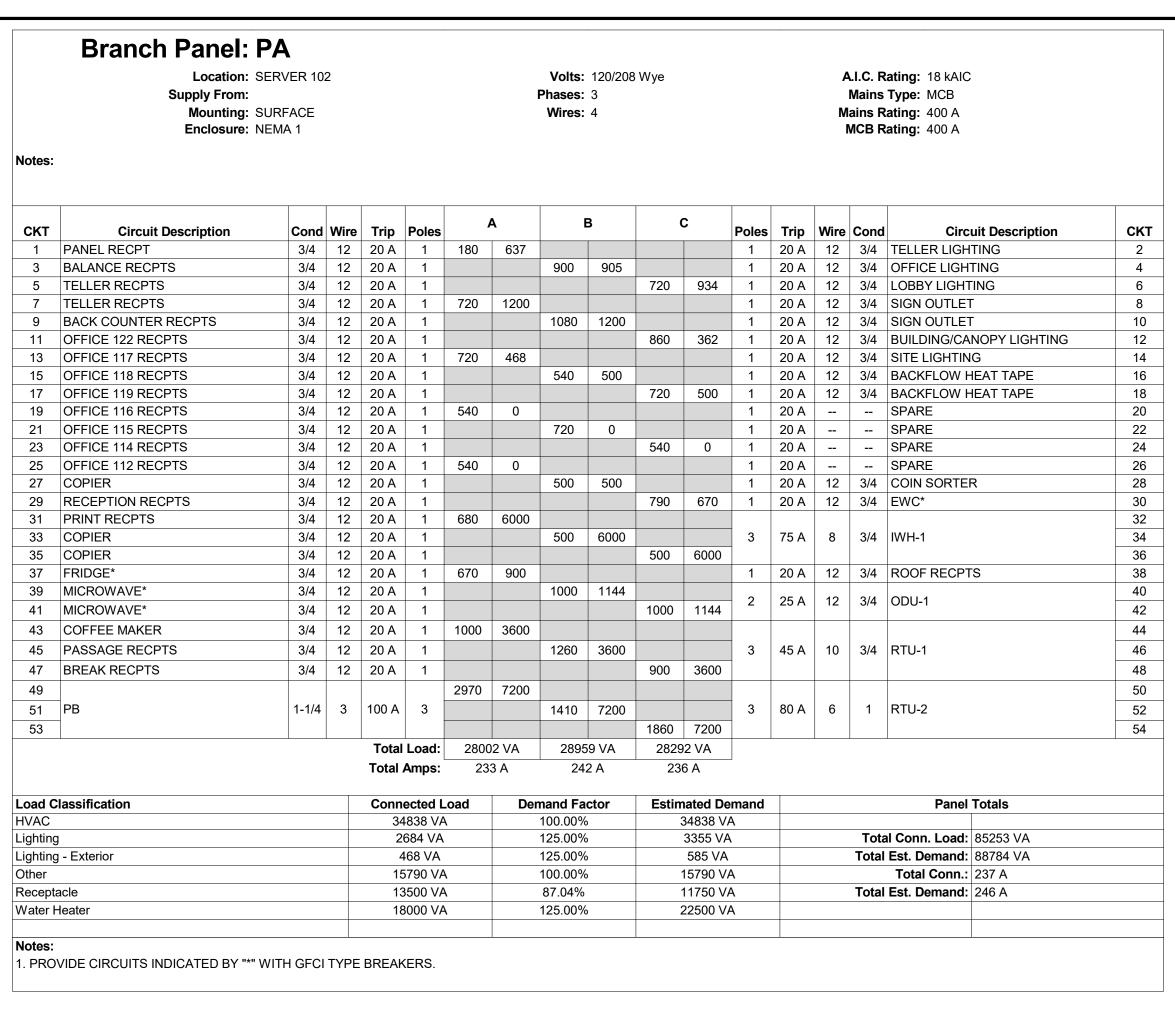


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LIGHTING CEILING PLAN

DRAWING NUMBER:



TYPICAL DEVICE WIRING DETAIL

CADWELD CONNECTION TO

STEEL (WERE AVAILABLE)

PÈR NEC 250.52(A)(2)

PER NEC 250.52(A)(1)

GROUNDING DETAIL

NEC 250.52(A)(5)

EFFECTIVELY GROUNDED BUILDING

GROUND CLAMP ON EFFECTIVELY

GROUNDED METALLIC WATER MAIN

5/8" X 10' COPPERCLAD GROUND RODS DRIVEN 6" BELOW FINISHED GRADE PER

#6 AWG BONDING CONDUCTORS FOR COMMUNICATIONS SYSTEMS

INTERSYSTEM BONDING

SERVICE DISCONNECT

LOCATED ADJACENT TO MAIN

(NEC CHAPTER 8)

SERVICE ENTRANCE

EQUIPMENT

NONMETALLIC PROTECTIVE SLEEVE

ELECTRODE PER NEC 250.52(A)(3), 20' OF 1/2" REBAR OR #4

BARE COPPER (MINIMUM)

#6 AWG

NEUTRAL BUS

(WHEN PROVIDED)

EQUIPMENT

GROUND BUS

BOND SERVICE

BOND GROUNDED **ELECTRODE & SERVICE**

CONDUITS

CONDUCTORS SIZED

REQUIRED ON ALL NEW

CONSTRUCTION; ON **EXISTING CONSTRUCTION**

WHERE ACCESSIBLE

(SEE NEC 250.50 Ex)


GROUNDING


PER NEC 250.66

(ALL FULL SIZE).

ELECTRODE

ENTRANCE ENCLOSURE

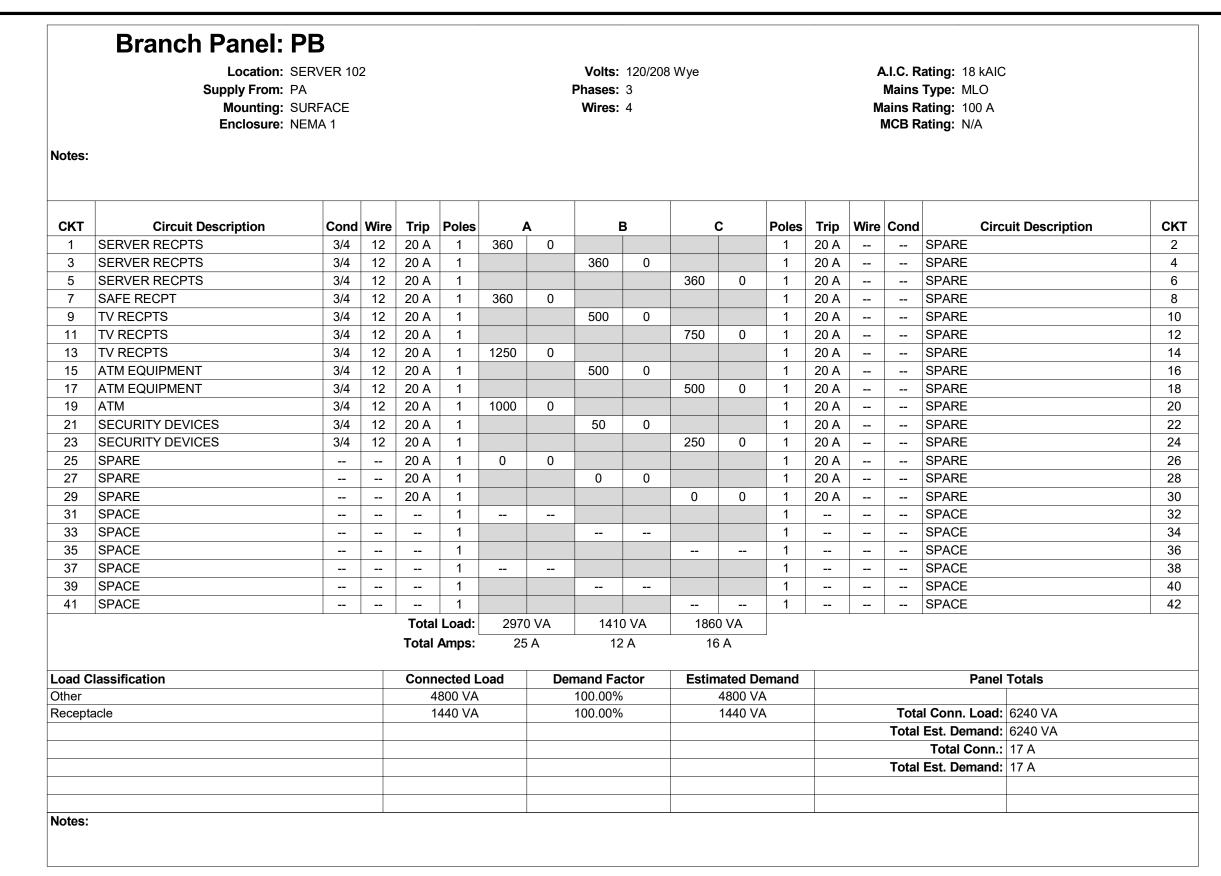

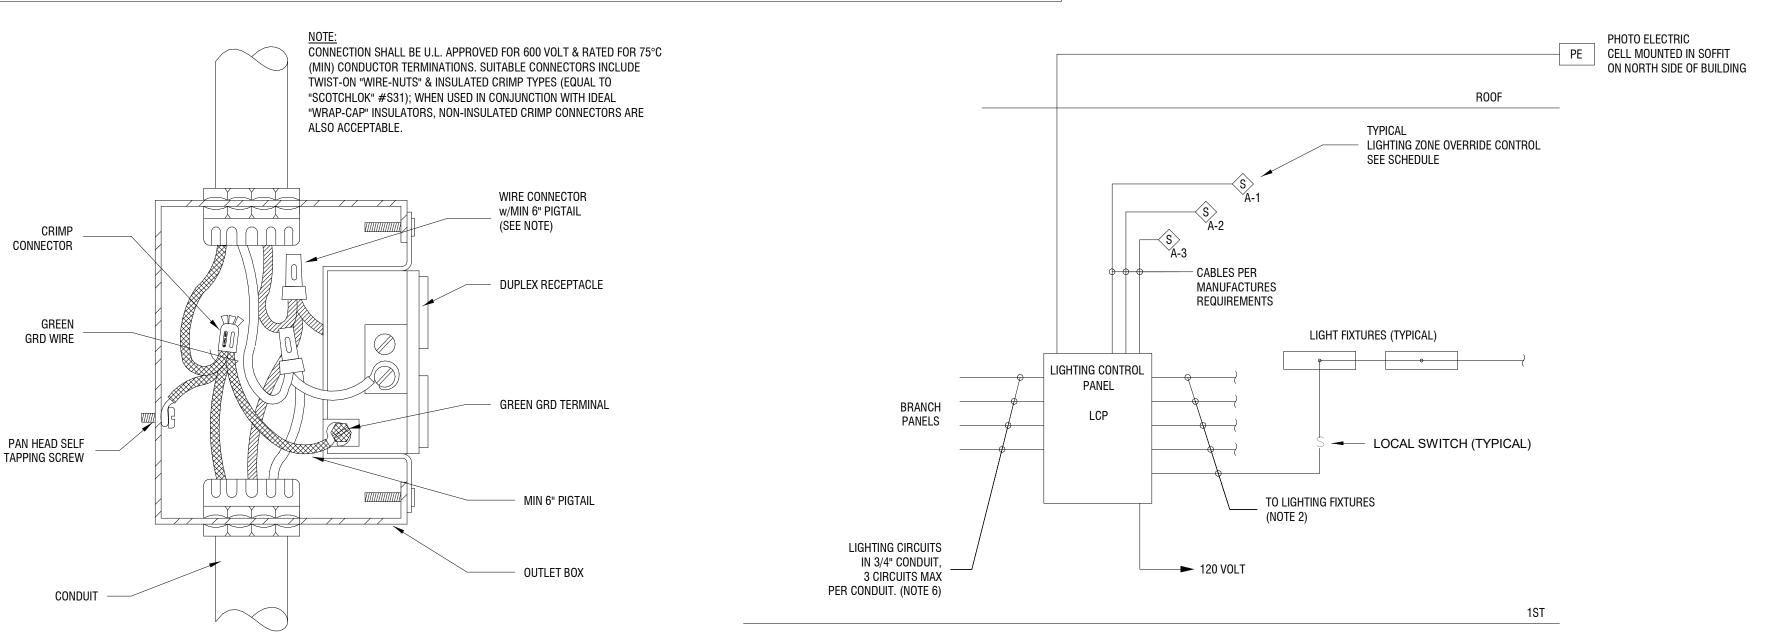

REQUIRMENTS WITH LOCAL

TO PAD MOUNT UTILITY XFMR.

PAD BY EC, COORDINATE EXACT C

LOCATION WITH LOCAL UTILITIY.


NOT TO SCALE

2(4#3/0,2"C)

		LCP			
RELAY #	CIRCUIT CONTROLLED	CONTROL	VOLTAGE	AREA	\$
1	PA-2	TIMECLOCK ON/OFF	120	TELLER	A-
2	PA-6	TIMECLOCK ON/OFF	120	LOBBY	A-
3	PA-8	PHOTOCELL ON/TIMECLOCK OFF	120	SIGN	
4	PA-10	PHOTOCELL ON/TIMECLOCK OFF	120	SIGN	
5	PA-12	PHOTOCELL ON/TIMECLOCK OFF	120	BUILDING LIGHTING	
6	PA-14	PHOTOCELL ON/TIMECLOCK OFF	120	PARKING LIGHTING	
7	SPARE		120		
8	SPARE		120		


NOTES:

- 1. LIGHTING CONTROL SYSTEM SHALL HAVE MINIMUM 8 INDIVIDUALLY PROGRAMMABLE RELAYS, RJ45 INTERFACE, DAYLIGHT SAVINGS TIME ADJUSTMENT, ASTRONOMICAL CLOCK AND BE UL LISTED (508 AND 916). PROVIDE "XPS" SYSTEM (BY LUTRON), "1LC" SYSTEM (BY LEVITON) OR EQUIVALENT AND EQUAL SYSTEM (BY WATT STOPPER) INTERIOR LIGHTING FIXTURES POWERED THROUGH LIGHTING CONTROL CENTER SHALL BE TURNED ON IN THE MORNING AND SWEPT OFF AT A TIME DETERMINED BY OWNER/TENANT AT NIGHT. PROVIDE MOMENTARY OVERRIDE SWITCH(ES) WHERE INDICATED FOR CORRIDOR LIGHTING OVERRIDE. THE OVERRIDE SWITCH(ES) SHALL PROVIDE NO MORE THAN 2 HOURS OF ADDITIONAL LIGHTING. PROVIDE ENGRAVED NAMEPLATE ABOVE EACH SWITCH THAT READS "LIGHTING OVERRIDE". SWITCH AND PLATE COLOR SHALL MATCH OTHER DEVICES.
- 3. INSTALLATION SHALL BE IN ACCORDANCE WITH THE MANUFACTURER'S RECOMMENDATIONS. PROVIDE ALL PANELS, RELAYS, ACCESSORIES, CONDUIT, CONDUCTORS,

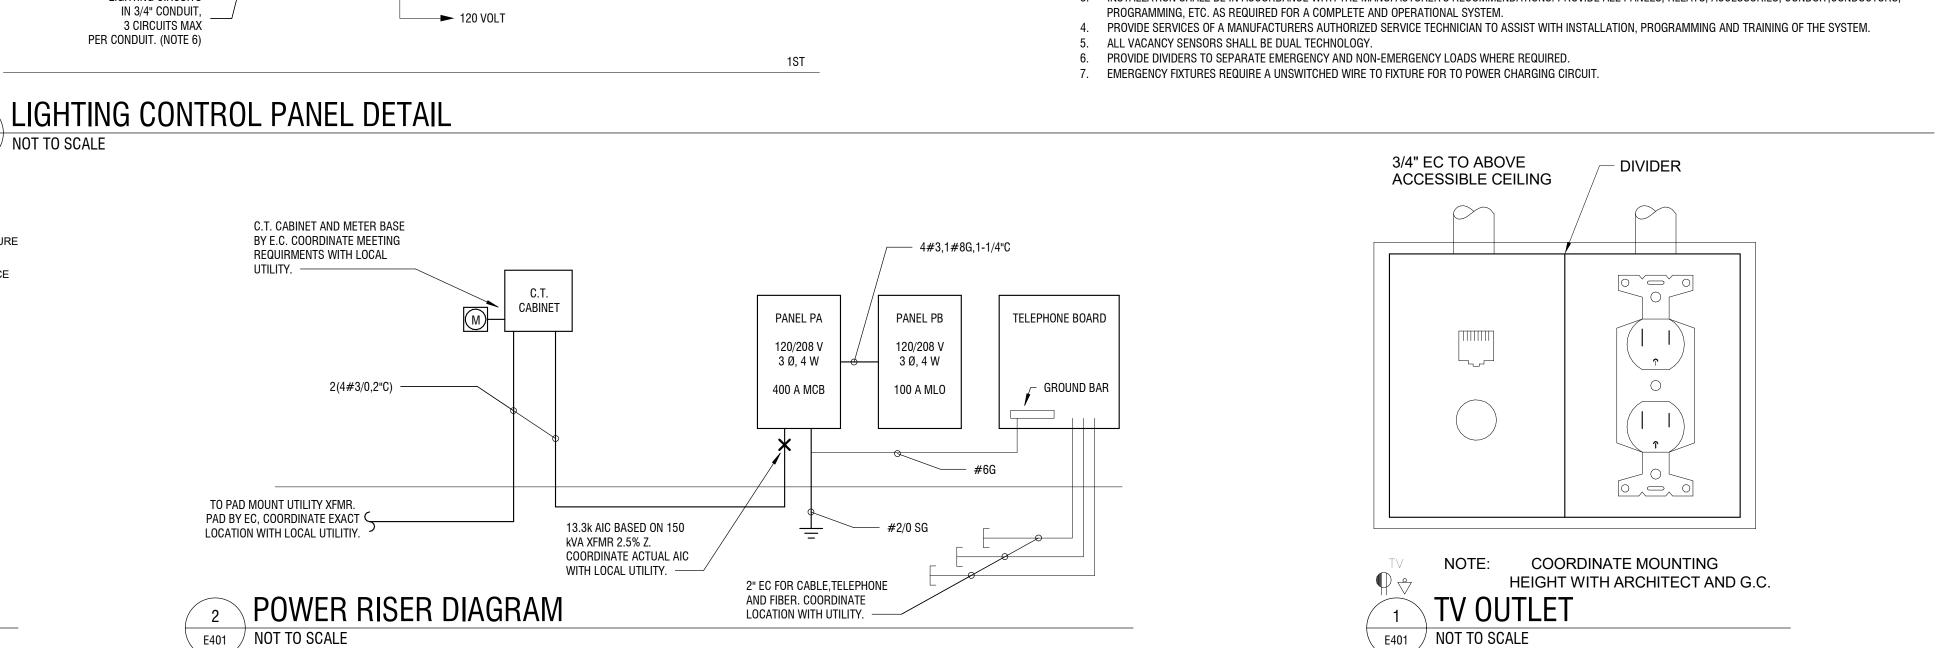



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ELECTRICAL DETAILS AND RISER DIAGRAM

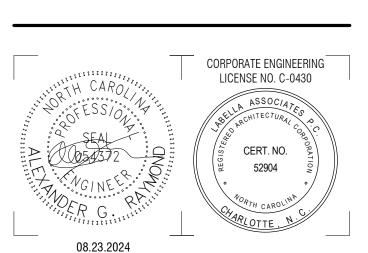DRAWING NUMBER: