## **BID DOCUMENTS FOR:**

# ESTES HILLS ELEMENTARY SCHOOL ADA IMPROVEMENTS

CHAPEL HILL, ORANGE COUNTY, NORTH CAROLINA **PIN:** 9789655711



VICINITY MAP			
		SCALE 1"=150'	
	0	150'	300'

**CIVIL ENGINEER: TIMMONS GROUP** 5410 TRINITY ROAD, STE. 102 RALEIGH, NC 27607 BLAKE HALL, PLA, PE (919) 866-4933 blake.hall@timmons.com

OWNER: CHAPEL HILL CARRBORO SCHOOLS 750 SOUTH METTITT MILL RD **CHAPEL HILL, NC 27516 ANDRE STEWART** (919-967-8211) adstewart@chccs.k12.nc..us

SHEET LIST TABLE				
SHEET NUMBER	SHEET TITLE			
C0.0	COVER SHEET			
C1.0	EXISTING CONDITION & DEMOLITION PLAN			
C2.0	SITE LAYOUT AND GRADING PLAN			
C3.0	NOTES & DETAILS			
C3.1	NOTES & DETAILS			

SITE DATA TABLE			
PROJECT NAME:	ESTES HILLS ELEMENTARY SCHOOL		
PHYSICAL ADDRESS:	500 NORTH ESTES DRIVE, CHAPEL HILL, 27514		
TOWNSHIP:	CHAPEL HILL		
PROPERTY ZONING:	R-1		
EXISTING USE:	INSTITUTIONAL		
PROPOSED USE:	INSTITUTIONAL		
TOTAL AREA:	32.85 ACRES		
DISTURBED AREA:	11,873 SQ-FT (0.27 AC)		
RIVER BASIN:	CAPE FEAR		
SURFACE WATER CLASSIFICATION:	NSW		
WATERSHED:	HAW		




S. FANTAYE

55668

C0.0



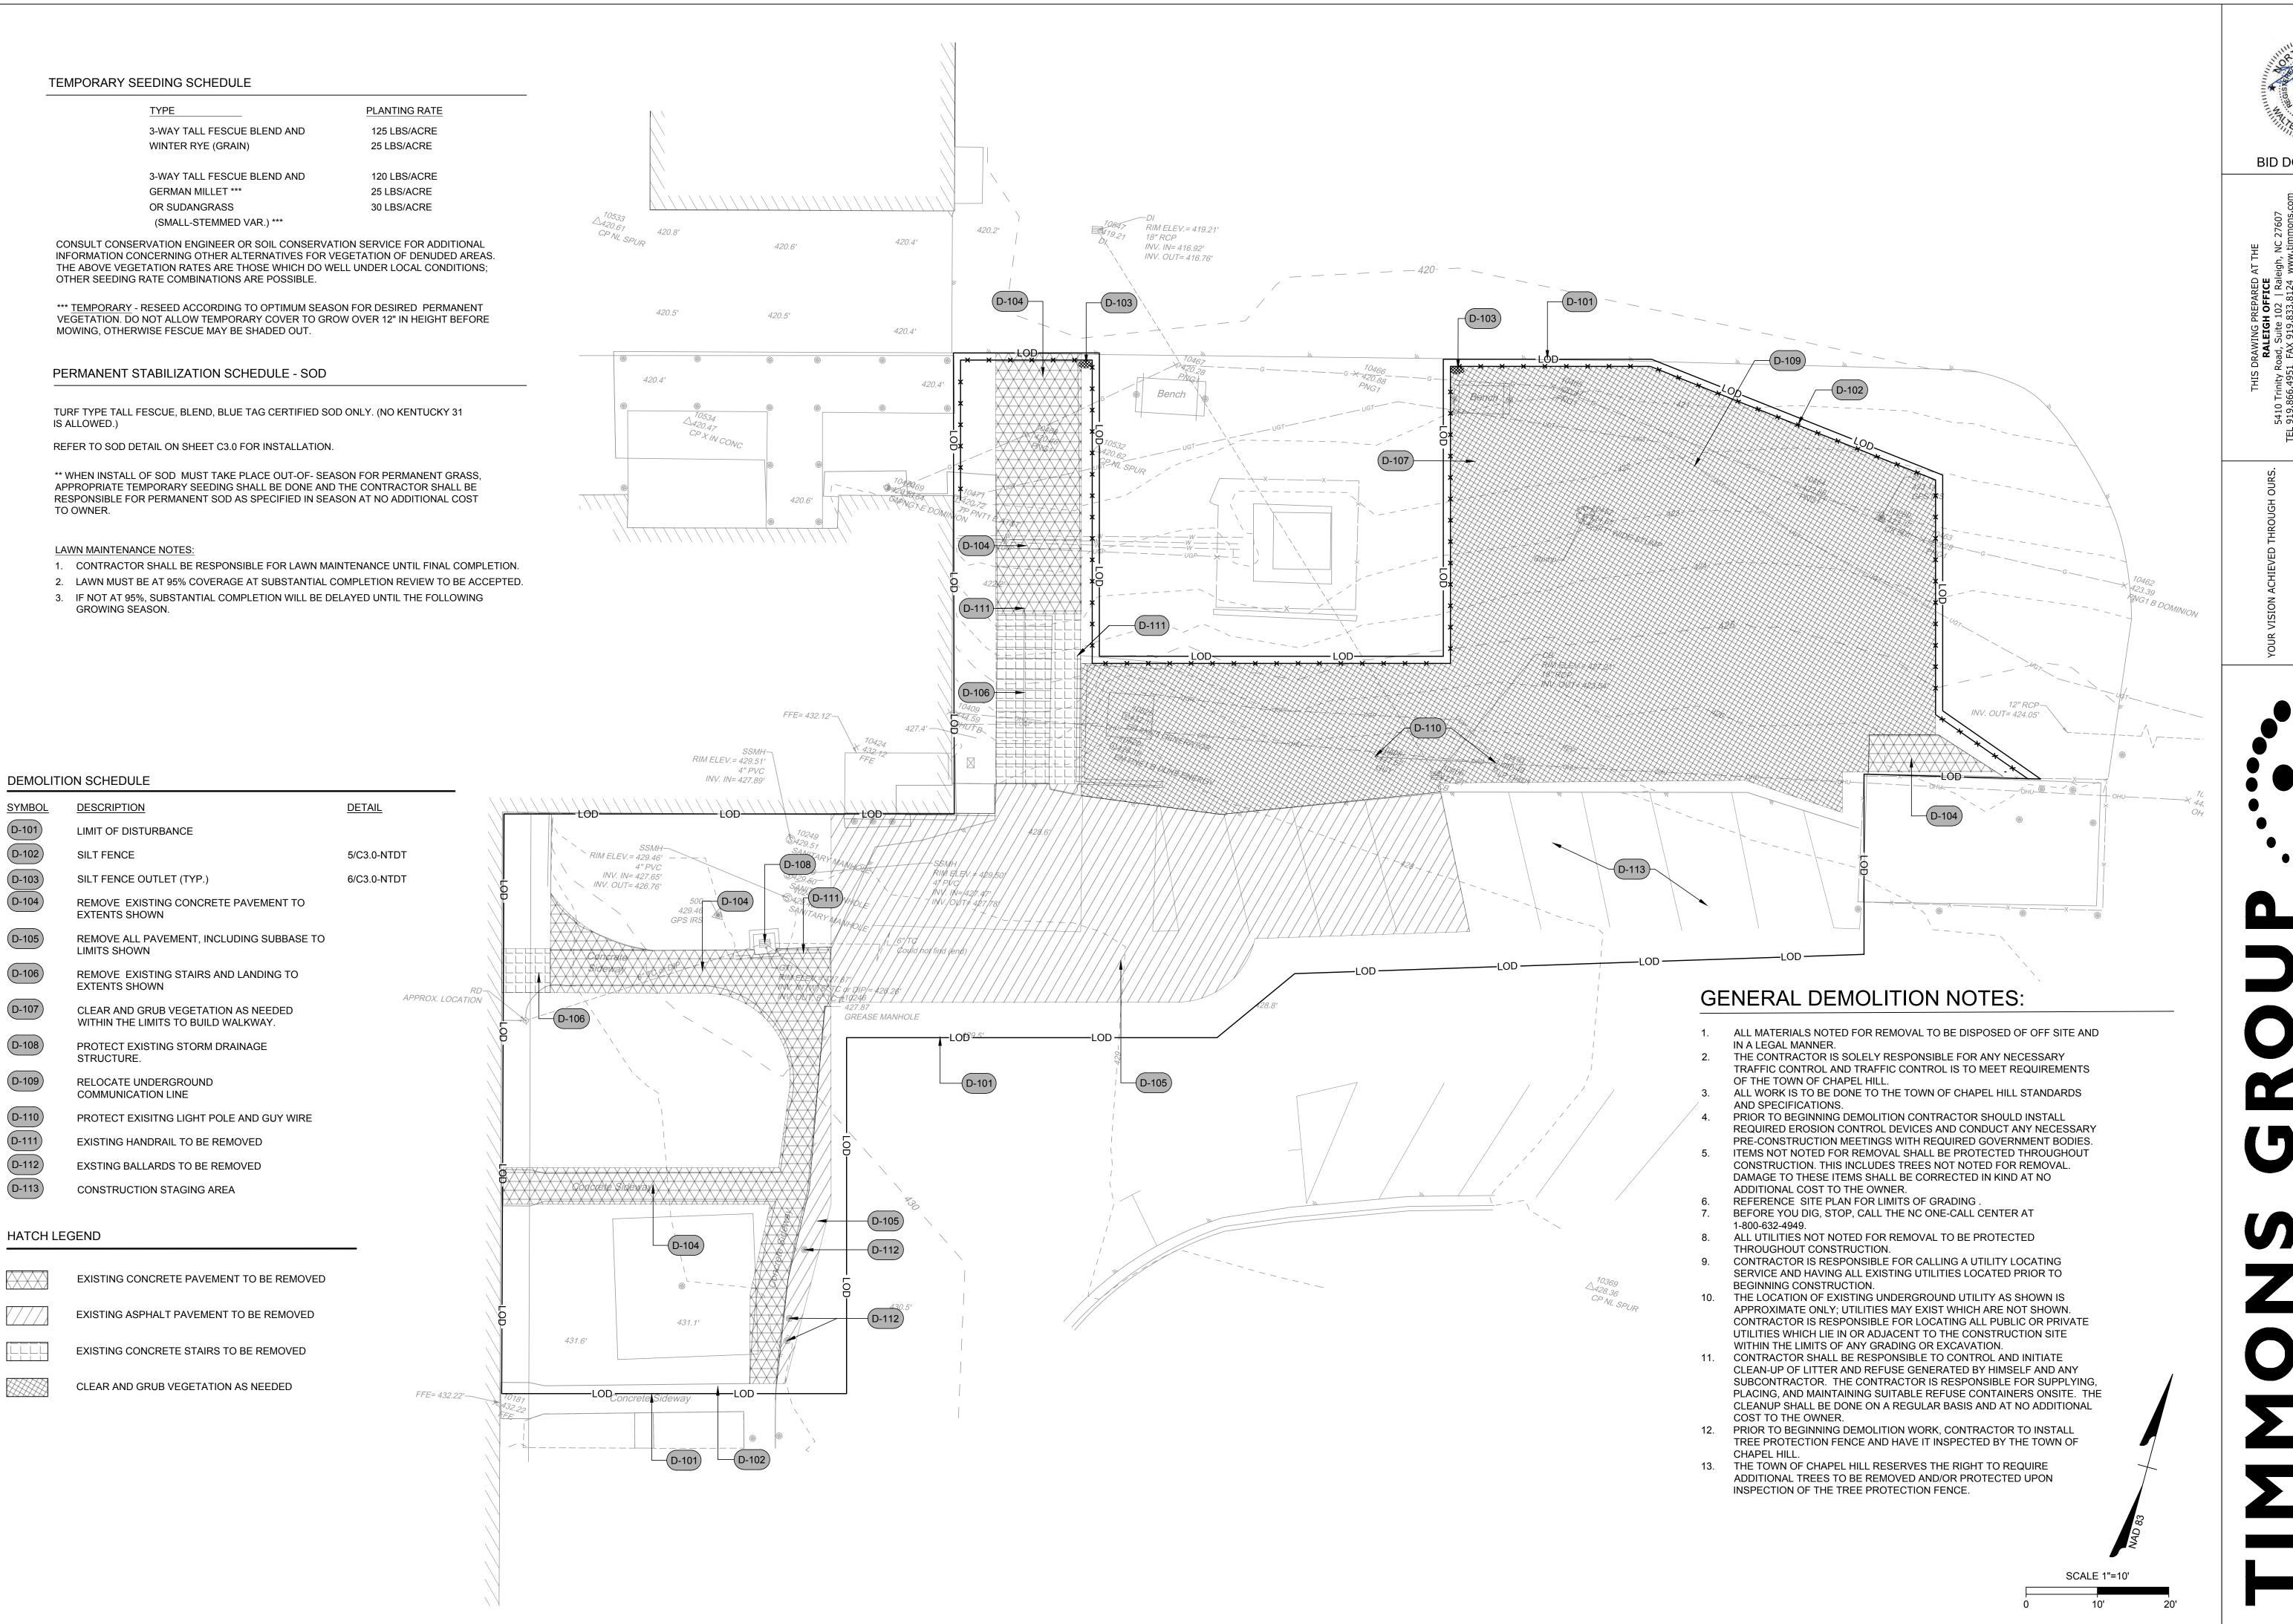

BID DOCUMENTS

6/1/2023 DRAWN BY

S. FANTAYE DESIGNED BY S. FANTAYE CHECKED BY


B. HALL SCALE AS SHOWN

IMPROVEM  $\overline{\forall}$ 


HOOL

H

JOB NO. 55668 SHEET NO. C-1.0

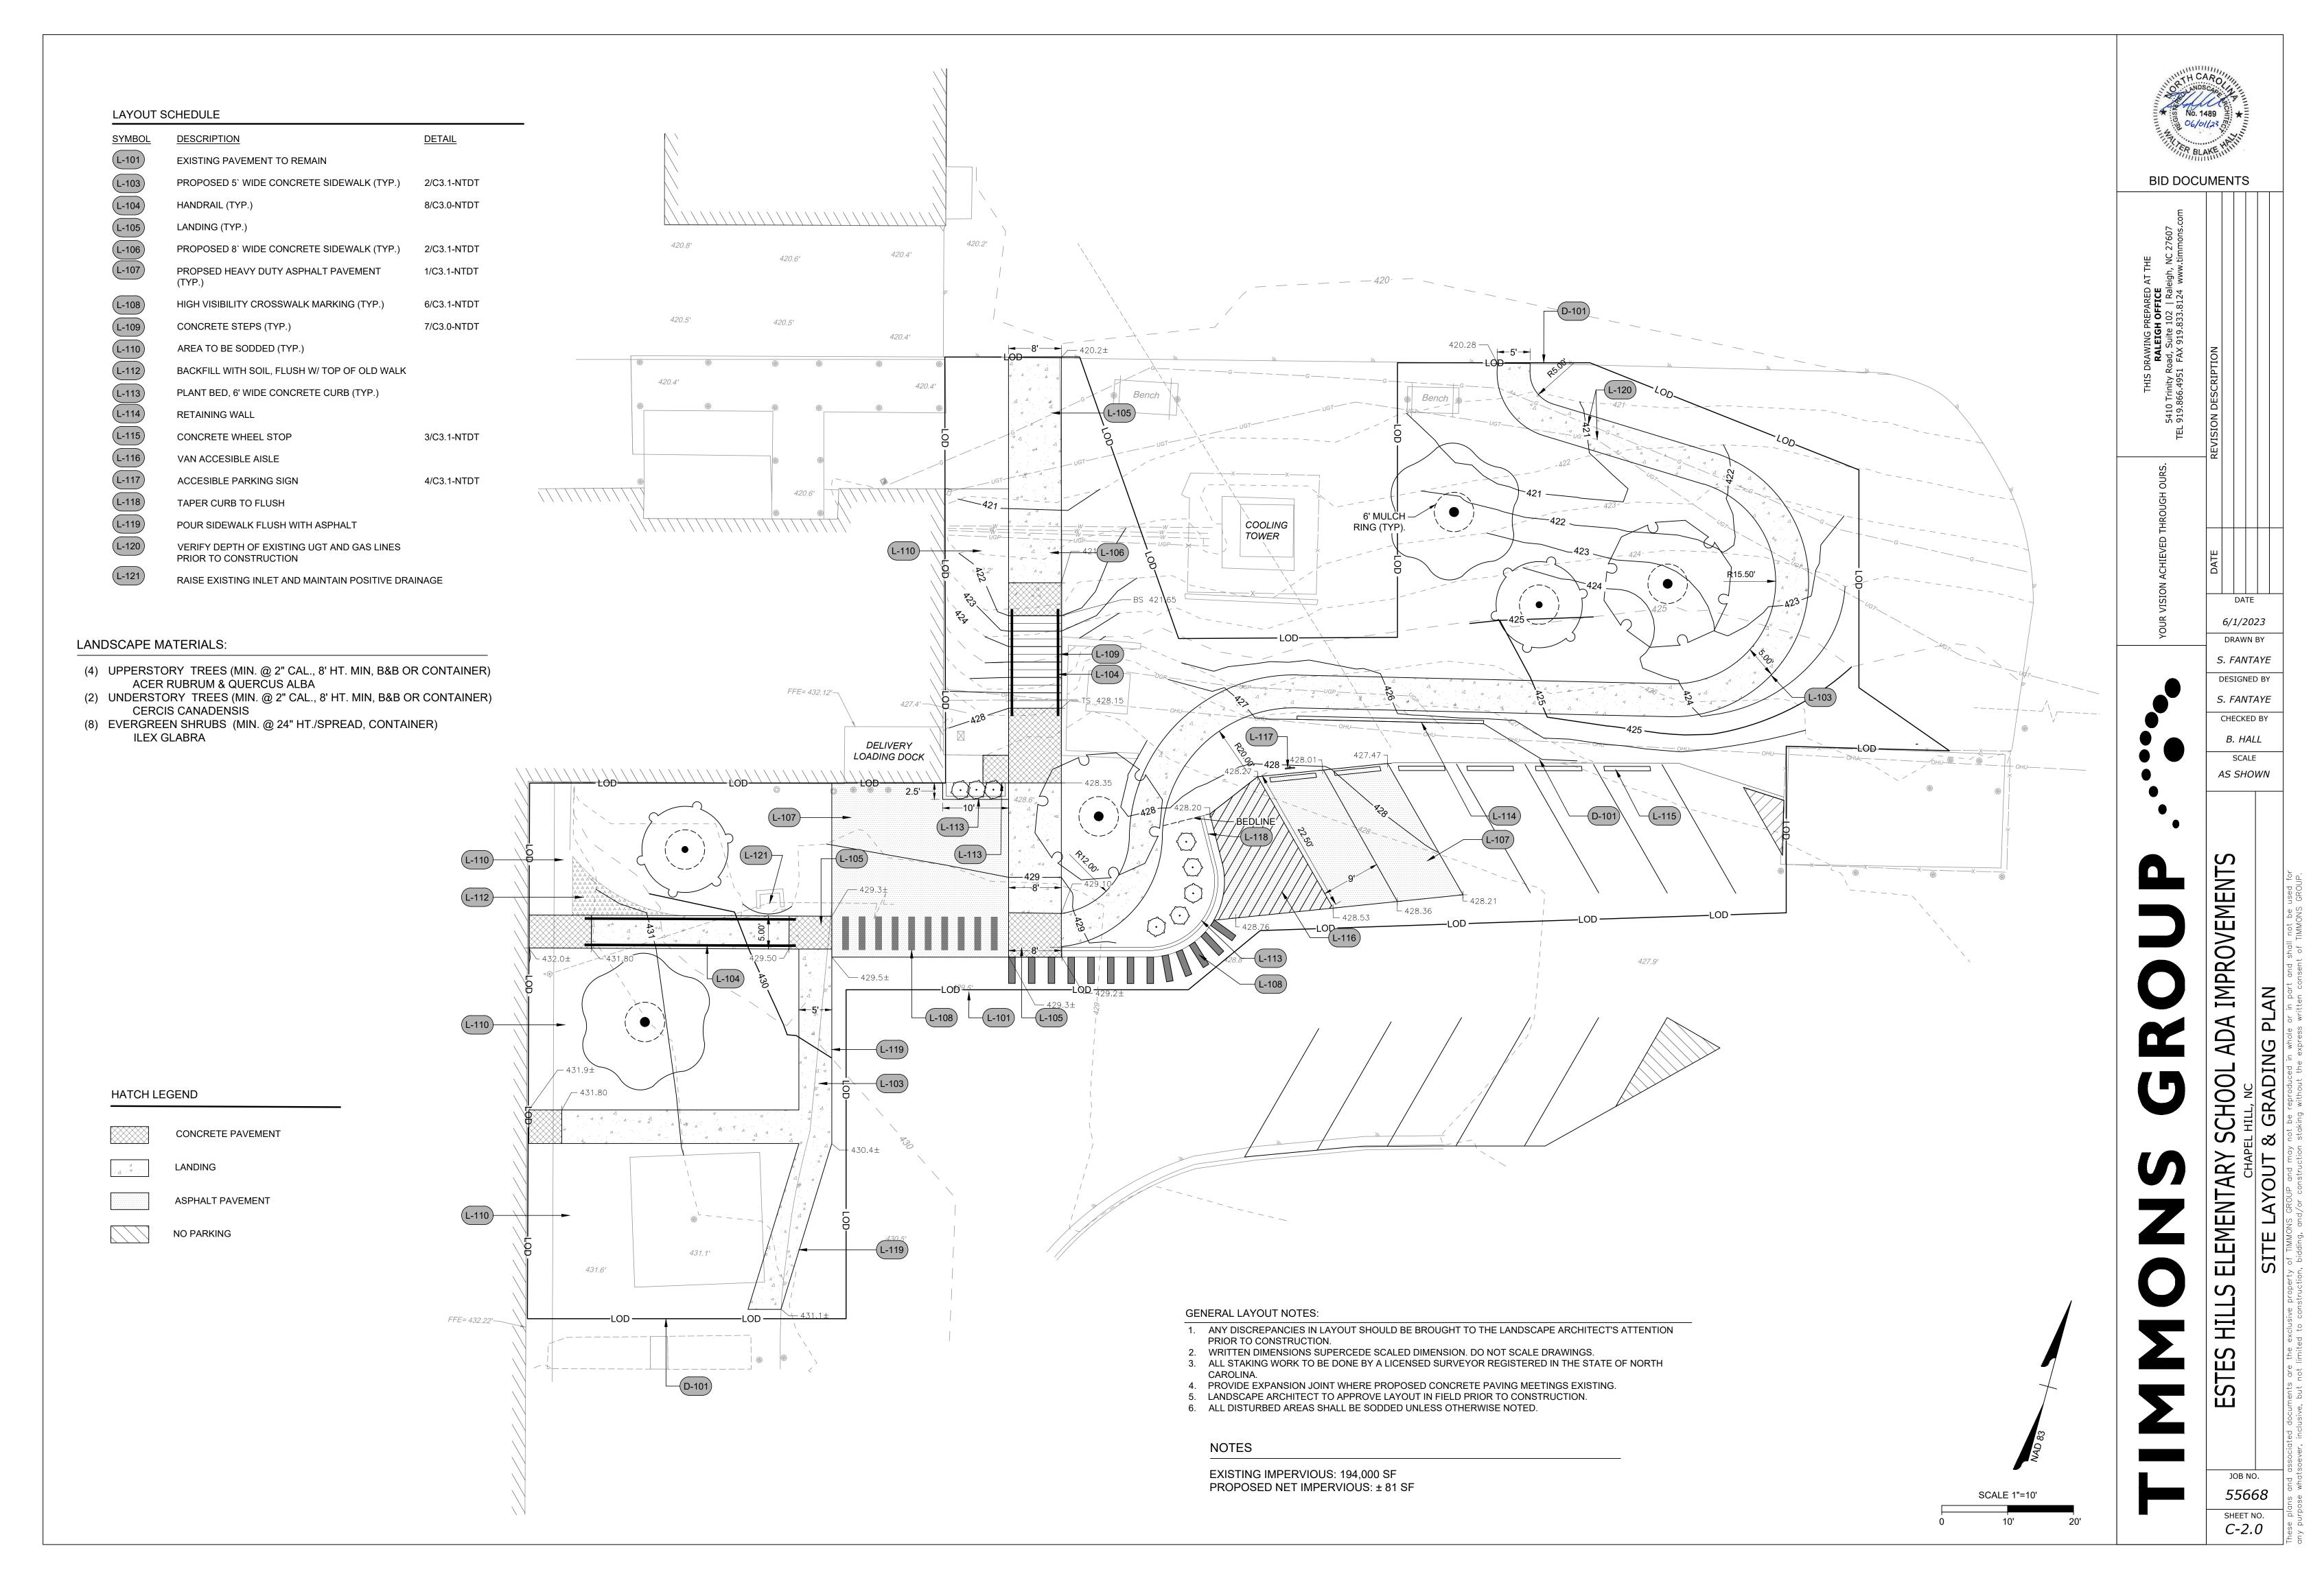


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65-70% NATIVE TOPSOIL 30-35% ORGANIC COMPOST MIXED THOROUGHLY TO MEDIUM TEXTURE - TURN SUBBASE TO BREAK UP COMPACTION AT DEPTH OF 4"-6" SUBBASE; SCARIFY SURFACE

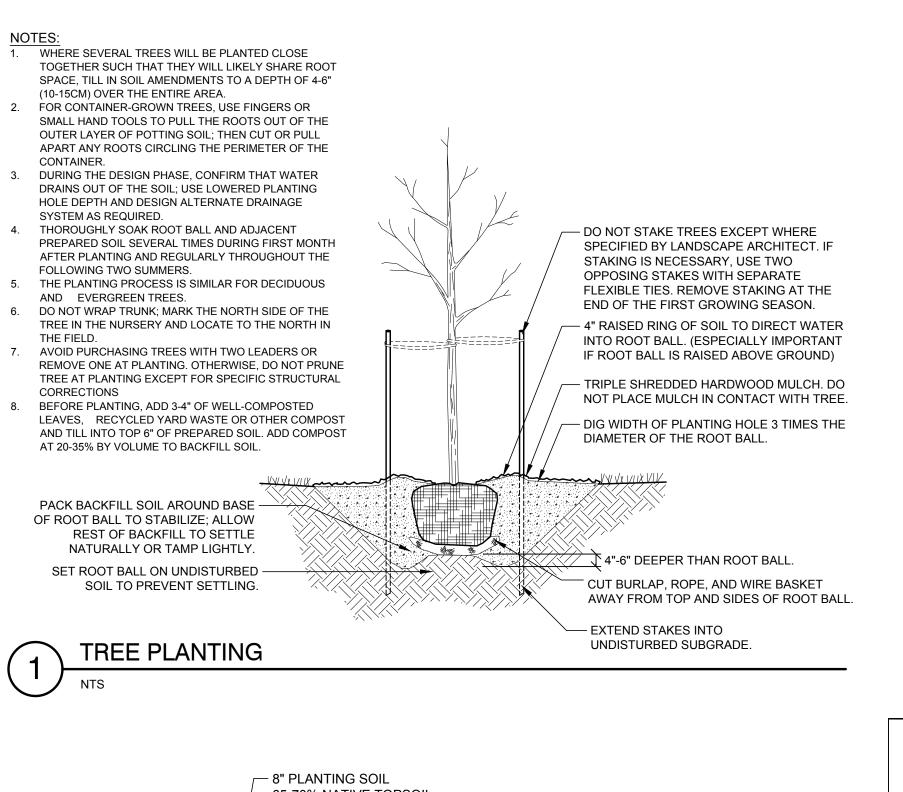- . All material to be free of toxic substances, weed seed, stones, sticks or other material
- harmful to plant growth. Topsoil: ph range of 6.0 to 7.0, min. 6% organic matter. 2. Compost: well-composted, stable, weed-free organic matter, ph range of 5.5 to 8.
- 3. Submit soil sample for analysis ... provide amendments per recommendations.
- 4. Remove any debris, rocks, or clumps 2" or larger. 5. Do not spread if planting soil, topsoil or subgrade is frozen, muddy, or excessively wet.






(2) 1/2" DIA. SLIP DOWELLS; CENTER WITHIN — THICKNESS OF CONRETE; SPACED EVENLY (TYP.)

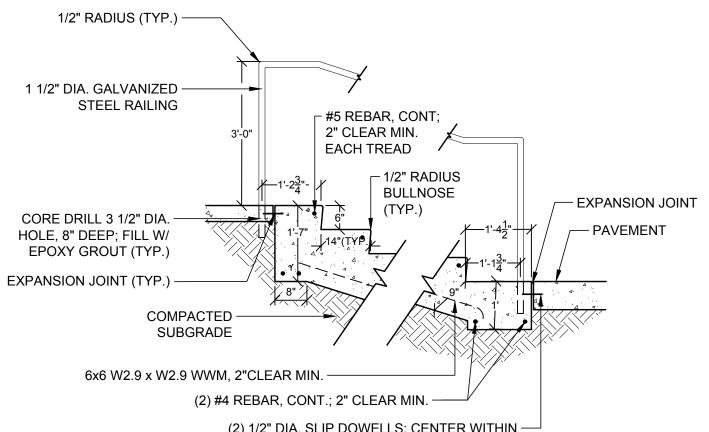- Stairs to be concrete; 3,000 psi @ 28 days.
- 2. Treads to be sloped 1% to ensure positive drainage.
- 3. See plan for number of risers. 4. Refer to plans for number of treads
- CONCRETE STAIR W/ HANDRAIL (6"R / 12"T)

PRUNE AND THIN DECIDUOUS SHRUBS APPROX. 1/2 OF INITIAL BRANCHES TO COMPENSATE FOR LOSS OF ROOTS WHILE DIGGING. FOLLOWING PRUNING PLANT SHALL MEET SPECIFIED SIZE. - 3" MULCH MIN. PER SPECS - 4" EARTH BERM TO FORM SAUCER REMOVE ALL METAL/PLASTIC CONT PRIOR TO PLANTING. SLICE FIBER ROOTS IN THREE PLACES TO ALLOW ROOT GROWTH. LOOSEN BURLAP AT STEM/ALLOW IT TO REMAIN ON BALL. - TAMPS OR WATER TOPSOIL MIXTURE AT 6" INTERVALS


- SOIL MIX: 1/3 ORGANIC MATTER, 2/3 EXIST SOIL. WIDTH OF PLANT PIT: SANDY SOIL, 24" WIDER THAN PLANT BALL; CLAY SOIL, 12" WIDER THAN PLANT BALL
- 3. FOR PLANTING AREAS WHERE SOIL HAS BEEN COM-PACTED BY EQUIP. CONTACT
- LA PRIOR TO PLANTING. 4. FOR CAMELLIAS, RHODOS, AZALEAS, AND LAURELS: SOIL MIX, 2/3 ORGANIC AND
- 5. SHRUB SHALL BEAR SAME RELATIONSHIP TO GRADE AS IT DID PRIOR TO DIGGING.



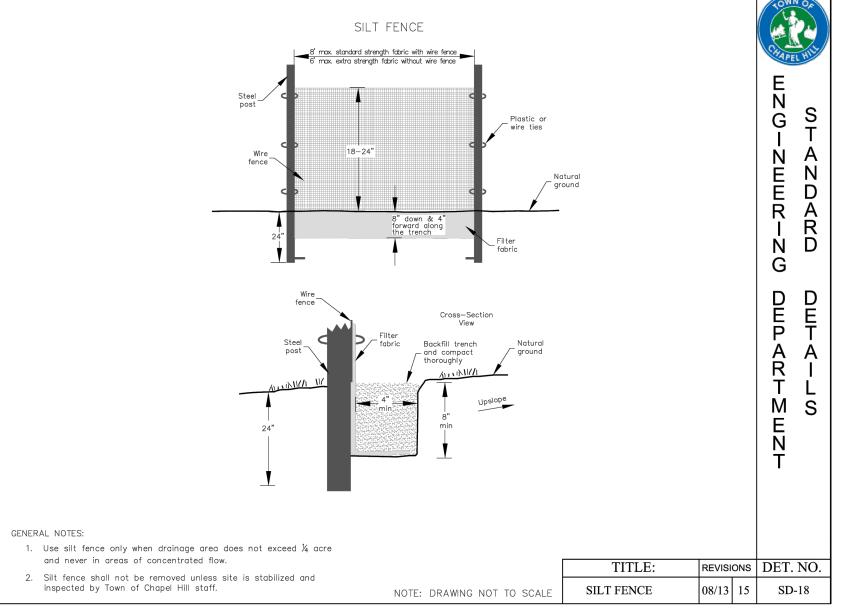

SILT FENCE

NTS

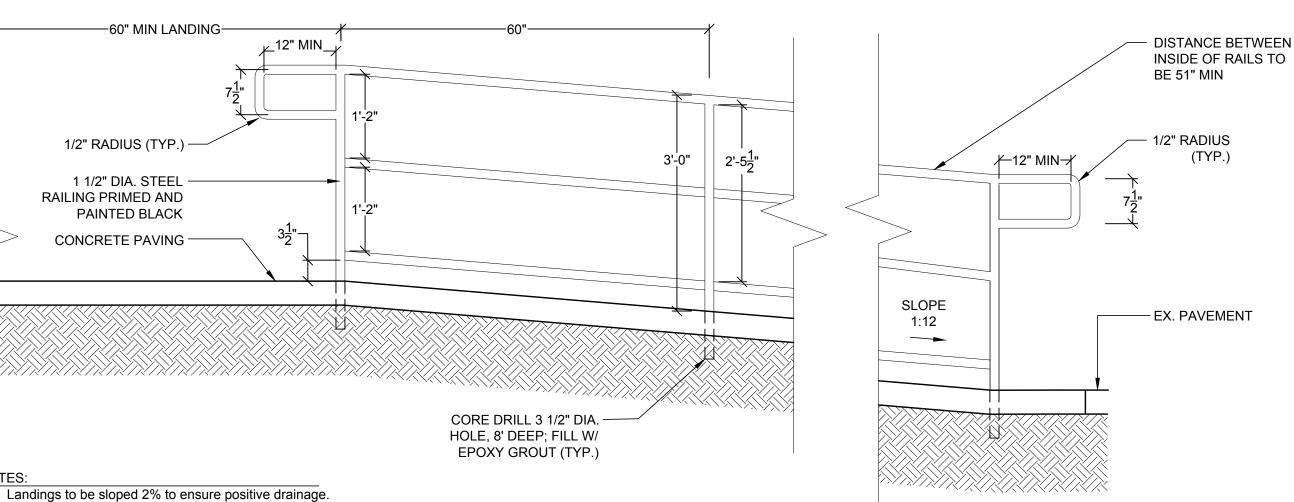


Landings to be sloped 2% to ensure positive drainage. 2. Landings not to exceed 2% in any direction.

3. Handrail to be primed and painted black.

- PLANTING SOIL, PER NOTES - BREAK THROUGH & REMOVE ALL "HARDPAN" & DEBRIS TO ALLOW PERCOLATION & POSITIVE DRAINAGE SCARIFIED SUBGRADE — SOD PER SPECS. —— PAVEMENT (TYP.)

- . All sod shall be from a certified grower and be 99% weed free.
- 2. The sod shall not be shipped until the site is substantially prepared. It shall be stored and maintained in accordance with the American Nursery Association.
- 3. The general contractor will provide grades to within an inch of proposed final grades.
- 4. Planting soil to a minimum depth of 6" (4" uncompacted in situ soil and 2" soil conditioner, such as
- pine fines or organic compost, thoroughly mixed; or 6" native topsoil), hand-rake smooth. 5. Add additives (per soil test analysis) & blend.
- 6. Water area to be sodded prior to laying sod. 7. Lay & roll sod, ensuring no gaps; stagger seams; water thoroughly.

## SOD INSTALLATION DETAIL

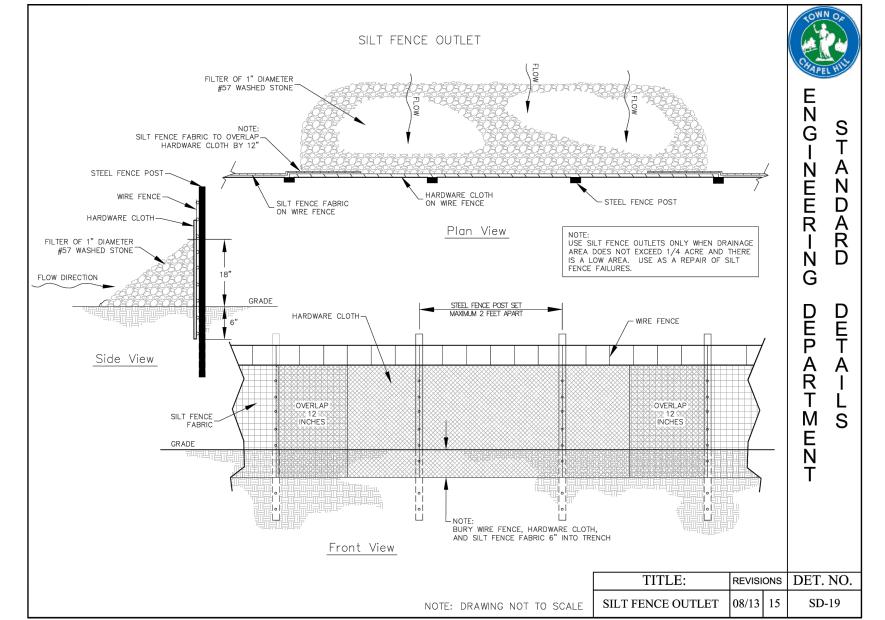

SILT FENCE OUTLET

P-PA-RAL-07

IMPROVEMENT **EMENTARY** 

BID DOCUMENTS

DATE

6/1/2023

DRAWN BY

S. FANTAYE

DESIGNED BY

S. FANTAYE


CHECKED BY

B. HALL

SCALE

AS SHOWN


55668 SHEET NO. C3.0

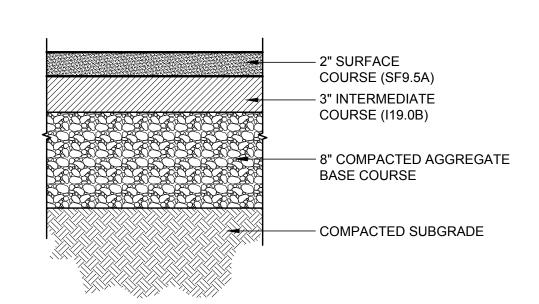

### **ASPHALT PAVING (HEAVY DUTY)**

9" x 1'-0" x .080 STD. ALUM. SIGN TO READ "VAN ACCESSIBLE" BOLT TO LEGEND AND BORDER: POST W/ 3/8" CANDIUM PLATED — GREEN BACKGROUND: NUTS, BOLTS & WASHERS WHITE 1'6" x 1'-0" x .080 STD. ALUM. ACCESSIBLE PARKING SIGN TO READ "RESERVED PARKING" WITH -IDENTIFICATION SYMBOL. BOLT TO POST W/ 3/8" CANDIUM PLATED RESERVED NUTS, BOLTS & WASHERS 9" x1'-0" x.080 STD. ALUM. SIGN TO READ "MAXIMUM PENALTY \$100, GS 20-37.6". BOLT TO POST W/ 3/8" CANDIUM PLATED -COLORS: NUTS, BOLTS & WASHERS LEGEND AND BORDER: GREEN SYMBOL: WHITE ON BLUE GALVANIZED METAL. BACKGROUND CHANNEL POST BACKGROUND: WHITE FINISHED GRADE MAXIMUM -- PENALTY \$250  $R1\frac{1}{2}$  LEGEND AND BORDER: GREEN BACKGROUND: WHITE


ACCESSIBLE PARKING SIGN - GALVANIZED POST

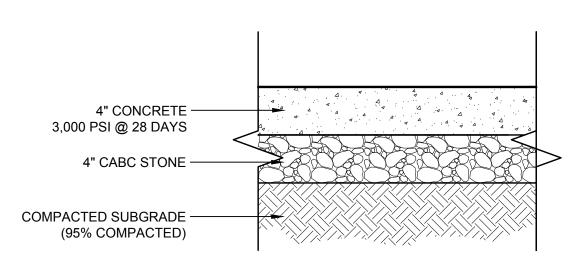

1) Cross slope as shown on grading plan. 2) Expansion joints every 30' or as shown on the plans. 3) Control joints every 5' or as shown on the layout plans

CONCRETE PAVING ON STONE (STANDARD DUTY)

4) Broom Finish

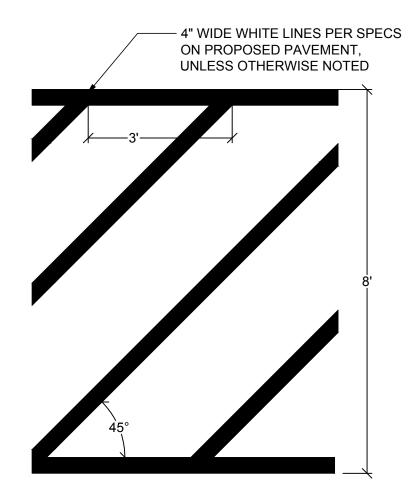

- 1. Transverse markings are 4 inches wide / 3ft spacing / 45 deg. angle. 2. A) All markings on asphalt pavement are to be pre-formed thermoplastic (installed per
- manufacturer's recommendations); unless otherwise noted
- B) All markings on concrete pavement are to be painted (min 2 coats), unless otherwise noted 3. All markings to conform to mutcd guidelines and/or ncdot standards

PAVEMENT MARKINGS


— PAVEMENT

— #3 REBAR. 18" LENGTH

OR APPROVED EQUAL

— PRECAST CONCRETE WHEEL STOP 6' LENGTH BY ADAMS PRODUCTS

**CONCRETE WHEEL STOP** 

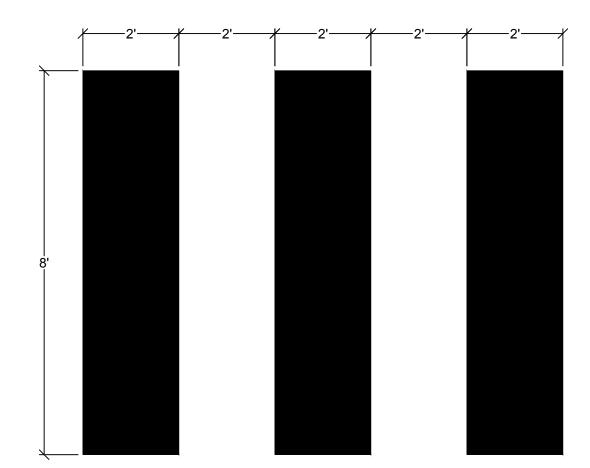

- 1. ALIGN TOP AND BOTTOM WITH BACK OF CURB.
- 2. PAINT CROSSWALK WITH 2 COATS OF REFLECTIVE WHITE PAINT.

HIGH VISIBILITY CROSSWALK

BID DOCUMENTS

DATE 6/1/2023

DRAWN BY S. FANTAYE DESIGNED BY S. FANTAYE CHECKED BY B. HALL

SCALE

AS SHOWN

IMPROVEMENT

ELEMENTARY

55668

SHEET NO. C3.1